

ATTACHMENT 4

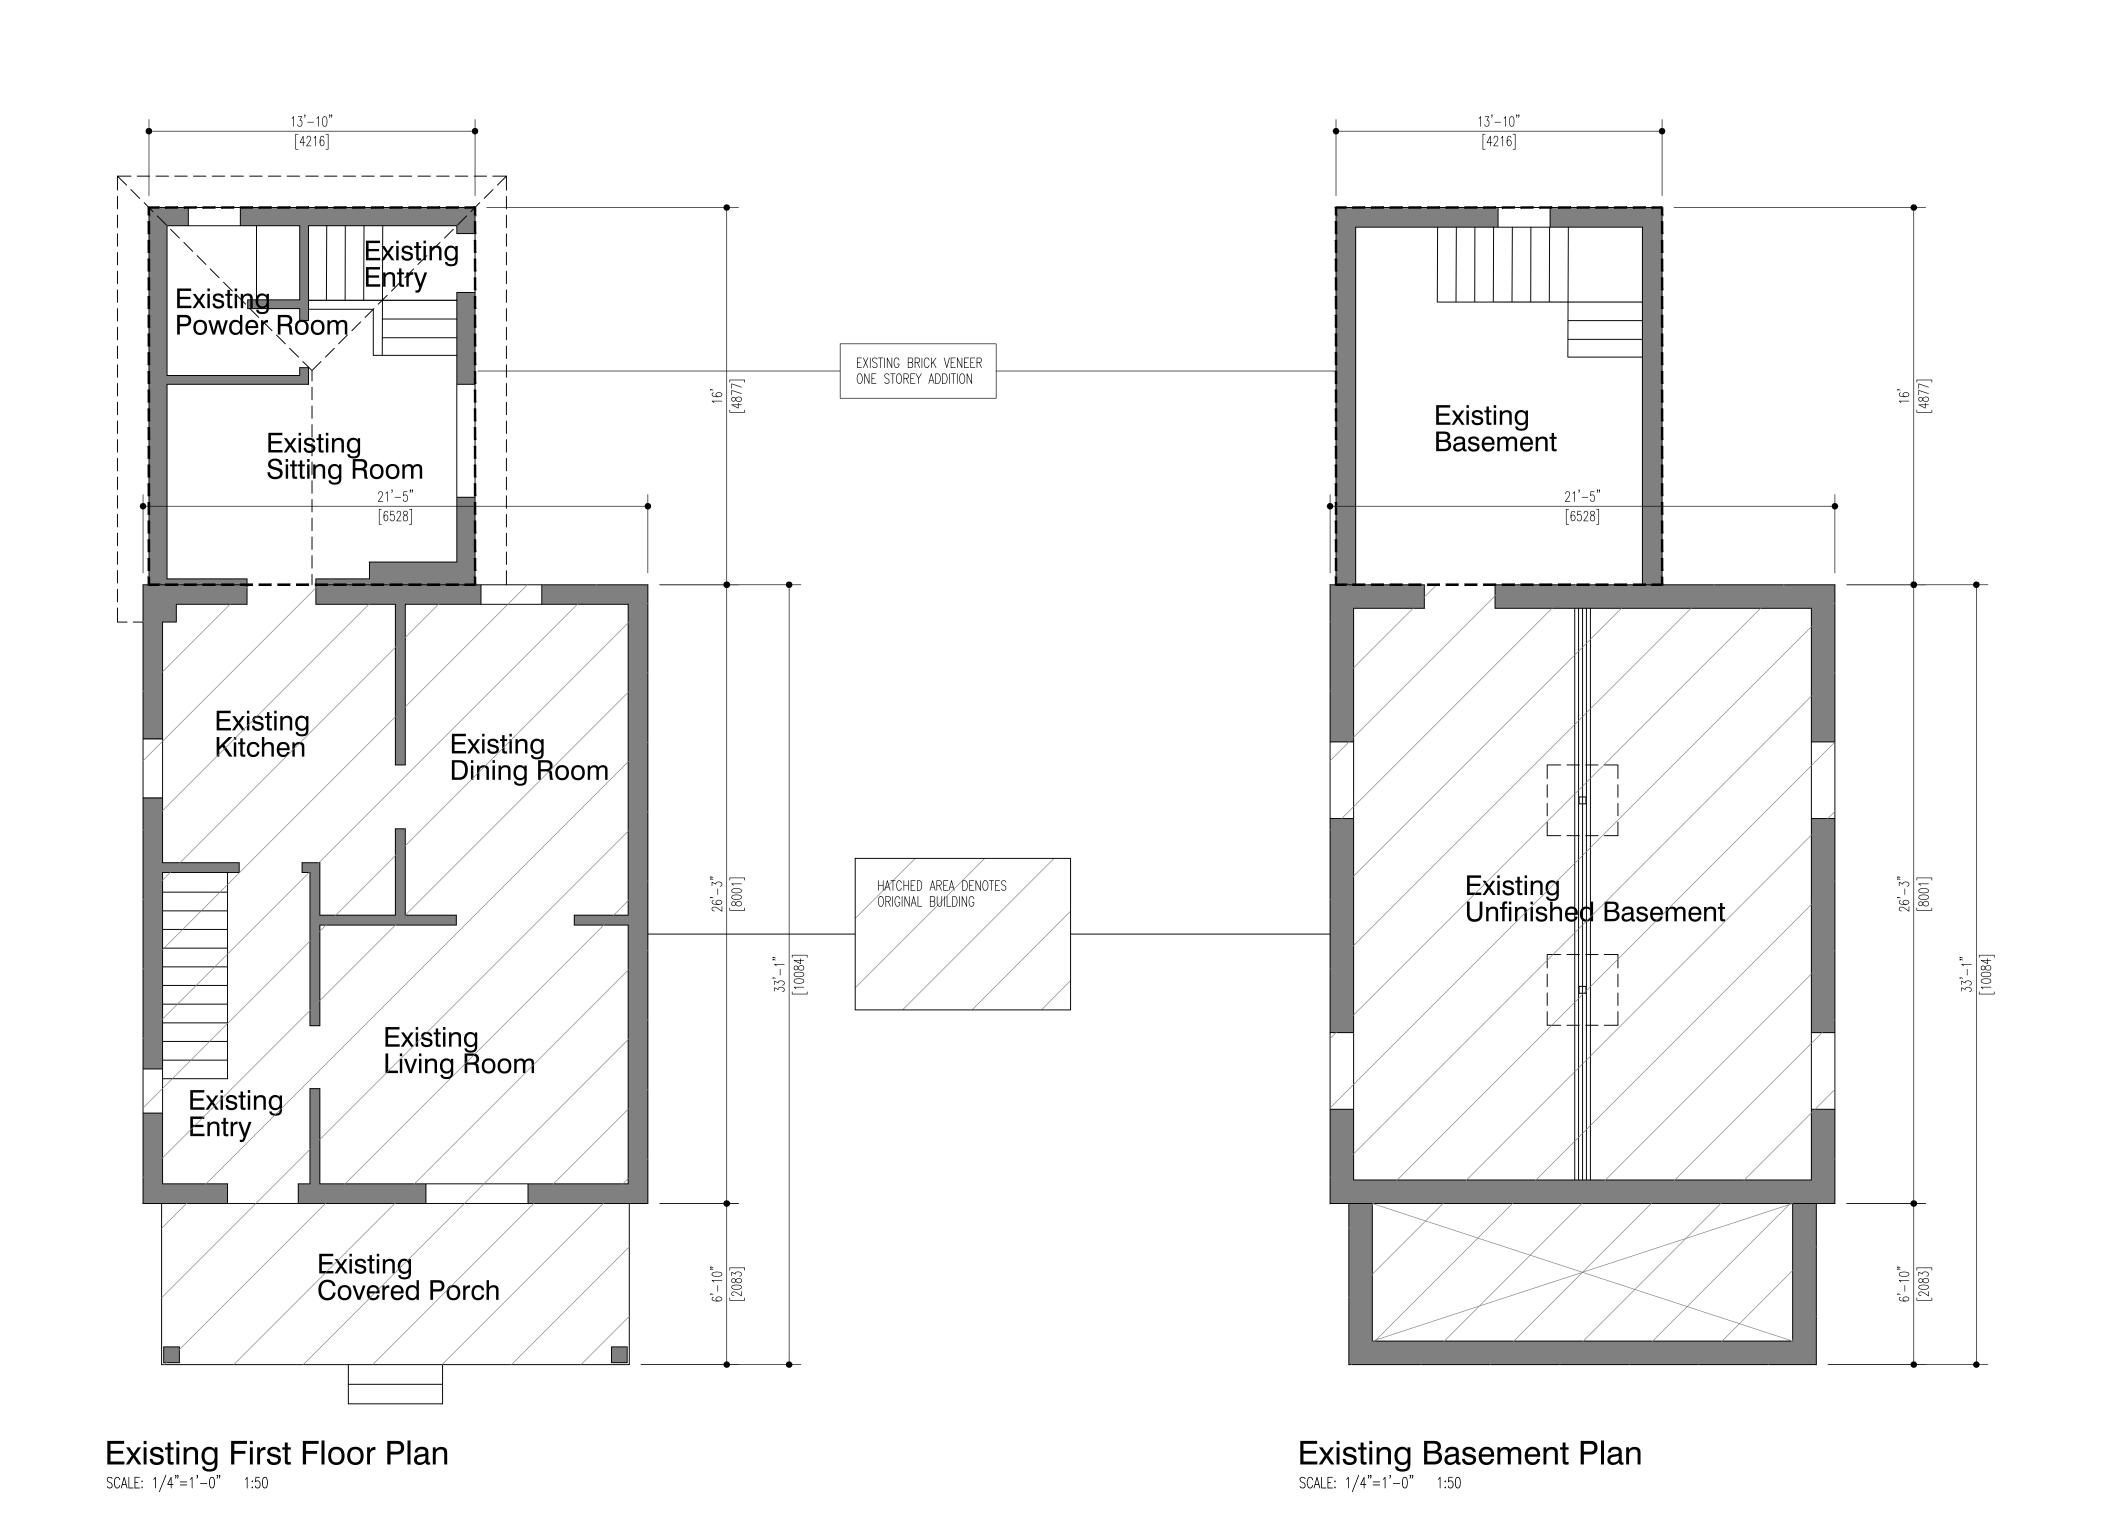

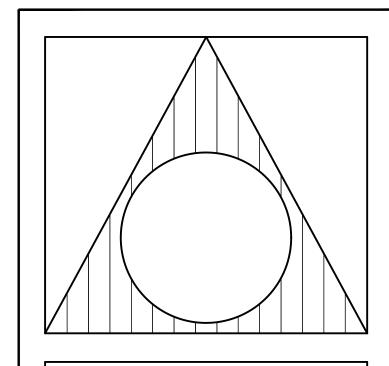

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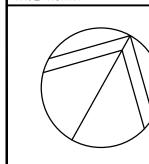
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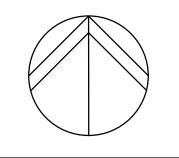
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| 1. | ISSUED FOR PERMIT REVIEW | 26/09/19 | T.V. |
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NEW TWO STOREY REAR ADDITION WITH ATTACHED GARAGE TO EXISTING TWO STOREY SINGLE FAMILY DWELLING 32 Abell Avenue
VAUGHAN, ONTARIO

TRUE NORTH PROJECT NORTH






Existing Basement Plan Existing First Floor Plan

SCALE:


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Existing Attic Plan
SCALE: 1/4"=1'-0" 1:50

Existing Second Floor Plan SCALE: 1/4"=1'-0" 1:50

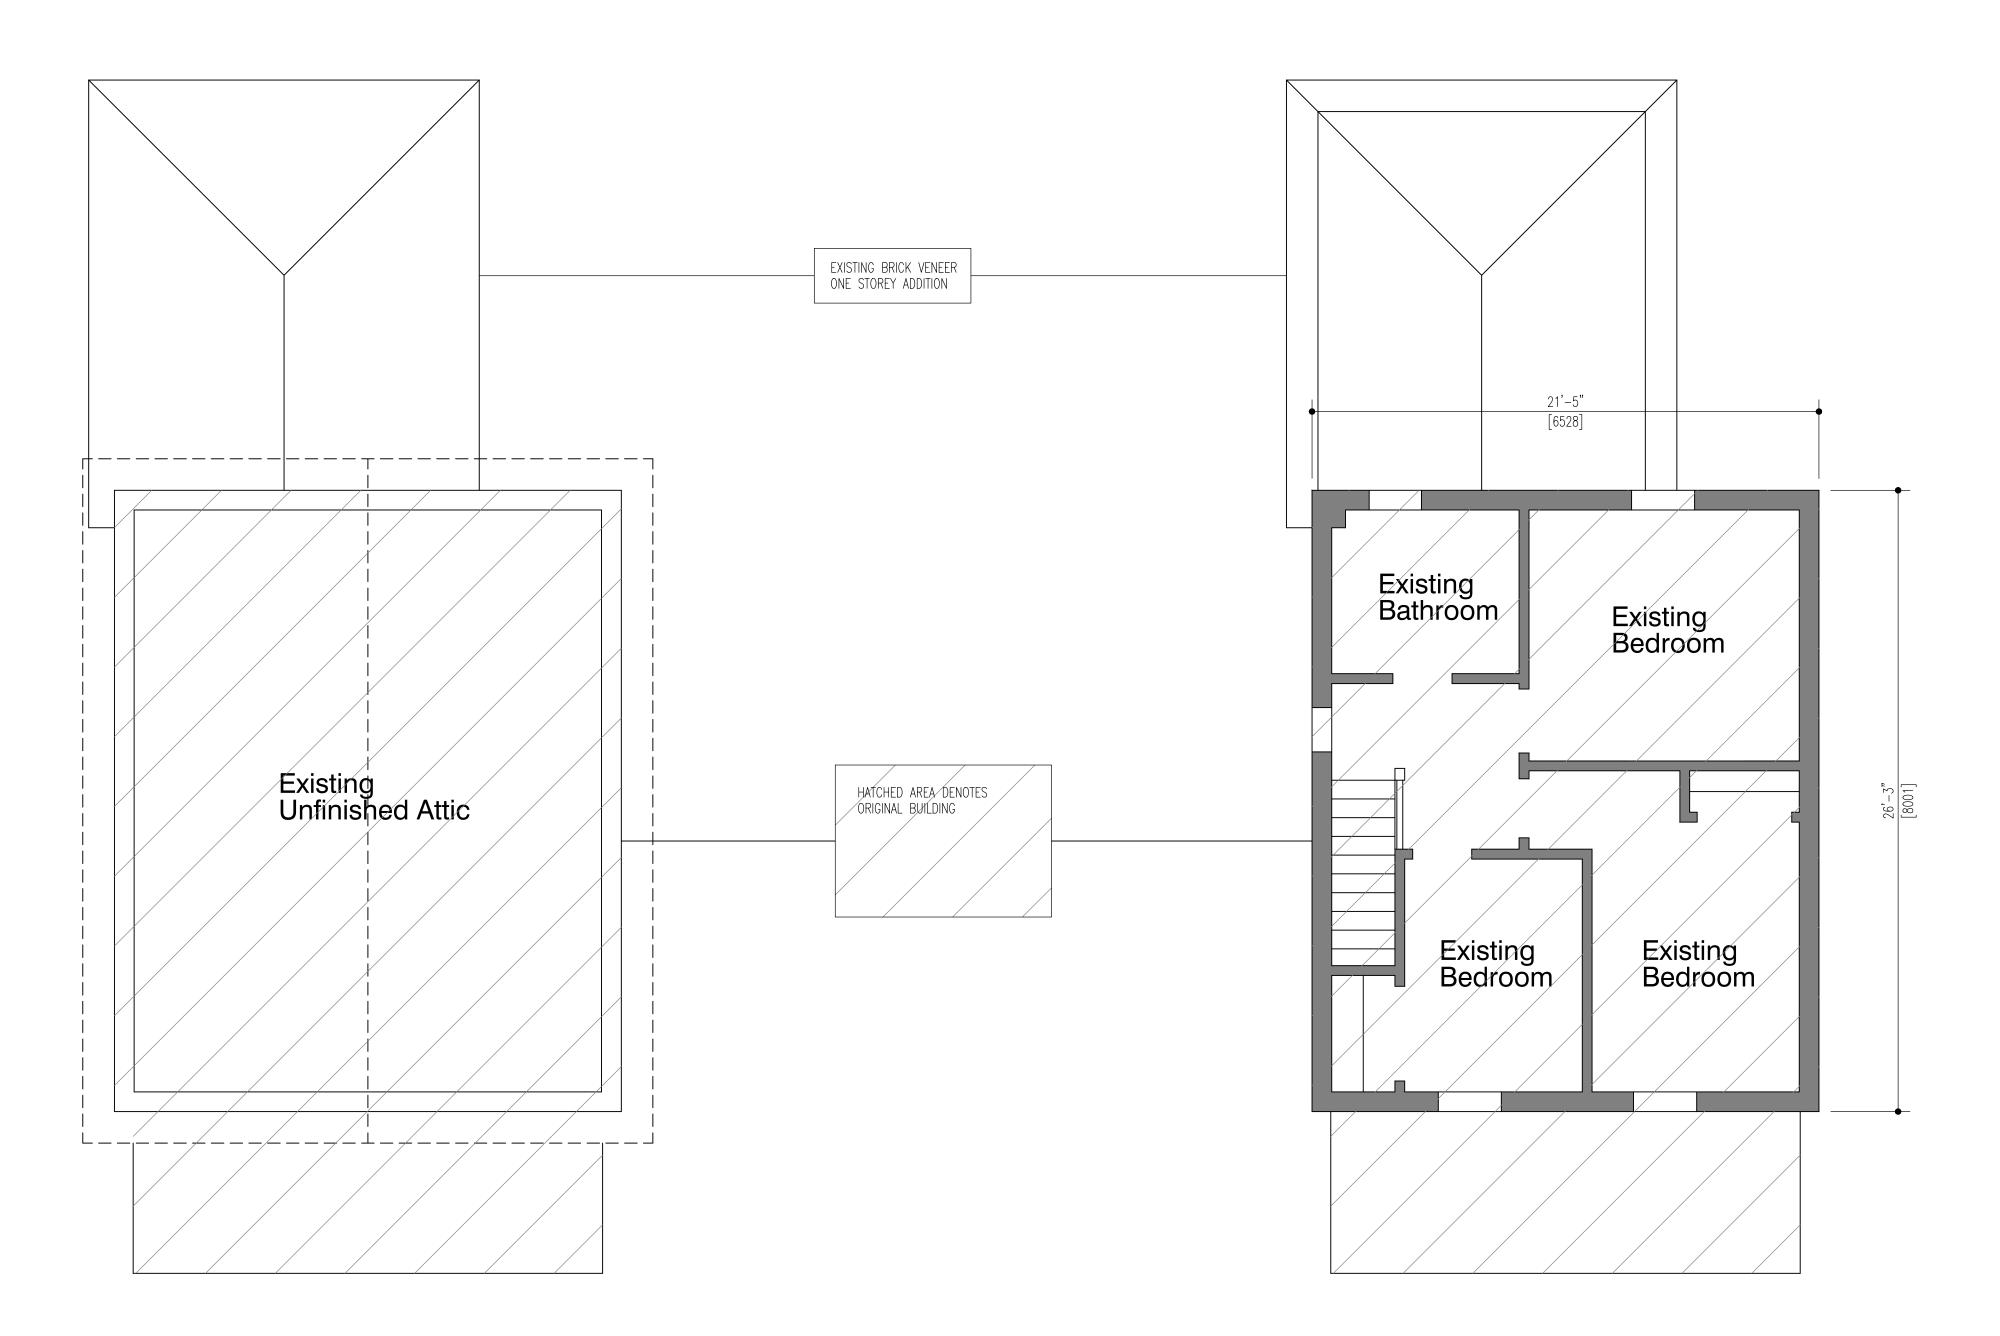

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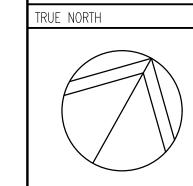
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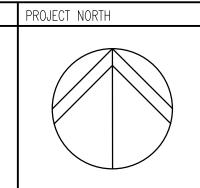
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NEW TWO STOREY REAR ADDITION WITH ATTACHED GARAGE TO EXISTING TWO STOREY SINGLE FAMILY DWELLING

32 Abell Avenue VAUGHAN, ONTARIO

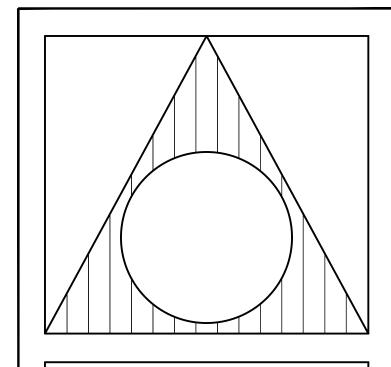





DRAWING CONTENT:

Ex. Second Floor Plan Existing Attic Plan

2018-06

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— DELTA SYSTEM DRAINAGE PROTECTION ON
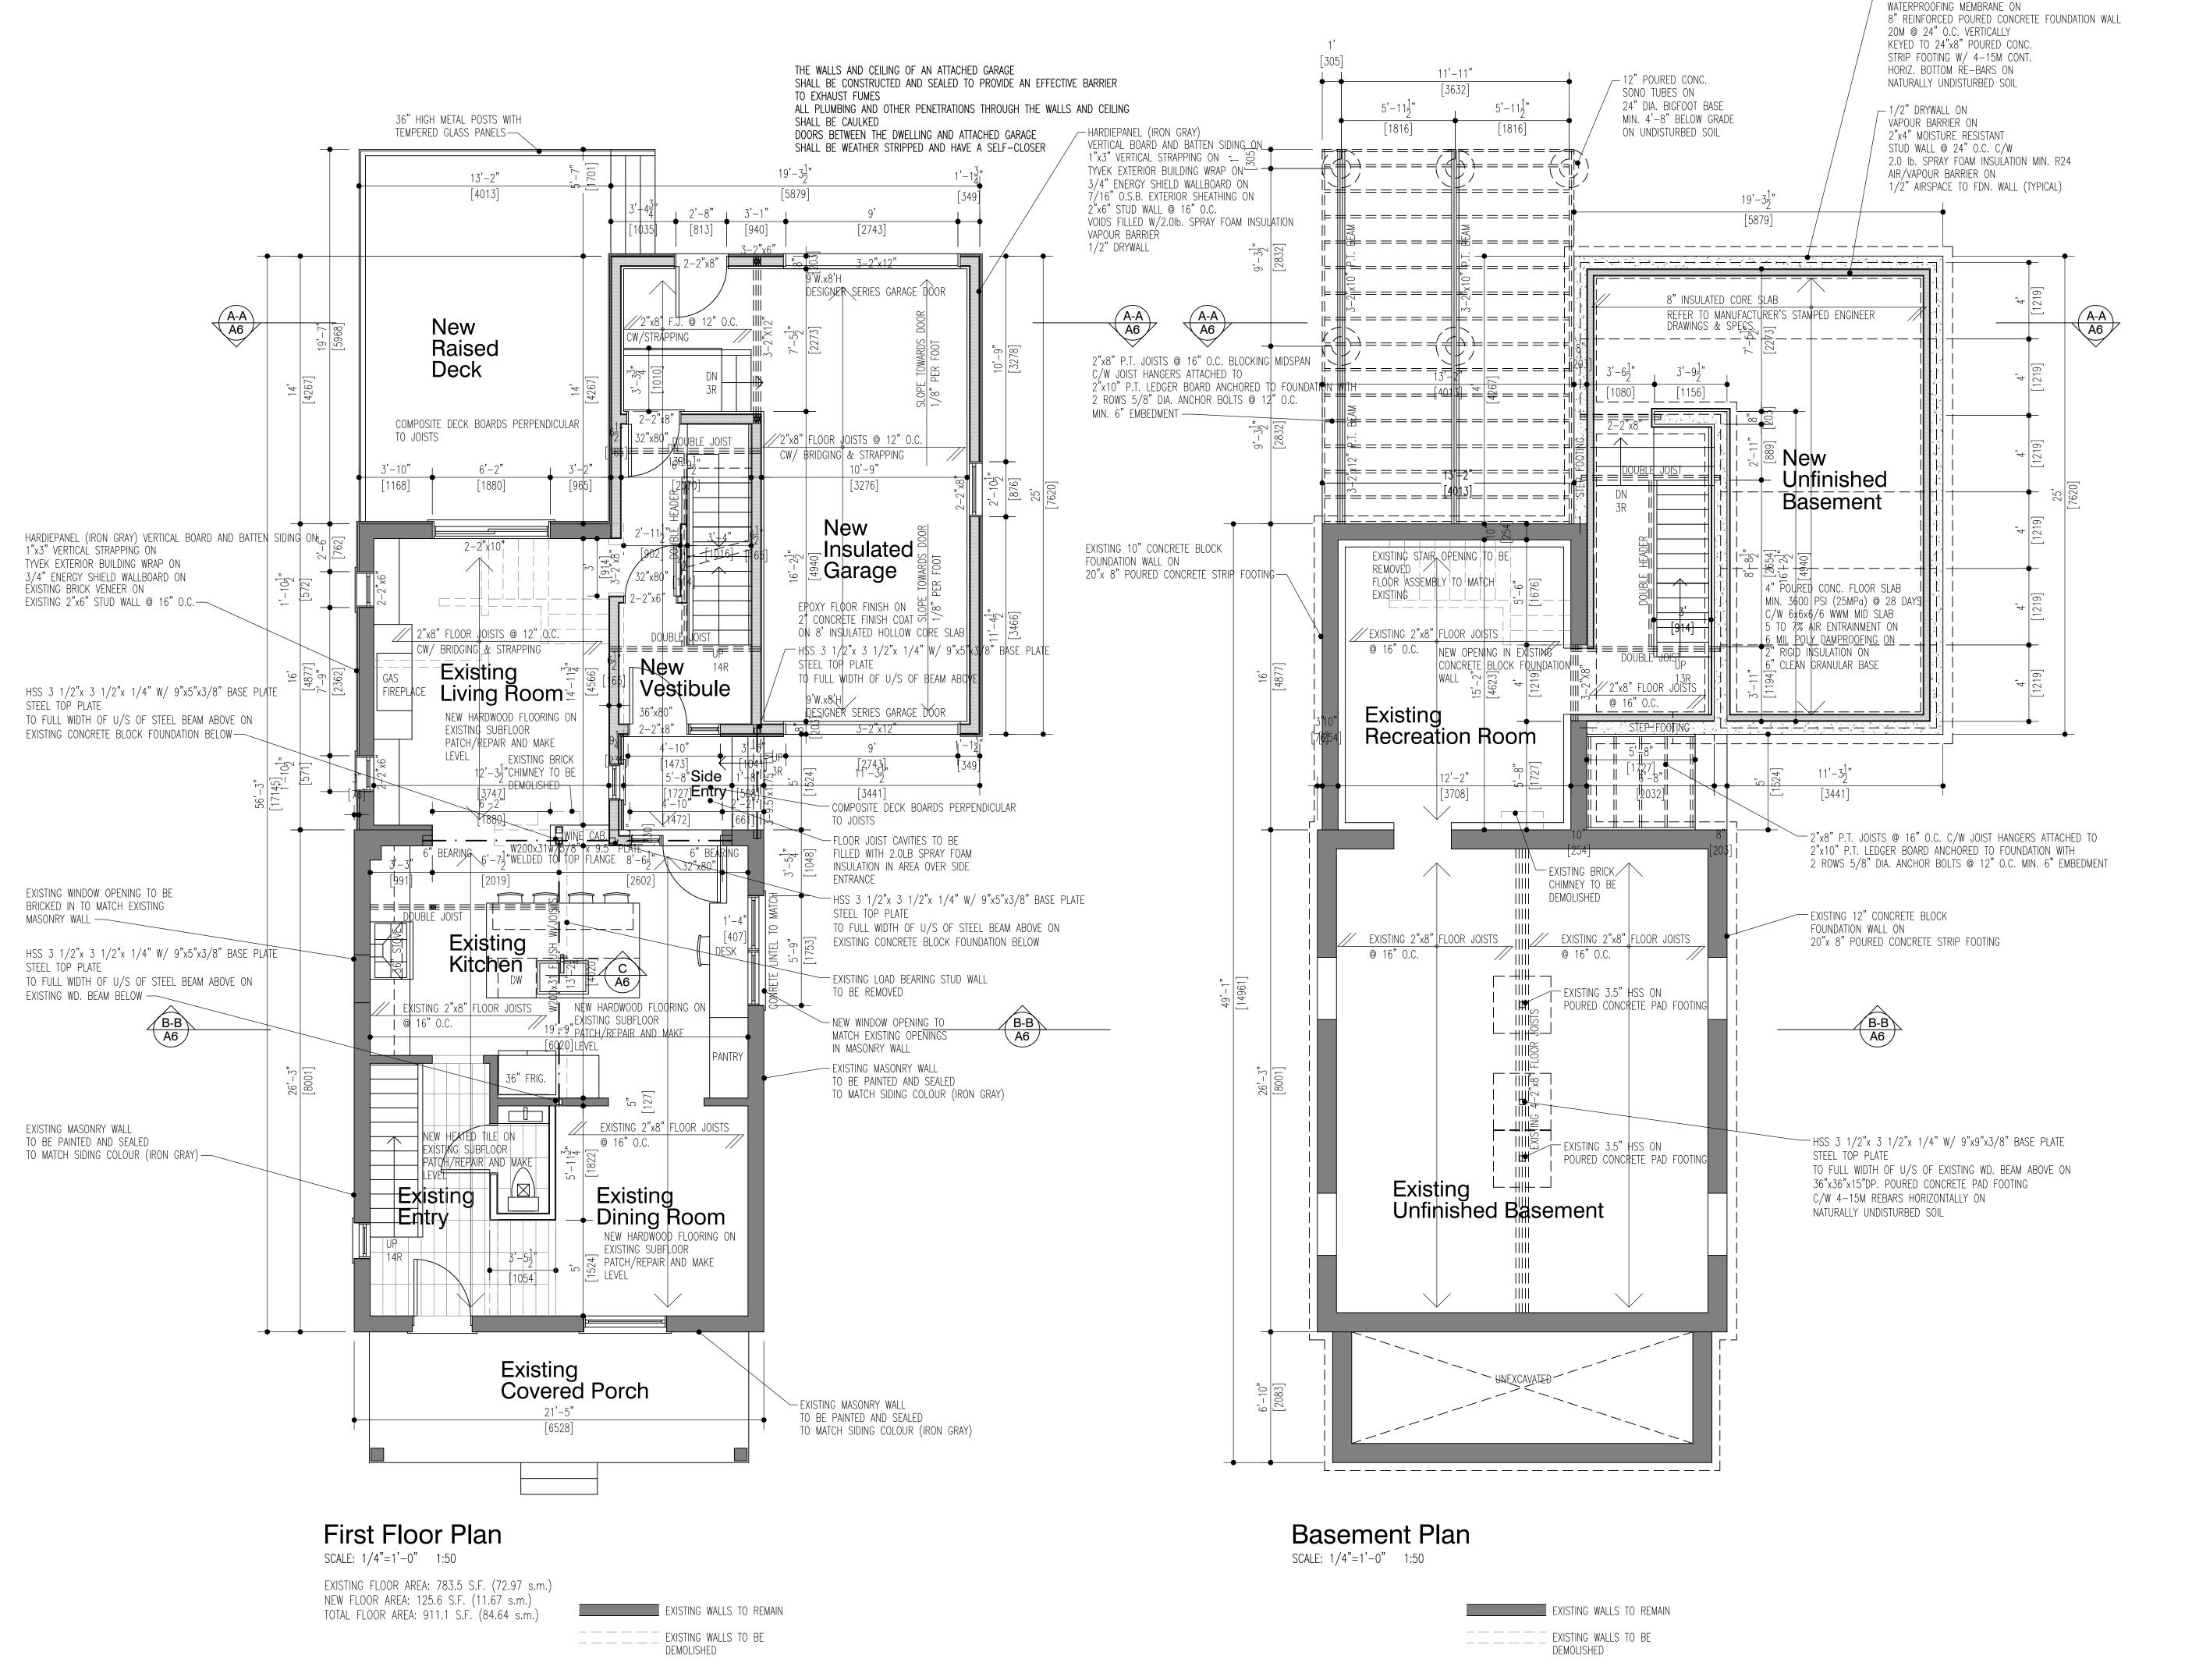
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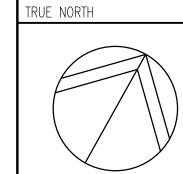
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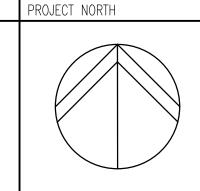
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PROJE

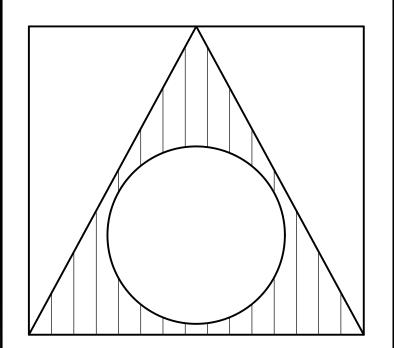new two storey rear addition with attached garage to existing two storey single family dwelling 32 Abell Avenue

VAUGHAN, ONTARIO






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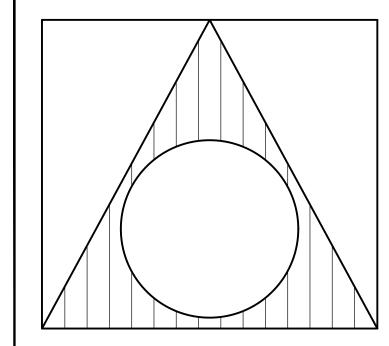
Basement Plan First Floor Plan

DRAWN BY: PROJ. NO.: DRAWING NO.: T.V. 2018-06

DATE: SEPT. 2018

SCALE: AS NOTED



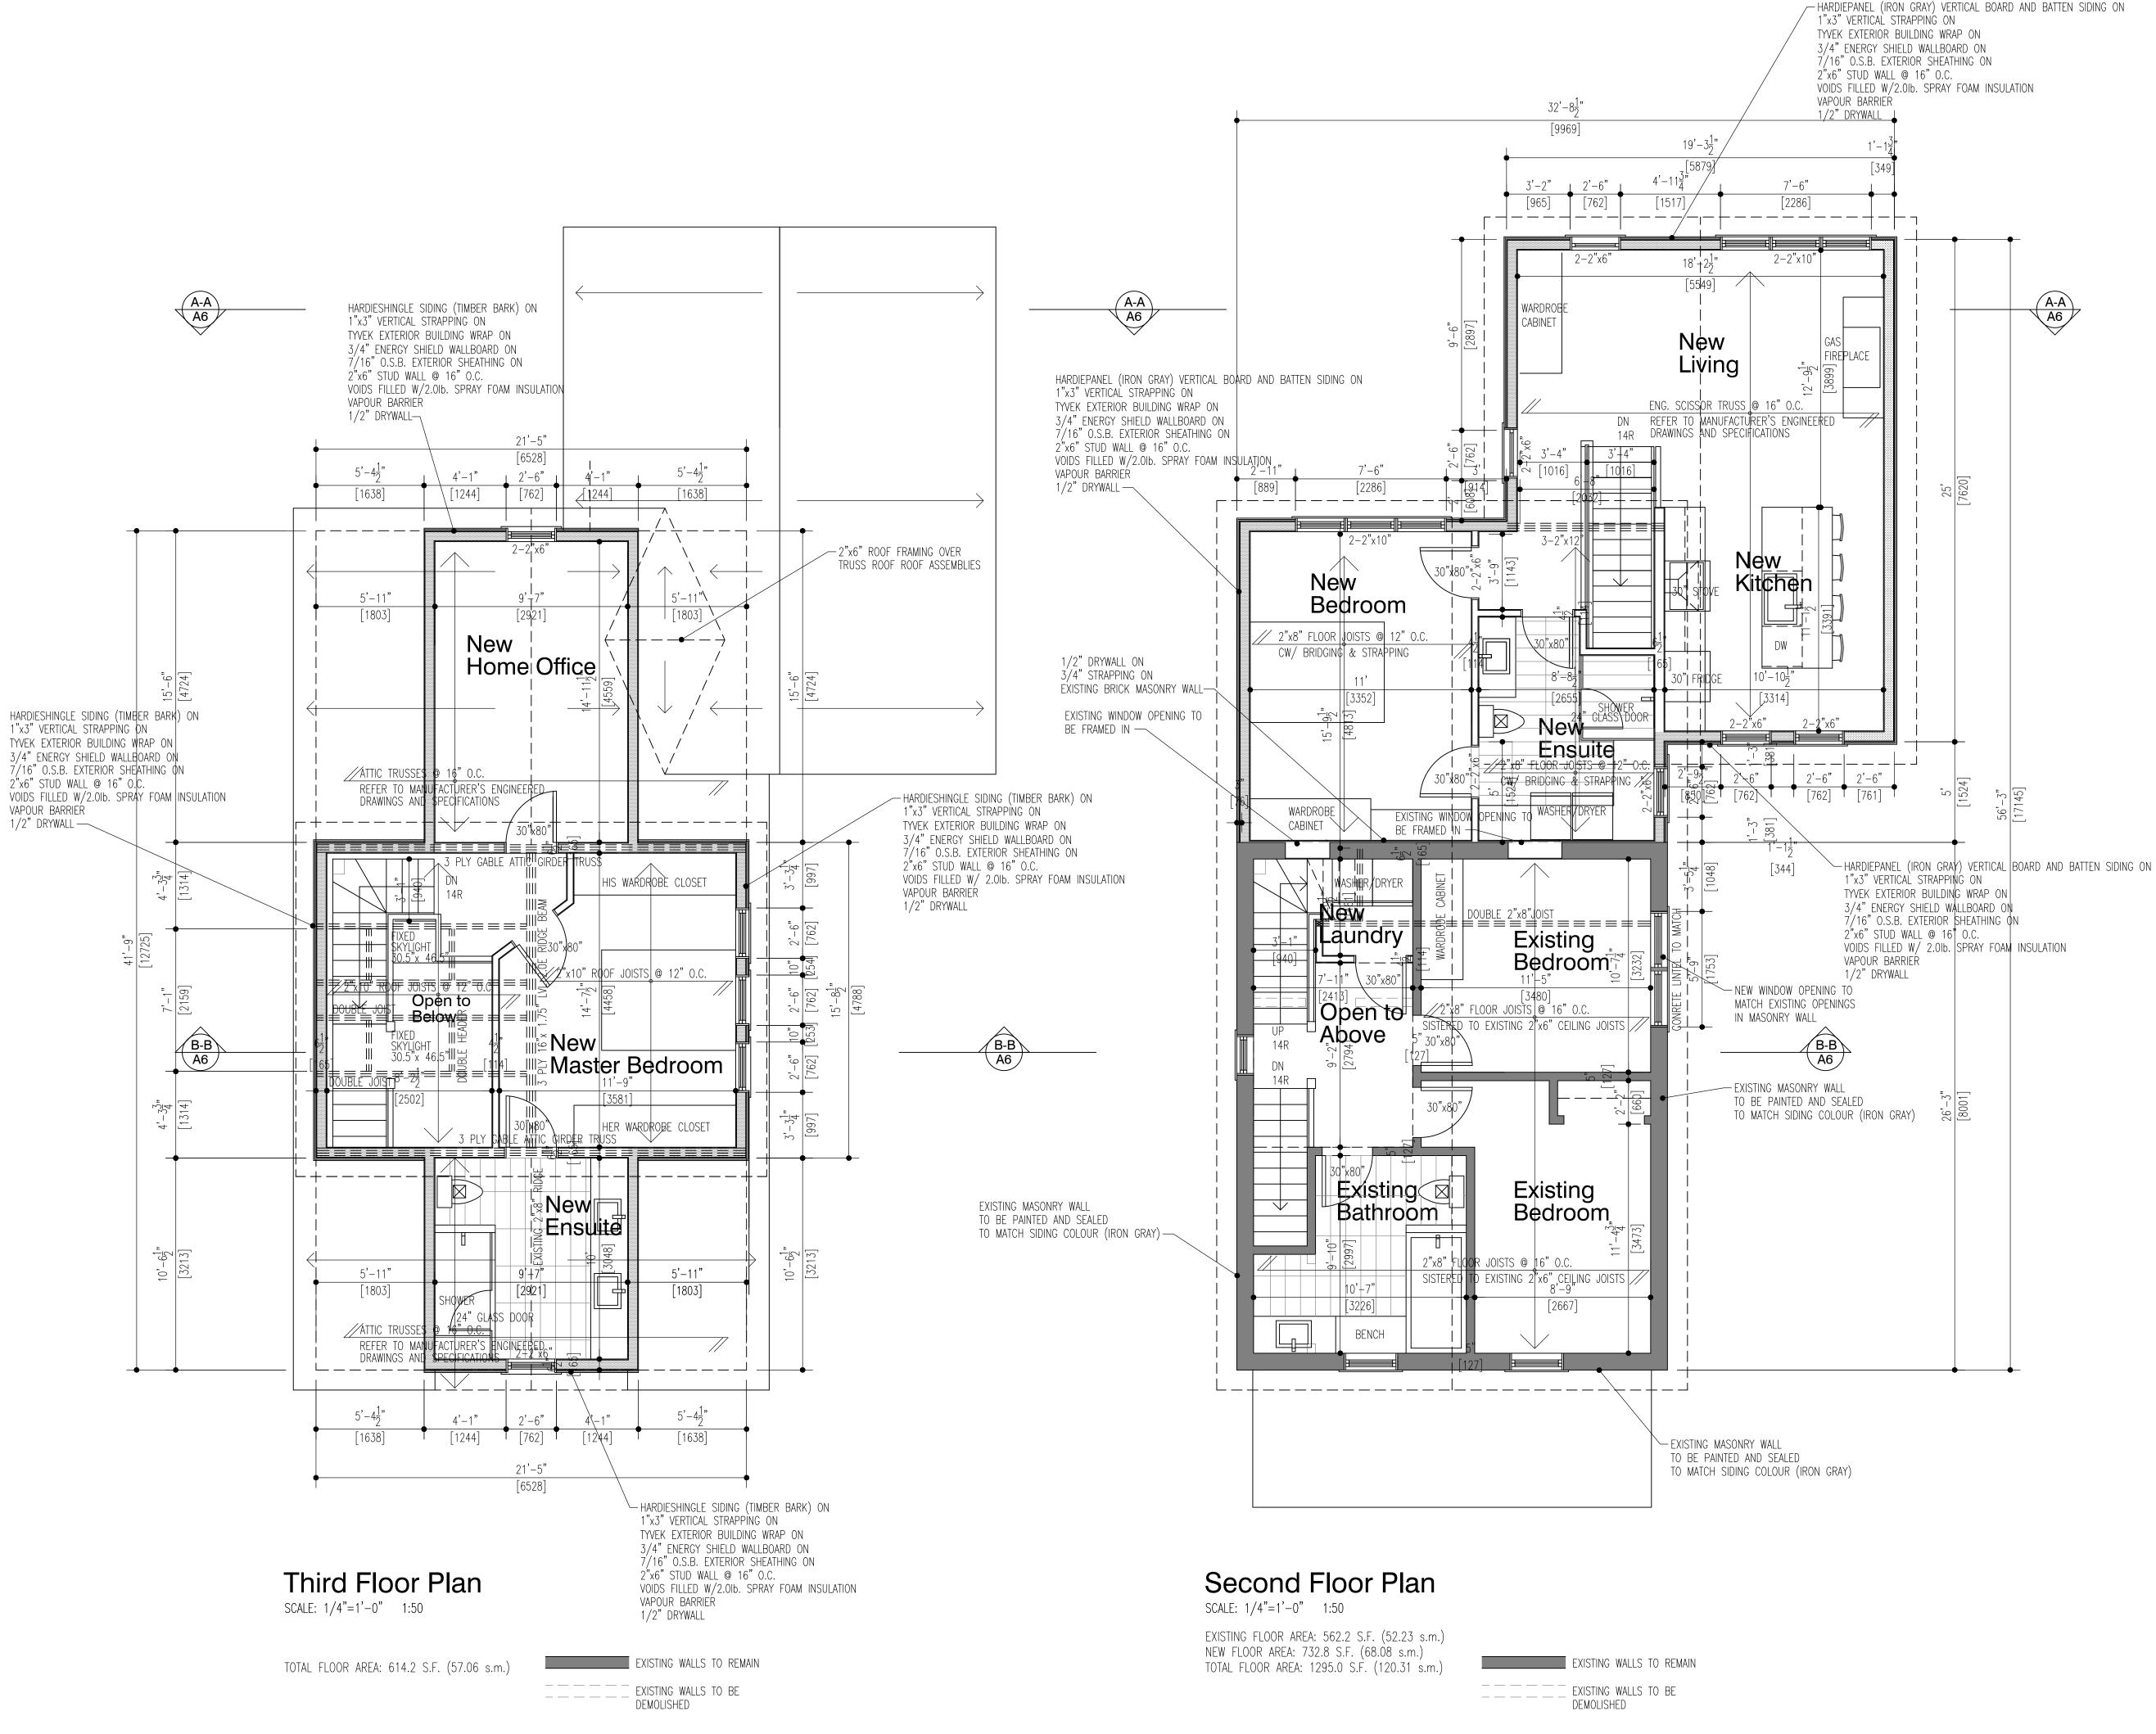

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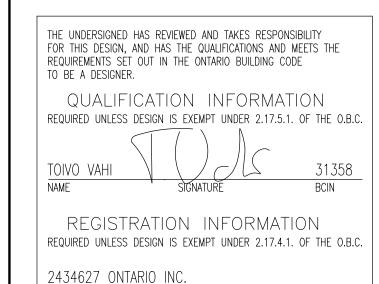
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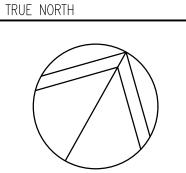
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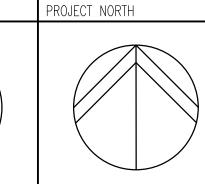
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PROJECT:

NEW TWO STOREY REAR ADDITION WITH ATTACHED GARAGE TO EXISTING TWO STOREY SINGLE FAMILY DWELLING

32 Abell Avenue





DRAWING CONTENT:

Second Floor Plan Third Floor Plan

| DRAWN BY: | PROJ. NO.: | DRAWING NO |
|-----------|------------|------------|
| T.V. | 2018-06 | |

DATE: SEPT. 2018

AS NOTED

A

General Notes on architectural drawings, engineering drawings and manufacturer's specifications supercede the general notes. All notes must comply to the ontario building code regulations.

Excavation and Backfill

Excavation shall be undertaken in such a manner • Garage, carport and exterior slabs and exterior so as to prevent damage to existing structures, adjacent property and utilities The topsoil and vegetable matter in unexcavated • Other slabs 3600psi concrete

areas under a building shall be removed. The

bottom of excavations for foundations shall be free of all organic material If termites are known to exist, all stumps, roots and wood debris shall be removed to a minimum depth of 11 3/4" in excavated areas under a building, and the clearance between untreated structural wood elements and the ground shall be • Where constructed of 3 1/2" brick, wall shall be no less than 17 3/4"

Backfill within 23 5/8" of the foundation walls shall be free of deleterious debris and boulders

Dampproofing and Drainage In normal soil conditions, the exterior surfaces of foundation walls enclosing basements and crawl spaces shall be dampproofed. Where hydrostatic pressure occurs, a waterproofing system is

over 9 7/8"in diameter

Masonry foundation walls shall be parged with 1/4" of mortar coved over the footing prior to dampproofing

foundation drains shall be laid on level, undisturbed ground adjacent to the footings at or below the top of the basement slab or crawl space floor, and shall be covered with 6" of crushed stone. Foundation drains shall drain to a storm sewer, drainage ditch, dry well or sump

• Masonry over openings shall be supported on Window wells shall be drained to the footing with a minimum of 5 7/8" end bearing Downspouts not directly connected to a storm sewer shall have extensions to carry water away

from the building, and provisions shall be made to prevent soil erosion Concrete slabs in attached garages shall be sloped to drain to the exterior sump and roof drainage will not accumulate at or of the cavity and over doors and windows adjacent properties

Footings

• minimum 2200 psi poured concrete minimum 48" below finished grade Footings shall be founded on natural undisturbed soil, rock or compacted granular fill with minimum bearing capacity of 1570psf

Footing Size Supporting Supporting Ext. Wall Supported 9 7/8" 9 7/8" 4.3 ft2 13 3/4" 17 3[′]/4" 19 3/4" 10.9 ft2 • Increase footing width by 2 5/8" for each storey

of brick veneer supported, and by 5 1/8" for each storev of masonry • See Tables for roof sheathing requirements • The projection of an unreinforced footing beyond the wall supported shall not be greater

Step Footings Vertical Rise

Horizontal Run 23 5/8"Min.

than its thickness

23 5/8"Max.

Wood Frame Construction

 All lumber shall be spruce-pine-fir No.1 &2, and shall be identified by a grade stamp Maximum moisture content 19% at time of

• Wood framing members which are supported on concrete in direct contact with soil shall be separated from the concrete with 6 mil

 Exterior walls shall consist of: cladding, brick veneer or stucco

 sheathing paper lapped 4"at joints • 7/16" fibreboard or gypsum board or 7/16" plywood sheathing 2x6 studs @ 16" o.c.

• 2x6 bottom plate and double 2x6 top plate • 2x4 studs @16"o.c. can be utilized provided the combined R value of the batt insulation and exterior rigid insulation achieves R-24. • Interior loadbearing walls shall consist of:

• 2x4 studs @ 16" o.c. • 2x4 bottom plate and double 2x4 top plate 2x4 mid—girts if not sheathed 1/2" gypsum board sheathing

Floors

 See Tables for floor joist size and spacing requirements Joists to have minimum 1 1/2" of end bearing

 Joists shall bear on a sill plate fixed to foundation with 1/2" anchor bolts @7' 10" o.c • Header joists between 3' 11"and 10' 6" in

10°6" shall be sized by calculations • Trimmer joists shall be doubled when supported header is between 2' 7" and 6' 7". Trimmer joists shall be sized by calculations when supported header exceeds 6' 7"

from each support and from other rows of

• See Tables for subflooring requirements

equivalent performance

floor joists installed before backfilling

• Foundation walls shall be braced or have the

Joists shall be supported on joist hangers at all

flush beams, trimmers, and headers. Joists located under parallel non-loadbearing partitions shall be doubled

Foundation Walls To be poured concrete, unit masonry or preserved wood (see drawings for type and

• Dampproofing shall be a heavy coat of bituminous material. • Foundation wall to extend minimum 5 7/8"

Exterior house doors and windows within 6'7" above finished grade. from grade shall be constructed to resist forced • A drainage layer is required on the outside of a foundation wall where the interior insulation extends more than 2'-11" below exterior grade. A drainage layer shall consist of

Exterior Walls • Min. 3/4" mineral fibre insulation with min.

Density of 3.6 lb/ft² • Min. 4" of free drainage granular material, property lines An approved system which provides

> rom property lines Non combustible cladding shall be installed on

thick & reinforced with galvanized diamond mesh lath, applied over polyethylene on subflooring on joists at no more than 16"o.c. with at least 2 rows cross bridging

Concrete Floor Slabs

steps shall be 4650psi concrete with 5-8%air

Minimum 3" thick, placed on a minimum4" of

coarse, clean, granular material All fill other than coarse clean material placed beneath concrete slabs shall be compacted to provide uniform support

Masonry Walls

bonded with header course every 6th course Provide 2" solid masonry or continuous 1 1/2" plate under all roof and floor framing members

Provide 7 1/2" solid masonry under beams and

 Masonry wall to be tied to each tier of joists with 1.9/16" x 3/16" corrosion resistant steel straps, keyed minimum 4" into masonry. When joists are parallel to wall, ties are to extend across at

least 3 joists @ 6'-7" o.c. Inside back of wall to be parged and covered

with No.15 breather—type asphalt paper For reduced foundation walls to allow a brick facing while maintaining lateral support, tie minimum 3 1/2" brick to minimum 3 1/2" backup block with corrosion resistant ties at least 0.028in 2 in cross sectional area, spaced 7 7/8" vertically and 2'-11"horizontally, with joints

completely filled with mortar corrosion resistant or prime painted steel lintels

Masonry Veneer

 Minimum 2 3/4" thick if joints are not raked and
 Wood columns for carports and garages shall be 3 1/2"thick if joints are raked Minimum 1" air space to sheathing

The building site shall be graded so that surface, \bullet Provide weep holes @ 31 1/2" o.c.at the bottom near the building and will not adversely affect

• Direct drainage through weep holes with 20 mil poly flashing extending minimum 5 7/8" up

behind the sheathing paper • Veneer ties minimum 0.030" thick x 7/8" wide corrosion resistant straps spaced @ 23 5/8"

vertically and 15 3/4" horizontally Fasten ties with corrosion resistant 0.125" diameter screws or spiral nails which penetrate at

Roof & Ceilings

least 1-3/16" into studs

• See Tables for rafter, roof joist and ceiling joist size and spacing requirements • Hip and valley rafter shall be 2" deeper than

common rafters • 2x4 collar ties @ rafter spacing with 1x4 continuous brace at mid span if collar tie exceeds

Notching&Drilling of Trusses, Joists. Rafters

• Holes in floor, roof and ceiling members to be maximum 1/4 x actual depth of member and not less than 2" from edges • Notches in floor, roof and ceiling members to be located on top of the member within 1/2 the

greater than 1/3 joist depth • Wall studs may be notched or drilled provided that no less than2/3the depth of the stud remains, if load bearing, and 1 9/16" if non-load

actual depth from the edge of bearing and not

 Roof truss members shall not be notched, drilled or weakened unless accommodated in the design

Roofing • Fasteners for roofing shall be corrosion resistant.

Roofing nails shall penetrate through or at least 1/2" into roof sheathing • Every asphalt shingle shall be fastened with at least 4 nails

• Eave protection shall extend 2' 11"up the roof slope from the edge, and at least 11 3/4"from the inside face of the exterior wall, and shall consist of Type M or Type S Roll Roofing laid with minimum 4" head and end laps cemented base sheets, or self sealing composite

together, or glass Fibre or Polyester Fibre coated membranes consisting of modified bituminous coated material. Eave protection is not required for unheated buildings, for roofs exceeding a slope of 1 in 1.5, or where a low slope asphalt

shingle application is provided Open valleys shall be flashed with 2 layers of roll roofing, or 1 layer of sheet metal min. 23 5/8" wide

 Flashing shall be provided at the intersection of shingle roofs with exterior walls and chimneys • Sheet metal flashing shall consist of not less than

1/16"sheet lead, 0.013" galvanized steel, 0.018" copper, 0.018" zinc, or 0.019"aluminum

Natural Ventilation length shall be doubled. Header joists exceeding Every roof space above an insulated ceiling shall

 be ventilated with unobstructed openings equal to not less than 1/300 of insulated area Insulated roof spaces not incorporating an attic shall be ventilated with unobstructed openings equal to not less than 1/150 of insulated area.

• 2x2 cross bridging required not more than 6'11" • Roof vents shall be uniformly distributed and designed to prevent the entry of rain, snow or Unheated crawl spaces shall be provided with

1.1 ft 2 of ventilation for each 538 ft 2 Minimum natural ventilation areas, where mechanical ventilation is not provided, are:

Unfinished basement: 0.2% of floor area

Doors and Windows • Every floor level containing a bedroom and not

served by an exterior door shall contain at least 1 window, having an unobstructed open area of 3.8 ft and no dimension less than 15", which is

openable from the inside without tools

entry. Doors shall have a deadbolt lock The principal entry door shall have either a door viewer, transparent glazing or a sidelight

No windows or other unprotected openings are

permitted in exterior walls less than 3' 11" from • 5/8" fire rated drywall shall be installed on the inside face of attached garage exterior walls and gable ends of roofs which are less than 3' 11"

all exterior walls less than 23 5/8" from property

Ceramic Tile • When ceramic tile applied to a mortar bed with • 5 cfm for each other room adhesive, the bed shall be a minimum of 1/2"

Access to Attics

and Crawl Spaces Access hatch minimum 21 5/8"x 2' -11" to be provided to every crawl space and every roof space which is 108 ft² or more in area and more

The walls and ceiling of an attached garage shall

may not open into a bedroom and shall be

weatherstripped and have a self-closer

than 23 5/8" in height Garage Gasproofing

be constructed and sealed so as to provide an effective barrier to exhaust fumes All plumbing and other penetrations through the walls and ceiling shall be caulked Doors between the dwelling and attached garage

Alarms and Detectors

At least one smoke alarm shall be installed on or near the ceiling on each floor and basement level 11" or more above an adjacent level Smoke alarms shall be interconnected and located such that one is within 16' 5" of every bedroom door and no more than 49' 3" travel

distance from any point on a floor A carbon monoxide detector shall be installed on or near the ceiling in every room containing a solid fuel burning fireplace or stove

Columns. Beams & Lintels

• Steel beams and columns shall be shop primed. Minimum 3 1/2" end bearing for wood and steel beams, with 7 7/8" solid masonry beneath the

 Steel columns to have minimum outside diameter of 2 7/8" and minimum wall thickness

minimum $3 \frac{1}{2}$ " x $3 \frac{1}{2}$ "; in all other cases either $5 \frac{1}{2}$ " x $5 \frac{1}{2}$ " or $7 \frac{1}{4}$ " round, unless calculations based on actual loads show lesser sizes are adequate. All columns shall be not less than the width of the supported member

 Masonry columns shall be a minimum of 11 3/8" x 11 3/8"or 9 1/2" x 15" Provide solid blocking the full width of the

supported member under all concentrated loads Insulation & Weatherproofing

Zone 1 Less than 5000 Degree-Days Compliance Package A with AFUE ≥ 90% Ceiling with attic RSI/R Value 8.81 / R60

RSI/R Value 5.46 / R31 Ceiling without attic Exposed floor RSI/R Value 5.46 / R31 Walls above arade RSI/R Value 4.23 / R24 Basement walls RSI/R Value 3.52 / R20 Below grade slab entire surface > 600mm below grade RSI/R Value 0.88 / R5 Edge of below grade slab ≤ 600mm below grade RSI/R Value 1.76 / R10 Heated slab or slab RSI/R Value 1.76 / R10 ≤ 600mm below grade Windows and sliding glass doors

maximum U-Value maximum U-Value 2.8 Space heating equipment 90% minimum AFUE Minimum Efficiency

unfinished basements where Ducts passing through unheated space shall be made airtight with tape or sealant • Caulking shall be provided for all exterior doors

and windows between the frame and the exterior Weatherstripping shall be provided on all doors

and access hatches to the exterior, except doors from a garage to the exterior Exterior walls, ceilings and floors shall be

constructed so as to provide a continuous barrier to the passage of water vapour from the interior and to the leakage of air from the exterior

Stairs Maximum Rise 8 1/4" Minimum Run

9 1/4 Minimum Tread Minimum Head Room Minimum Width Curved stairs shall have a min. run of 5 7/8" a any point and a minimum average run of 7/8

 Winders which converge to a point in stairs must turn through an angle of no more than 90 , with no less than 30° or more than 45 $^{\circ}$ per tread. Sets of winders must be separated by 3' 11"along the

• A landing minimum 2' 11"in length is required at the top of any stair leading to the principal entrance to a dwelling, and other entrances with more than 3 risers

• Exterior concrete stairs with more than 2 risers

require foundations Handrails and Guards

 A handrail is required for interior stairs containing more than 2 risers and exterior stairs containing more than 3 risers

 Guards are required around every accessible surface which is more than 23 5/8" above the adjacent level • Interior and exterior guards min. 2' 11" high. Exterior guards shall be 3' 6" high where height

above adjacent surface exceeds 5' 11" Guards shall have no openings greater than 4", and no member between 4" and 2' 11" that will

Plumbing

• Every dwelling requires a kitchen sink, lavatory, water closet, bathtub or shower stall and the installation or availability of laundry facilities A floor drain shall be installed in the basement, and connected to the sanitary sewer where

gravity drainage is possible. In other cases, it shall be connected to a storm drainage system, ditch or dry well Electrical • An exterior light controlled by an interior switch is required at every entrance A light controlled by a switch is required in every kitchen, bedroom, living room, utility

room, laundry room, dining room, bathroom, vestibule, hallway, garage and carport. A switched receptacle may be provided instead of a light in bedrooms and living rooms • Stairs shall be lighted, and except where serving

an unfinished basement shall be controlled by a 3 way switch at the head and foot of the stairs Basements require a light for each 323 ft,


controlled by a switch at the head of the stairs Mechanical Ventilation


switch identified as such

• A mechanical ventilation system is required with a total capacity at least equal to the sum of: • 10 cfm each for basement and master bedroom A principal dwelling exhaust fan shall be installed and controlled by a centrally located

• Supplemental exhaust shall be installed so that the total capacity of all kitchen, bathroom and other exhausts , less the principal exhaust, is not less than the total required capacity A Heat Recovery Ventilator may be employed in lieu of exhaust to provide ventilation. An HRV

is required if any solid fuel burning appliances Supply air intakes shall be located so as to avoid contamination from exhaust outlets

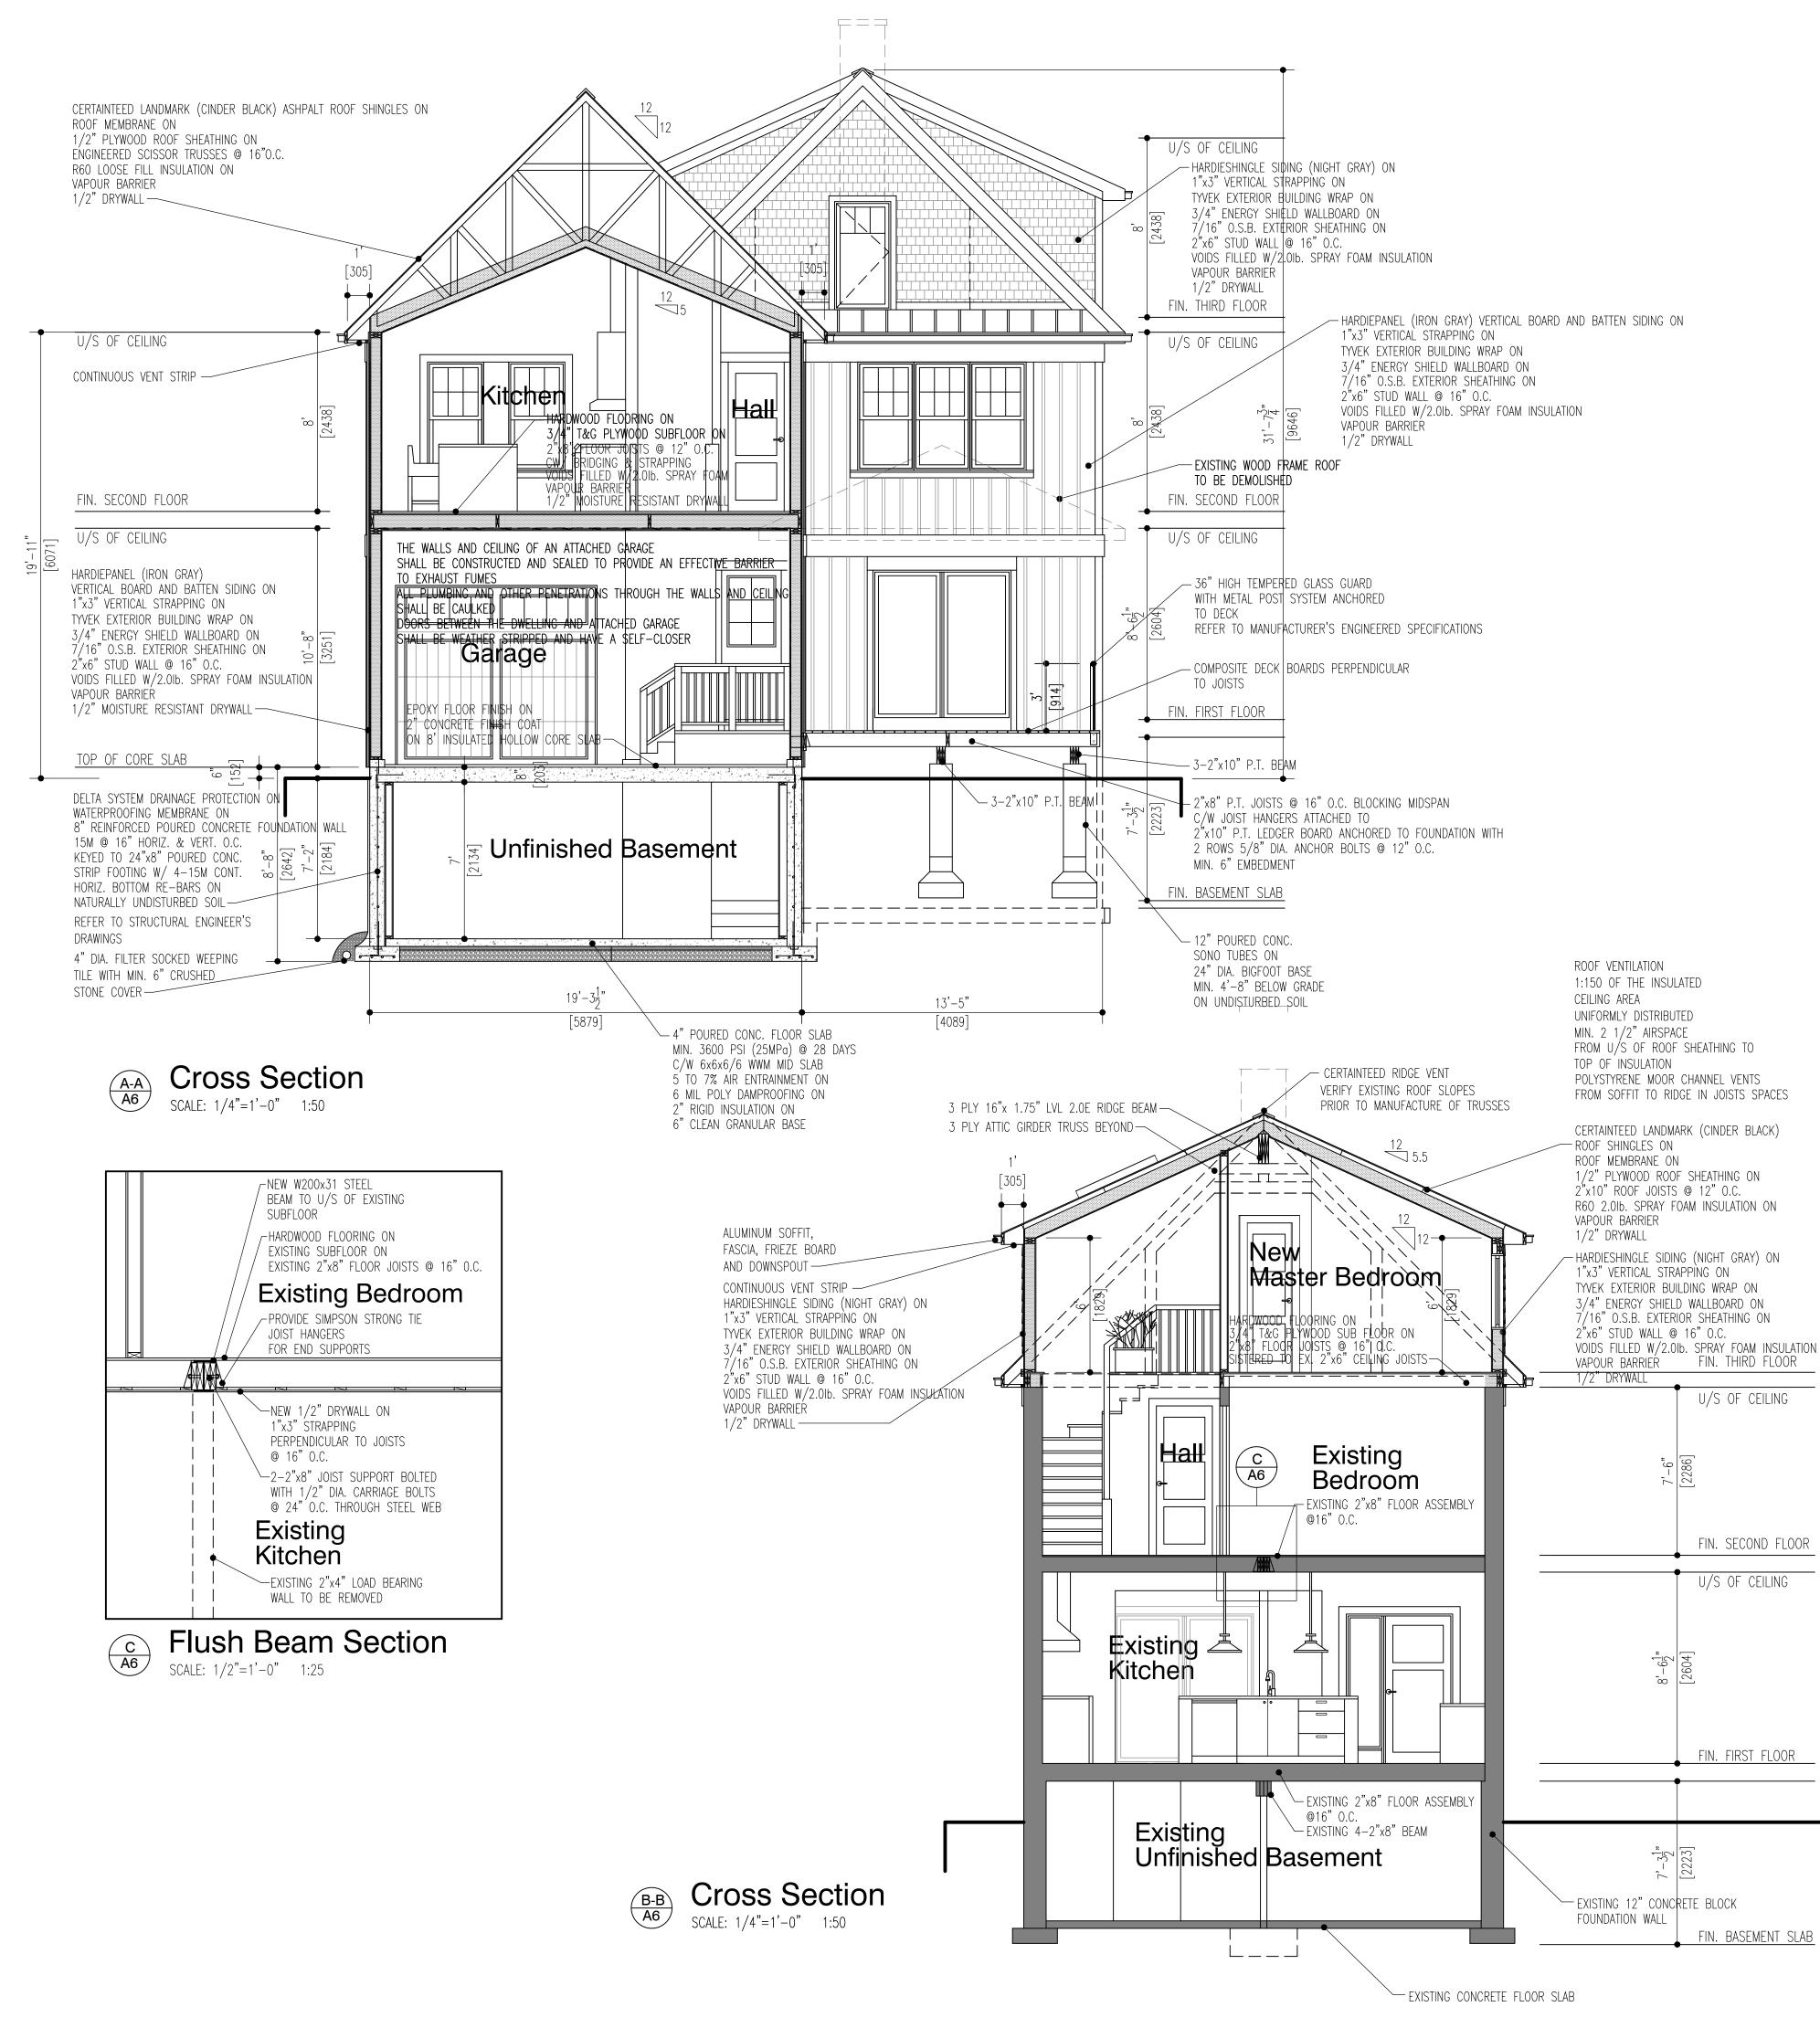

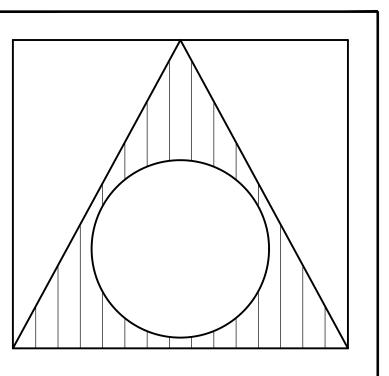

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REVISED FOR HERITAGE REVIEW ISSUED FOR PERMIT REVIEW NO. REVISION

NEW TWO STOREY REAR ADDITION WITH ATTACHED GARAGE

TO EXISTING TWO STOREY SINGLE FAMILY DWELLING

32 Abell Avenue VAUGHAN, ONTARIO

PROJECT:

TRUE NORTH

PROJECT NORTH

Sections

RAWING CONTENT:

PROJ. NO.: DRAWING NO.: 2018-06

SEPT. 2018 SCALE: AS NOTED