### REPORT SUMMARY MINOR VARIANCE APPLICATION FILE NUMBER A013/25

#### Report Date: March 14, 2025

### THIS REPORT CONTAINS COMMENTS FROM THE FOLLOWING DEPARTMENTS & AGENCIES (SEE SCHEDULE B):

Additional comments from departments and agencies received after the publication of the report will be made available on the City's <u>website</u>.

Internal Departments *Comments Received	Condition	s Required	Nature of Comments
Committee of Adjustment	Yes 🗆	No 🖂	General Comments
Building Standards (Zoning)	Yes 🗆	No 🖂	General Comments
Development Planning	Yes 🗆	No 🖂	Recommend Approval/No Conditions
Development Engineering	Yes 🖂	No 🗆	General Comments w/Conditions
Development Finance	Yes 🗆	No 🖂	General Comments
Forestry	Yes 🗆	No 🖂	General Comments

External Agencies *Comments Received	Conditions	Required	Nature of Comments *See Schedule B for full comments
Alectra	Yes 🗆	No 🖂	General Comments
Region of York	Yes 🗆	No 🗆	No Comments Received to Date
TRCA	Yes 🖂	No 🗆	General Comments w/Conditions

### PUBLIC & APPLICANT CORRESPONDENCE (SEE SCHEDULE C)

All personal information collected because of this public meeting (including both written and oral submissions) is collected under the authority of the Municipal Act, the Municipal Freedom of Information and Protection of Privacy Act (MFIPPA), the Planning Act and all other relevant legislation, and will be used to assist in deciding on this matter. All personal information (as defined by MFIPPA), including (but not limited to) names, addresses, opinions and comments collected will become property of the City of Vaughan, will be made available for public disclosure (including being posted on the internet) and will be used to assist the Committee of Adjustment and staff to process this application.

Correspondence Type	Name	Address	Date Received (mm/dd/yyyy)	Summary
None				

BACKGROUND (SO	CHEDULE D, IF REQUIRED)
* Background Information contains historical	development approvals considered to be related to this file.
This information should	d not be considered comprehensive.
Application No. (City File)	Application Description
	(i.e. Minor Variance Application; Approved by COA / OLT)
N/A	N/A

ADJOUR	NMENT HISTORY
* Previous hearing dates where this application	on was adjourned by the Committee and public notice issued.
Hearing Date	Reason for Adjournment (to be obtained from NOD_ADJ)
N/A	N/A

	SCHEDULES
Schedule A	Drawings & Plans Submitted with the Application
Schedule B	Comments from Agencies, Building Standards & Development Planning
Schedule C (if required)	Public & Applicant Correspondence
Schedule D (if required)	Background



### MINOR VARIANCE APPLICATION FILE NUMBER A013/25

CITY WARD #:	4
APPLICANT:	Benjamin & Orit Smith
AGENT:	Contempo Studio
PROPERTY:	104 Sir Modesto Court, Maple
ZONING DESIGNATION:	See below.
VAUGHAN OFFICIAL PLAN	Vaughan Official Plan 2010 ('VOP 2010'): "Low Rise Residential"
(2010) DESIGNATION:	
RELATED DEVELOPMENT APPLICATIONS:	N/A
PURPOSE OF APPLICATION:	Relief from the Zoning By-law is being requested to permit the construction of a proposed two-storey dwelling, retaining wall, swimming pool, accessory structure (pool mechanical) and uncovered platform.

The following variances have been requested from the City's Zoning By-law:

### The subject lands are zoned R2A Second Density Residential Zone subject to Exception 14.847 and 14.850 under Zoning Bylaw 001-2021.

#	Zoning By-law 001-2021	Variance requested
1	For a lot with a lot frontage greater than 12 m, a maximum driveway width of 9 m is permitted. [6.7.3, Table 6-11]	To permit a maximum driveway width of 10.26 m for a lot with a lot frontage greater than 12 m.
2	A minimum setback of 1.13 m is required from the westerly lot line to the retaining wall (window well). [4.13]	To permit a retaining wall (2 window well) with a height of 1.13 m to be setback a minimum of 0.62 m from the westerly lot line.
3	A maximum height of 3.0 m is permitted for a residential accessory structure. [4.1.4.1]	To permit a residential accessory structure (pool mechanical) with a height of 4.59 m.
4	An uncovered platform (paverstone terrace), with a floor height greater than 1.2 m as measured above grade and including access stairs, is permitted to encroach to a maximum of 2.4 m into the minimum required rear yard of 7.5 m [4.13] A setback of 5.1 m from the rear lot line is required.	To permit an uncovered platform (paverstone terrace) with a height of 2.0 m to encroach to a maximum of 5.28 m into the minimum required rear yard of 7.5 m. A setback of 2.22 m from the rear lot line is proposed.
5	Where the height of an outdoor swimming pool is greater than 1.5 m, the minimum setback from any lot line shall be 3.0 m. [4.21.6]	To permit an outdoor swimming pool with a height of 2.0 m to be setback 2.04 m from the westerly interior side lot line.
6	A minimum setback of 1.1 m is required from the southwesterly lot line to the retaining wall. [4.13]	To permit a retaining wall with a height of 1.1 m to be setback a minimum of 0.82 m from the southwesterly interior side lot line.

### **HEARING INFORMATION**

DATE OF MEETING: Thursday, March 20, 2025 TIME: 6:00 p.m. MEETING LOCATION: Vaughan City Hall, Woodbridge Room (2<sup>nd</sup> Floor), 2141 Major Mackenzie Drive LIVE STREAM LINK: <u>Vaughan.ca/LiveCouncil</u> PUBLIC PARTICIPATION

If you would like to speak to the Committee of Adjustment at the meeting, either remotely or in person, please complete the <u>Request to Speak Form</u> and submit to <u>cofa@vaughan.ca</u>

### HEARING INFORMATION

If you would like to submit written comments, please quote file number above and submit by mail or email to.

### Email: <u>cofa@vaughan.ca</u>

Mail: City of Vaughan, Office of the City Clerk, Committee of Adjustment, 2141 Major Mackenzie Drive, Vaughan, ON, L6A 1T1

To speak electronically, pre-registration is required by completing the **Request to Speak Form** on-line and submitting it to cofa@vaughan.ca no later than NOON on the last business day before the meeting.

### THE DEADLINE TO REGISTER TO SPEAK ELECTRONICALLY OR SUBMIT WRITTEN COMMENTS ON THE ABOVE NOTED FILE(S) IS <u>NOON</u> ON THE LAST BUSINESS DAY BEFORE THE MEETING.

### INTRODUCTION

Staff and Agencies act as advisory bodies to the Committee of Adjustment. The comments contained in this report are presented as recommendations to the Committee.

Section 45(1) of the Planning Act sets the criteria for authorizing minor variances to the City of Vaughan's Zoning By-law. Accordingly, review of the application may consider the following:

That the general intent and purpose of the by-law will be maintained.

That the general intent and purpose of the official plan will be maintained.

That the requested variance(s) is/are acceptable for the appropriate development of the subject lands. That the requested variance(s) is/are minor in nature.

Public written and oral submissions relating to this application are taken into consideration by the Committee of Adjustment as part of its deliberations and final decision on this matter.

COMMITT	EE OF ADJUSTMENT
Date Public Notice Mailed:	March 6, 2025
Date Applicant Confirmed Posting of Sign:	February 28, 2025
Applicant Justification for Variances: *As provided in Application Form	Does not comply with by-laws.
Was a Zoning Review Waiver (ZRW) Form submitted by Applicant: *ZRW Form may be used by applicant in instances where a revised submission is made, and zoning staff do not have an opportunity to review and confirm variances prior to the issuance of public notice.	Yes □ No ⊠
COMMENTS:	
N/A	

Committee of Adjustment Recommended None **Conditions of Approval:** 

### **BUILDING STANDARDS (ZONING)**

\*\*See Schedule B for Building Standards (Zoning) Comments

**Building Standards Recommended Conditions of Approval:** 

None

### **DEVELOPMENT PLANNING**

\*\*See Schedule B for Development Planning Comments.

**Development Planning Recommended** None **Conditions of Approval:** 

### **DEVELOPMENT ENGINEERING**

Link to Grading Permit Link to Pool Permit Link to Curb Curt Permit Link Culvert Installation Development Engineering has already received a grading permit from the Applicant/Owner. The Owner / Applicant shall apply for a 'Pool Grading Permit' with the Development Engineering (DE) Department. Please visit the grading permits page at City of Vaughan website to learn how to apply for the Pool Permit. If you have any question about Pool Grading Permit, please contact the Development Engineering Department through email at DEPermits@vaughan.ca. The Owner/Applicant shall apply and obtain the necessary 'Curb Cut/Reinstating Permit' through the Transportation and Fleet Management Services. Please visit the Curb Cut Permits page at the City of Vaughan website to learn

### **DEVELOPMENT ENGINEERING**

Link to Grading Permit Link to Pool Pe	rmit Link to Curb Curt Permit Link Culvert Installation
how to apply for the Curb Cut/ Reinstating P	ermit. The proposed work by the Owner/Applicant is
increasing the lot coverage on the subject pr	operty. The added hardscape may have impacts on the
City's Storm Water management system. De	evelopment Engineering strongly encourages the Owner /
Applicant introduce Low-Impact Developmer	nt (LID) measures (e.g., bioswales, permeable pavers, rain
gardens, rain barrels etc.) to reduce the impa	acts to the stormwater system. Should further information
be required, please contact the Developmen	t Engineering COA reviewer.
Development Engineering	The Owner/Applicant shall submit an application for a
Recommended Conditions of	Service Connection and to obtain a Cost Estimate by
Approval:	emailing serviceconnections@vaughan.ca. The Final Lot
	Grading and/or Servicing Plan will be required for the
	Service Connection Application. All costs associated with
	the service connection shall be the responsibility of the
	Owner/Applicant. Please visit the Service Connection
	page of the City of Vaughan's website: <u>Service</u>
	Connections   City of Vaughan for more information. The
	Owner/Applicant is encouraged to initiate the process as
	early as possible
	• •

### PARKS, FORESTRY & HORTICULTURE (PFH)

The following property falls under TRCA regulated area, therefore Under Ontario Regulation 166/06, any proposed development, interference, or alteration within the regulated area requires a permit from TRCA. If your property falls within TRCA's Regulated Area, you are advised to discuss your proposal with a TRCA Planner prior to submitting a permit application.

PFH Recommended Conditions of	None
Approval:	

DEVELOPMENT FINANCE
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No comment no concerns.

Development Finance Recommended Conditions of Approval:

None

### **BY-LAW AND COMPLIANCE, LICENSING AND PERMIT SERVICES**

No comments received to date.

BCLPS Recommended Conditions of Approval:

None

None

### **BUILDING INSPECTION (SEPTIC)**

No comments received to date.

Building Inspection Recommended Conditions of Approval:

### FIRE DEPARTMENT

No comments received to date.

Fire Department RecommendedNoneConditions of Approval:

### **RECOMMENDED CONDITIONS OF APPROVAL SUMMARY**

Should the Committee find it appropriate to approve this application in accordance with request and the sketch submitted with the application, as required by Ontario Regulation 200/96, the following conditions have been recommended:

#	DEPARTMENT / AGENCY	CONDITION			
1	TRCA	That the applicant provides the required fee			
	Cameron.McDonald@trca.ca	amount of \$660.00 payable to the Toronto and			
		Region Conservation Authority.			
All co	All conditions of approval, unless otherwise stated, are considered to be incorporated into the approval "if				
reau	required". If a condition is no longer required after an approval is final and binding, the condition may be waived				

**required**". If a condition is no longer required after an approval is final and binding, the condition may be waived by the respective department or agency requesting conditional approval. A condition cannot be waived without written consent from the respective department or agency.

### **IMPORTANT INFORMATION**

**CONDITIONS:** It is the responsibility of the owner/applicant and/or authorized agent to obtain and provide a clearance letter from respective department and/or agency (see condition chart above for contact). This letter must be provided to the Secretary-Treasurer to be finalized. All conditions must be cleared prior to the issuance of a Building Permit.

**APPROVALS:** Making any changes to your proposal after a decision has been made may impact the validity of the Committee's decision.

An approval obtained from the Committee of Adjustment, where applicable, is tied to the building envelope shown on the plans and drawings submitted with the application and subject to the variance approval.

A building envelope is defined by the setbacks of the buildings and/or structures shown on the plans and drawings submitted with the application, as required by Ontario Regulation 200/96. Future development outside of an approved building envelope, where a minor variance was obtained, must comply with the provisions of the City's Zoning By-law.

Elevation drawings are provided to reflect the style of roof (i.e. flat, mansard, gable etc.) to which a building height variance has been applied. Where a height variance is approved, building height is applied to the style of roof (as defined in the City's Zoning By-law) shown on the elevation plans submitted with the application.

Architectural design features that are not regulated by the City's Zoning By-law are not to be considered part of an approval unless specified in the Committee's decision.

**DEVELOPMENT CHARGES:** That the payment of the Regional Development Charge, if required, is payable to the City of Vaughan before issuance of a building permit in accordance with the Development Charges Act and the Regional Development Charges By-law in effect at the time of payment.


That the payment of the City Development Charge, if required, is payable to the City of Vaughan before issuance of a building permit in accordance with the Development Charges Act and the City's Development Charges By-law in effect at the time of payment.

That the payment of the Education Development Charge if required, is payable to the City of Vaughan before issuance of a building permit in accordance with the Development Charges Act and the Boards of Education By-laws in effect at the time of payment

That the payment of Special Area Development charge, if required, is payable to the City of Vaughan before issuance of a building permit in accordance with the Development Charges Act and The City's Development Charge By-law in effect at the time of Building permit issuance to the satisfaction of the Reserves/Capital Department.

**NOTICE OF DECISION:** If you wish to be notified of the decision in respect to this application or a related Ontario Land Tribunal (OLT) hearing you must complete a Request for Decision form and submit to the Secretary Treasurer (ask staff for details). In the absence of a written request to be notified of the Committee's decision you will **not** receive notice.

### SCHEDULE A: DRAWINGS & PLANS

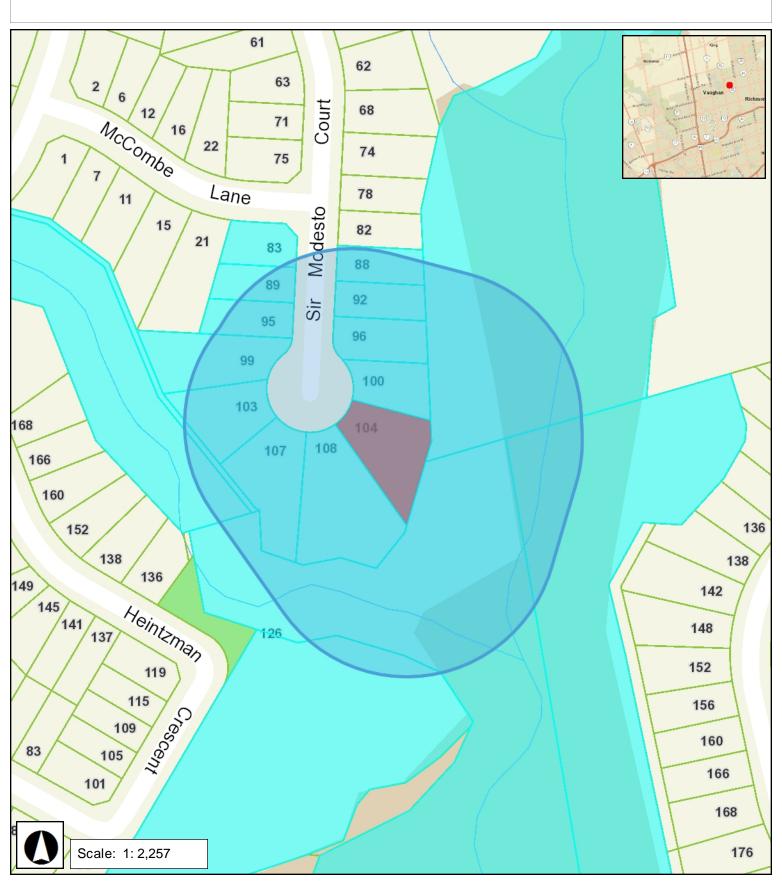

February 3, 2025 2:46 PM





PROJECT:

# 104 SIR MODESTO COURT, VAUGHAN, ON


Project number: 2023-24 Date: DECEMBER, 2024 ISSUED FOR: PERMIT SUBMISSION

### ARCHITECTURAL DESIGN CONTEMPO STUDIO

1140 THE QUEENSWAY Toronto, Ontario M8Z 1P7 info@contempostudio.ca w. contempostudio.ca t. 416 770 0071 f. 416 642 1691

Drawing number:

This drawing, as an instrument of service, is provided by and is the

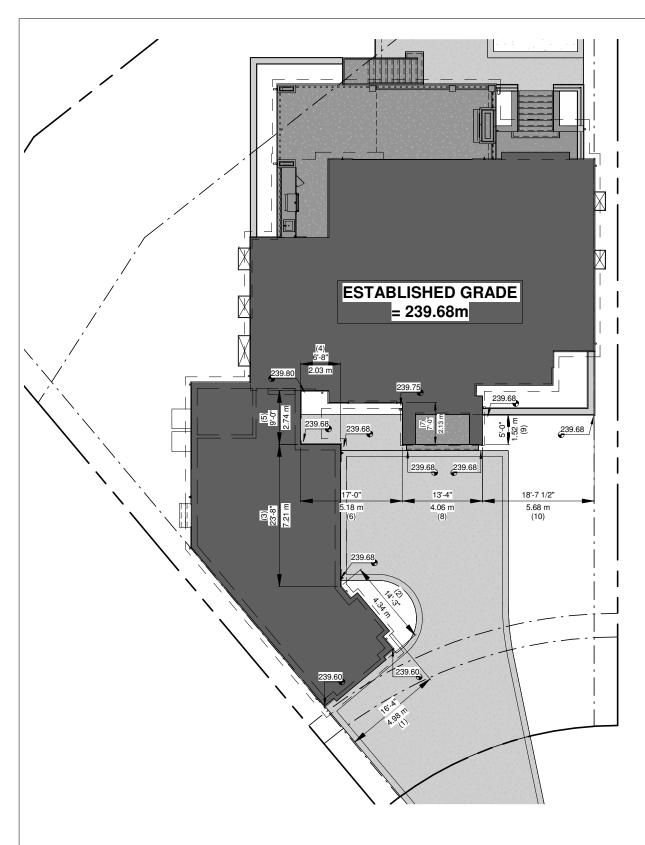


### 2 ESTABLISHED GRADE 1/16" = 1'-0"

Wall Segment	Wall Start Grade	Wall End Grade	Wall Average Grade	Wall Length	Product
1	239.60	239.60	239.60	4.98	1,193.21
2	239.60	239.68	239.64	4.34	1,040.04
3	239.68	239.68	239.68	7.21	1,728.09
4	239.68	239.68	239.68	2.03	486.55
5	239.68	239.80	239.74	2.74	656.89
6	239.80	239.75	239.78	5.18	1,242.03
7	239.75	239.68	239.72	2.13	510.59
8	239.68	239.68	239.68	4.06	973.10
9	239.68	239.68	239.68	1.52	364.31
10	239.68	239.68	239.68	5.68	1,361.38
Total			2,396.87	39.87	9,556.20






Section 1	: Site Management
#	Standard Notes
1	Erosion and Sediment Control (ESC) measures will be implemented prior to, and maintained during the construction phases, to prevent entry of sediment into the water. All damaged erosion and sediment control measures should be repaired and/or replaced within 48 hours of the inspection.
2	Disturbed areas will be minimized to the extent possible, and temporarily or permanently stabilized or restored as the work progresses.
3	All in-water and near-water works will be conducted in the dry with appropriate erosion and sediment controls.
4	The erosion and sediment control strategies outlined on the plans are not static and may need to be upgraded/amended as site conditions change to minimize sediment laden runoff from leaving the work areas. If the prescribed measures on the plans are not effective in preventing the release of a deleterious substance, including sediment, then alternative measures must be implemented immediately to minimize potential ecological impacts. TRCA Enforcement Officer should be immediately contacted. Additional ESC measures to be kept on site and used, as necessary.
	An Environmental Monitor will attend the site to inspect all new controls immediately after installation. Inspection of ESC measures to be will occur, at minimum:
	On a weekly basis;
5	Prior to significant rainfall events (minimum predicted 25mm over 24 hours);
	• After every rainfall/snowmelt event; and D Daily during extended rainfall periods. Inspections will focus on measures related to erosion and sediment controls, dewatering or unwatering, restoration and in- or near- water works. Should concerns arise on site the Environmental Monitor will contact the TRCA Enforcement Officer as well as the proponent.
6	All activities, including maintenance procedures, will be controlled to prevent the entry of petroleum products, debris, rubble, concrete or other deleterious substances into the water. Vehicular refueling and maintenance will be conducted a minimum of 30 metres from the water.
7	All grades within the Regulatory Flood Plain will be maintained or matched.
8	The proponent/contractor shall monitor the weather several days in advance of the onset of the project to ensure that the works will be conducted during favourable weather conditions. Should an unexpected storm arise, the contractor will remove all unfixed items from the Regional Storm Flood Plain that would have the potential to cause a spill or an obstruction to flow, e.g., fuel tanks, porta- potties, machinery, equipment, construction materials, etc.
9	All dewatering/unwatering shall be treated and released to the environment at least 30 metres from a watercourse or wetland and allowed to drain through a well-vegetated area. No dewatering effluent shall be sent directly to any watercourse, wetland or forest, or allowed to drain onto disturbed soils within the work area. These control measures shall be monitored for effectiveness and maintained or revised to meet the objective of preventing the release of sediment laden water.
10	All access to the work site shall be from either side of the watercourse. No equipment or vehicles are permitted to cross through the watercourse unless approved by TRCA.
Section 2 agencies)	: Construction Timing Best Management Practices (the proponent/contractor should confirm directly with applicable provincial and federal
11	Prior to site disturbance the contractor/proponent should ensure that the works are in conformance with the <i>Migratory Birds Convention</i> <i>Act</i> . Please note that the general breeding bird timing window for this area is April 1st to August 31st, however, breeding activities might initiate prior to and continue past this period.
12	Where impacts to local fish populations may occur during their spawning, nursery and migratory periods, construction timing windows should apply to in-water or near-water activities. The proponent/contractor should confirm applicability and dates with appropriate provincial and federal agencies.
Section 3	Fish and Wildlife Relocation
13	Fish and wildlife stranded within the work area shall be captured and released live in suitable habitat upstream of the work area under the supervision of qualified aquatic technical staff. The proponent/contractor should confirm requirements directly with Ministry of Natural Resources and Forestry.
Section 4	Environmental Compliance
14	Please notify TRCA Enforcement Officer (xxx at 416.661-6600, ext. xxxx, email), and TRCA Project Manager (xxx at 416.661.6600, ext. xxxx, email) 48 hours prior to commencing construction.
15	An Environmental Monitor will be on site, and provide advice, to ensure that activities that could have a negative impact to the natural environment are effectively mitigated as construction proceeds. The Environmental Monitor shall notify the TRCA Enforcement Officer and Project Manager if issues arise.

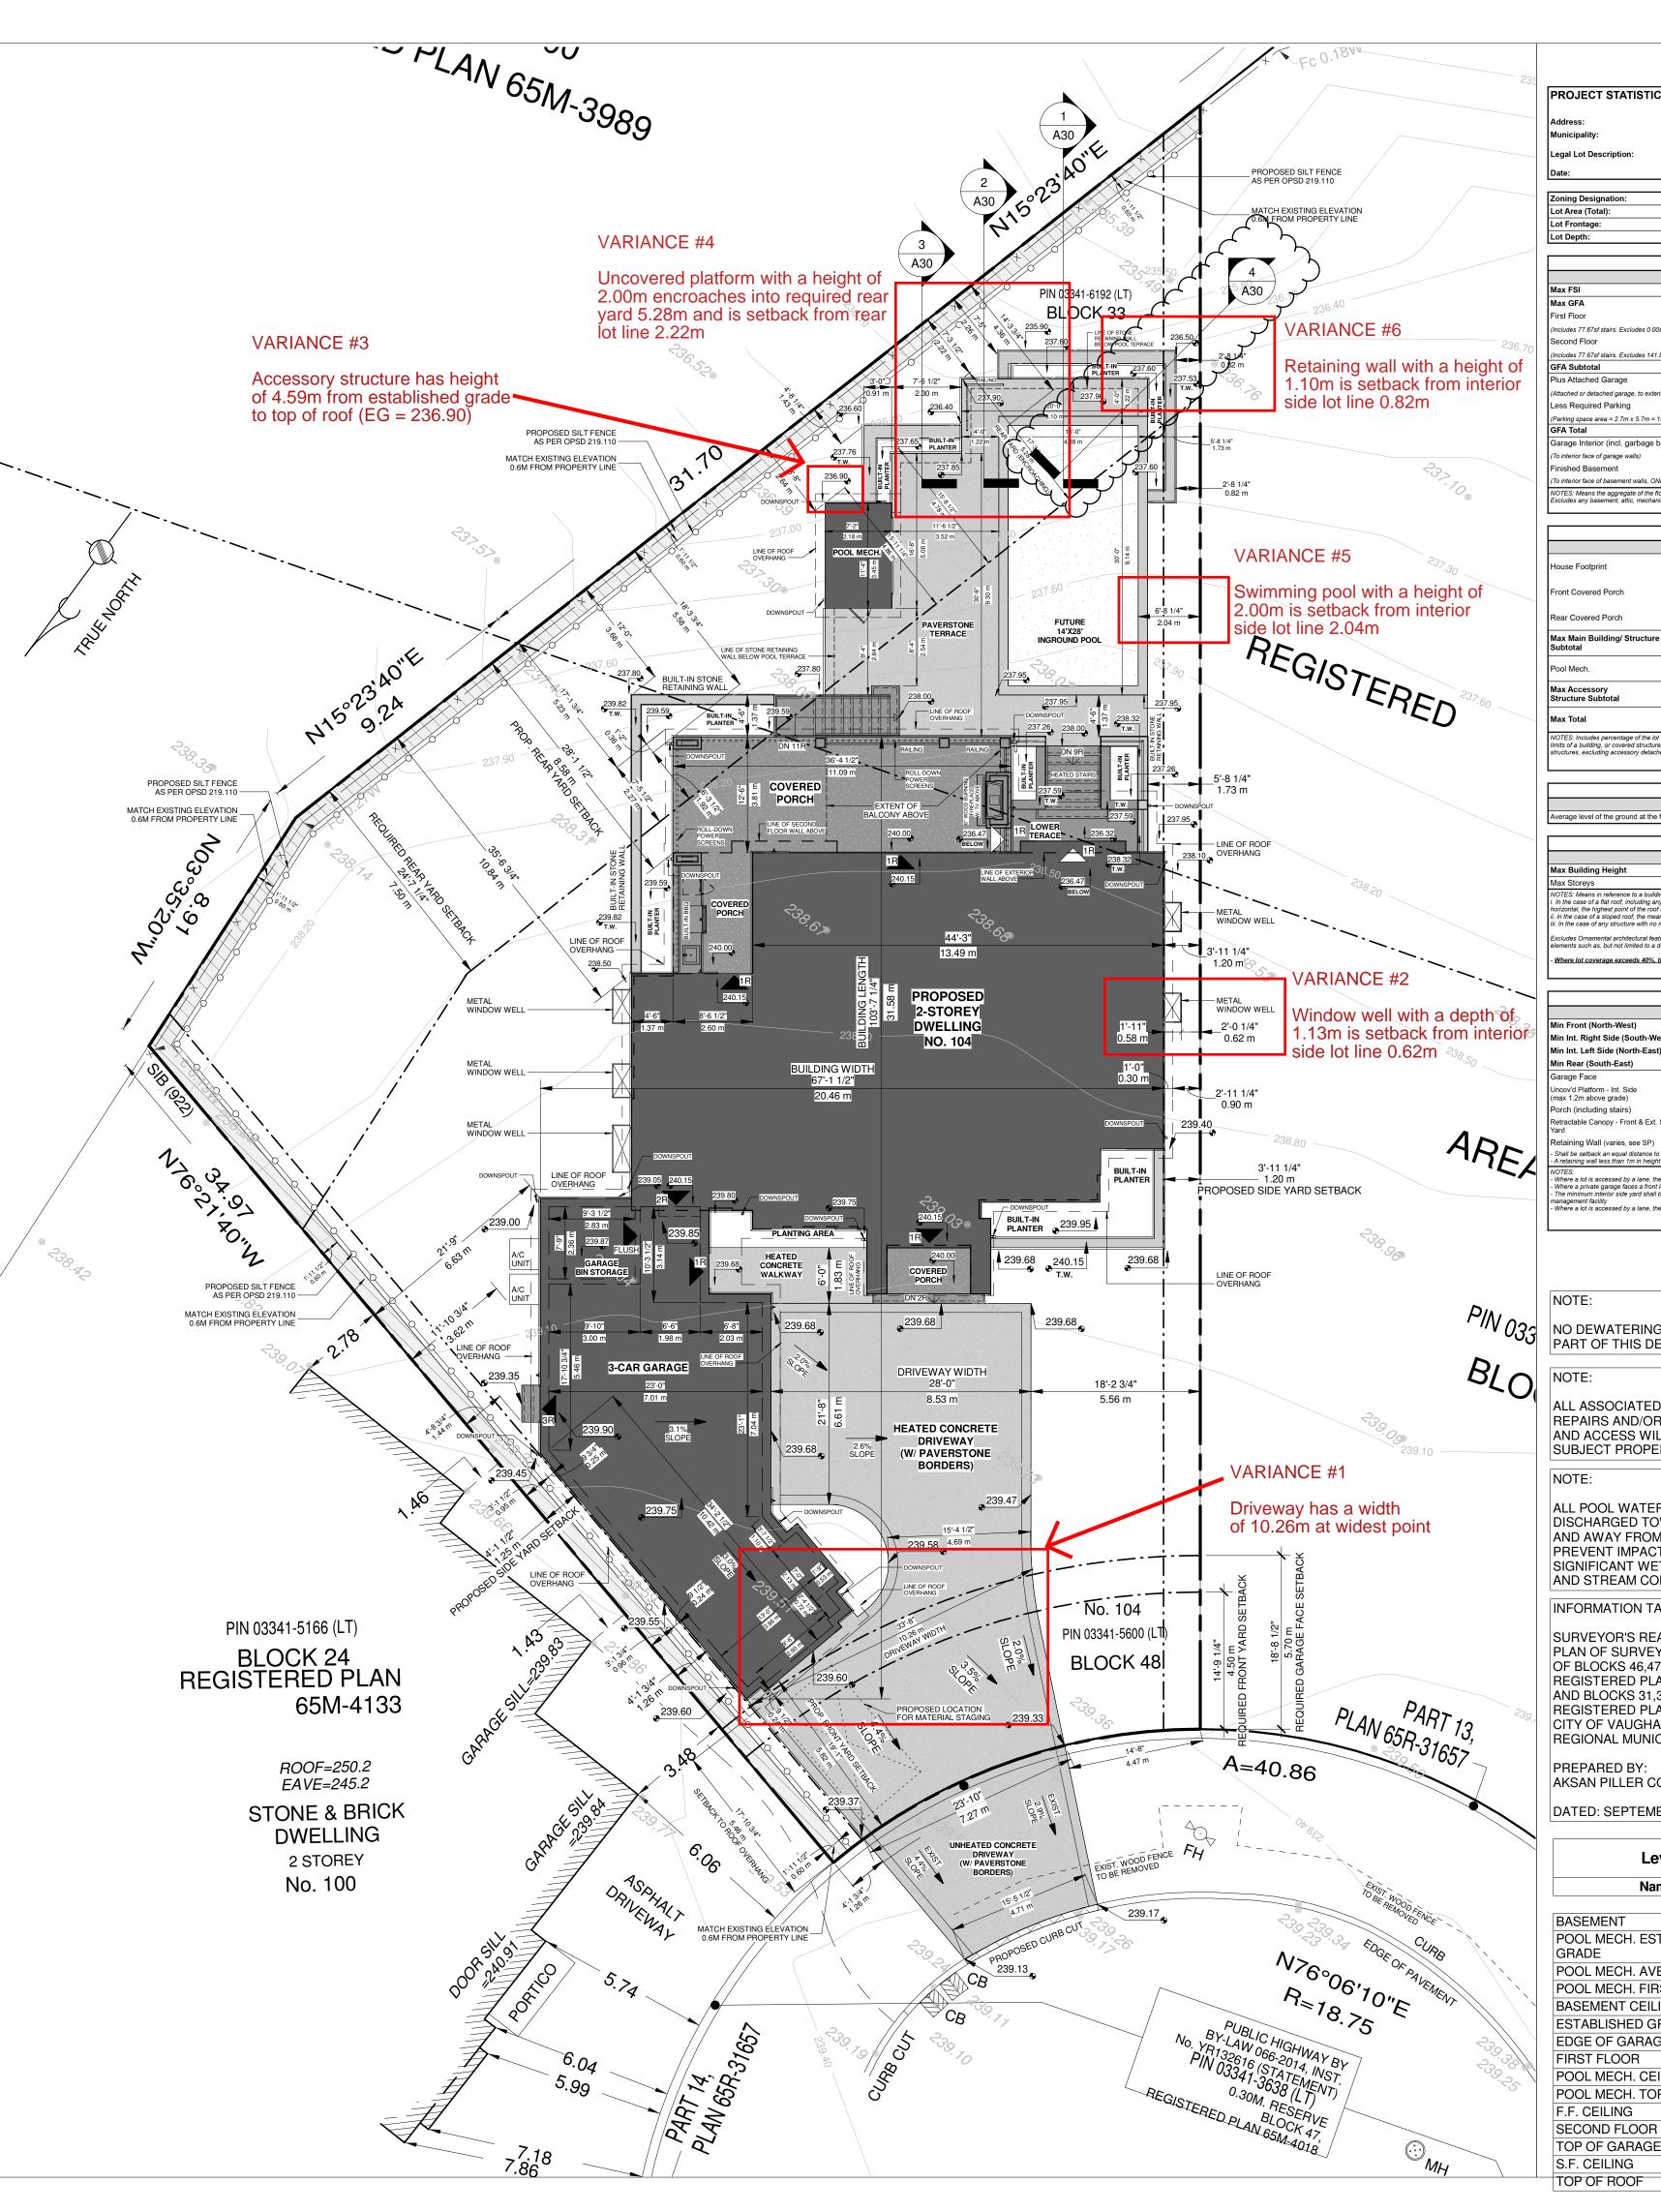

### 1 SITE PLAN 1" = 10'-0"

							property of Conterr responsibility for all notify Contempo S	n instrument of service, is provide npo Studio. The contractor must I dimensions and conditions on si tudio of any variations from the su	rerify and accept e and must
ATISTICS 104 Sir Modesto Cour	t, Vaughan ON		Total Front Yard Area (Contains D Total Front Yard Area	LANDSCAPE AREA Permitted Driveway)	A Propos 2,812.02 sq.f	ed 261.25 m2	information. This drawing is not		
York Block 33, Registered I	Plan 65M-4243	TRCA Heritage ORM	Excluding Porch & Steps Driveway/Ramp		57.00 sq.f 1,331.80 sq.f	5.30 m2 123.73 m2	mechanical, electri to the appropriate of	t responsible for the accuracy of s cal, etc., information shown on th consultant's drawings before proc n must conform to all applicable co	s drawing. Refer eeding with the
12/31/2024 : R2A (847, 850)			Total Front Yard Landscaping Area Less Hardscaping	130.62 m2 50.00%	1,423.22 sq.f	132.22 m2 50.61%	working from draw	thorities having jurisdiction. The c ings not specifically marked 'for c isibility and bear costs for any corr from his work	onstruction' must
12,650.54 sq 57.54 ft 142.92 ft	t 17.54 m	0.12 ha	Walkway Patios/Terraces Retaining Walls	78.37 m2	96.00 sq.f 0.00 sq.f 28.25 sq.f 1,298.97 sq.f	8.92 m2 0.00 m2 2.62 m2 120.68 m2	The copyright of th may not be reprodu	is drawing is vested in Contempo uced in whole or part or used for	he manufacture
GROSS FLOOR AR Permitted		posed	Total Front Yard Softscaping Area Total Rear Yard Area (greater than Total Rear Yard Area	60.00%	5,619.06 sq.f	92.39%	or any anicle without	ut the express written permission.	
N/A	-	.38 191.84 m2	Excluding Porch & Steps Lower Terrace		629.48 sq.f 134.72 sq.f	58.48 m2 12.52 m2			
xcludes 0.00sf OTB, 24.58sf elevator, & 0.00sf	mech room) 2,015.02 sq.f	187.20 m2	Total Rear Yard Landscaping Area Less Hardscaping		4,854.86 sq.f	451.03 m2 86.40%			
xcludes 141.84sf OTB, 24.58sf elevator, & 26.7 e	4,079.96         sq.f           1,062.40         sq.f	<b>379.04 m2</b> 98.70 m2	Walkway Pool Terrace Pool Mech. Retaining Walls		0.00 sq.f 588.16 sq.f 81.22 sq.f 134.89 sq.f	0.00 m2 54.64 m2 7.55 m2 12.53 m2			
age, to exterior face of garage walls) 1g m x 5.7m = 15.39sm each. Min 2 spaces per dv		30.78 m2	Pool Coping Total Rear Yard Softscaping Area	313.22 m2 60.00%	88.00 sq.f 3,962.59 sq.f	8.18 m2 368.14 m2 70.52%			
arbage bin storage) walls)	<b>4,811.05 sq.f</b> 938.23 sq.f	446.96 m2 87.16 m2	NOTES: In the R1, R1A, R1B, R1C, R1D, R1E, R2, R 60% soft landscape. In Residential Zone, except for RM Zones th	e following requirements shall appl	y to the yard in which a drive	way is located:			
ent walls, ONLY finished basement spaces) gate of the floor areas of all storeys of a building tic, mechanical room, electrical room, elevator			a. Where lot frontage is between 6.0 m and b. Where lot frontage is 12.0 m or greater, or of which 60% shall be soft landscaping. Hard landscape = artificial turf, unit pavers, p used to enhance the visual amenity of a prop	where lot contains circular drivewa patio stones, concrete, decorative s perty	ay, the min. landscape require tonework or other arch. elem	ement shall be 50%, ents designed and			
LOT COVERA			Soft landscape = open land used for grass, † materials.	lowers, shrubs, trees, and similar v	egetation, and may include g	ranular geological			
Permitted	<b>Prop</b> 3,277.51 sq.f	304.49 m2 25.91%	Min Driveway Width	EXTERIOR Permitted 2.90 m	Dropos			= #1	
	45.00 sq.f 440.52 sq.f	4.18 m2 0.36% 40.93 m2	Max Driveway Width Circular Driveway Cumulative Access Width	9.00 m Not Permitted	33.67 ft N/A ft	10.26 m N/A m		nas a width	
Structure	3,763.03 sq.f	3.48% 349.60 m2 29.75%	Max Number of Driveways Min Parking Spaces NOTES: - driveway must be a stable surface and tree paving surface, or a similar material. Circula	1.00 2.00	1.00 3.00 vaterial, such as asphalt, conc	crete, permeable		at widest point	
07.00	81.22 sq.f	7.55 m2	- In a Residential Zone, a circular driveway s		a minimum lot frontage of 18	.0 m.			
67.00 m 5.70% 646.40 m		7.55 m2 0.64% 357.14 m2	Access Stairs, Open, Unenclosed	Permitted	Propos 0.00 ft	ed 0.00 m			
55.00% age of the lot covered by all buildings / structure red structure, and excludes eaves and gutters. ssory detached garage, shall be 10% or 67.0 m	The maximum lot coverage of		Front, Rear, Ext. Side Yard Air Conditioner Window Mount - Any Yard	1.80 m	0.00 ft N/A ft	0.00 m N/A m			
ESTABLISHED G	GRADE	]	Ground - Int. Side Yard Ground - Rear / Ext. Side Ground - Front Yard	1.00 m 1.50 m 0.00 m	0.00 ft N/A ft N/A ft	0.00 m N/A m N/A m			
bund at the front of a building or structure		Est. Grade 239.68	Wall Mount - Int. Side Yard Wall Mount - Rear / Ext. Side Wall Mount - Front Yard Awning / Canopy	0.60 m 1.00 m Not Permitted m	N/A ft N/A ft N/A ft	N/A m N/A m N/A m		locued to a	
BUILDING HEI	Prop	oosed	Awning / Canopy Attached - Any Yard Retractable - Front Yard	0.60 m 0.60 m Up to 0.6 from lot line	1.19 ft N/A ft	0.36 m N/A m	No. 1.	Issued for:	Date
t 11.00 n N/A ce to a building or structure, the vertical distanc including any roof where more than half of the	2. ce measured from established g roof area has a slope of 15 deg		Retractable - Ext. Side Yard Retractable - Rear Yard Retractable - Int. Side Yard	Up to 0.6 from lot line 1.00 m 1.80 m 0.00 m	N/A ft N/A ft N/A ft	N/A m N/A m N/A m	2.		
nt of the roof surface or parapet, whichever is the oof, the mean height between the eaves and th ture with no roof, the highest point of the structu ittectural features (includes belt courses, colum	he greater; he ridge; or, ure.		Balcony Front, Rear, Ext. Side Yard Int. Side Yard	1.50 m 0.00 m	0.00 ft 0.00 ft	0.00 m 0.00 m			
limited to a dome or skylight); chimney; flagpole eeds 40%, the maximum permitted height s			Chimney / Fireplace Enclosure Any Yard Uncovered Platform w/ Height < o	1	-	N/A m			
SETBACKS		posed	Int. Side Yard Rear / Ext. Side Yard Front Yard	0.60 m Up to 0.6 from lot line 2.40 m Not Permitted m	N/A ft N/A ft N/A ft	N/A m N/A m N/A m			
est) 4.50 n South-West) 1.20 n	n 19.09 ft	5.82 m 1.20 m 1.25 m	Uncovered Platform w/ Height > 1 Rear Yard Front, Int. & Ext. Side Yard			5.28 m N/A m	SEAL		
st) 7.50 n 5.70 n	n 28.15 ft	8.58 m 5.82 m	Eaves / Gutters Any Yard Ornamental Building Feature	0.50 m	1.00 ft	0.30 m			
Side         0.60         n           s)         1.20         n           ront & Ext. Side         0.60         n	n 48.36 ft	N/A m 14.74 m N/A m	Any Yard Porch, Including Access Stairs Front, Rear & Ext. Side Yard	2.00 m	6.29 ft	N/A m 1.92 m	VARIAN	CE #3	
i, see SP) VARIES n I distance to the height of the highest portion or 1m in height is permitted to be 0.0m lot line	n VARIES ft	N/A m VARIES m	Int. Side Yard Window Projection Any Yard	Not Permitted m	N/A ft N/A ft	N/A m N/A m	Accessor	ry structure has h	eight
by a lane, the minimum lot frontage shall be 12. aces a front lot line or an exterior side lot line, t e yard shall be 3.5 m where the interior side lot	the minimum setback to the priv		Accessory Structure	CCESSORY STRUCT	JRES Propos	ed	to top of	from established roof	grade
by a lane, the minimum lot frontage shall be 9.0	<sup>1</sup> m and the minimum rear yard	I shall be 13.0m.	Max # of Accessory Bldgs. (Max 3 allow Max Coverage	3.00 red, excluding any detached private 67.00 m2	1.00 garage or carport) 81.22 sq.f	7.55 02			
			(total of all accessory) Max Height A residential accessory structure with a bail cases, a residential accessory structure shall	5 70% 3.00 m In the protect of the form	15.06 ft	0.6 4.59 m ny let line. In all other	cont	empo s	studio
			Min Front Setback Min Int. Side Setback Min Rear Setback	4.50 m 2.40 m 2.40 m	N/A ft 33.23 ft 8.67 ft	N/A m 10.13 m 2.64 m	1140 The Qu	ueensway, Toronto, Ont mpostudio.ca w. contem	ario M8Z 1P7
ERING IS PROPOSED HIS DEVELOPMENT	AS		NOTES: An accessory building / structure sh building on the lot, except where explicitly pe yard requirements for the principal building. must be min. 0.6m to any lot line	ermitted by this By-law. It is subject	to the min. front yard, int. side	e yard and ext. side		16) 770-0071 f. (416) 6	
				OUTDOOR POOL Permitted	Propos				
			Max Height Min Int. Side Setback Min Rear Setback NOTES: only permitted in rear yard. Not per	2.00 m 3.00m m 3.00m m 3.00m m	2.00m 6.69 ft 14.31 ft	2.04 m 4.36 m	The undersigned	has reviewed and takes respon	sibility for this
ND/OR REPLACEMEN SS WILL OCCUR ON TI ROPERTY			>1.5m, then int. side & rear yard setbacks to	be 3.0m	nao yara iot into intari main ne	ude. In height of poor	design, and has t	the qualifications and meets the ing Code to design the work sho	requirements set out in
			VARIANCE #5		ight of		Required unless the Ontario Buildi	QUALIFICATION INFORM	
VATER IS TO BE ED TOWARDS THE RC	DAD		Swimming poo 2.00m is setba side lot line 2.0	ick from int			MARIN ZABZUN	hann	45250 BCIN
FROM THE REAR YAF MPACTS TO PROVINC IT WETLAND, FLOOD	IALLY			74111				REGISTRATION INFORMA design is exempt under 3.2.4.7.	-
MCORRIDOR							of the Ontario Bu CONTEMPO ST FIRM NAME		46972 BCIN
ON TAKEN FROM: 'S REAL PROPERTY F	EPORT								
JRVEY 5 46,47 & 48							PRO	POSED 2-STOREY DW	ELLING
ED PLAN 65M-4184 (S 31,32 & 33 ED PLAN 65M-4243		Γ		_		1	104 01		
UGHAN MUNICIPALITY OF YO	RK							R MODESTC VAUGHAN, (	
BY: ER CORPORATION L <sup>-</sup>	TD		FOOT BUILT LAND	PRINT	(HOUSE, CABANA) (PORCH, DECK, STEP, PLANTI			~ <b>~ ~ • ,</b> `	
PTEMBER 8, 2023		¥ * * *	SOFT	LANDSOALING	(DRIVEWAY, WALKWAY, ADDF	neosi WALL,		SITE PLAN	
Level Schedule	]							_	
Name	Elevation	· ·	SETB/ S EXIST	ING					
	236.47	162	2.45 ELEMI ELEMI EXIST	ENTS EREMOVED ING GRADE					
H. ESTABLISHED	236.90 237.65		манк 62.45 👝	OSED GRADE				N	
H. AVERAGE GRADE H. FIRST FLOOR CEILING	237.65 238.11 239.47				7		Project numbe	r	2023-24
ED GRADE	239.68 239.68		MAIN LEVEL EXIT	$\checkmark$	LOWER LEVEL I	EXIT	Project number Rev. no.: Scale: Date:		2023-24 As indicated JANUARY, 2025
DR H. CEILING	239.88 240.15 240.70			$\mathbf{x}$			Date: Drawn by: Approved by:		JANUARY, 2025 J.T. + M.R M.Z.
H. TOP OF ROOF G	240.70 241.49 243.50				PROPOSES		Drawing number	er:	
LOOR RAGE	243.50 243.91 246.22	EXISTI TREES			PROPOSED TREES				<b>A</b> 1
RAGE G OF	246.22 246.96 249.22								- 1
	L7J.22								

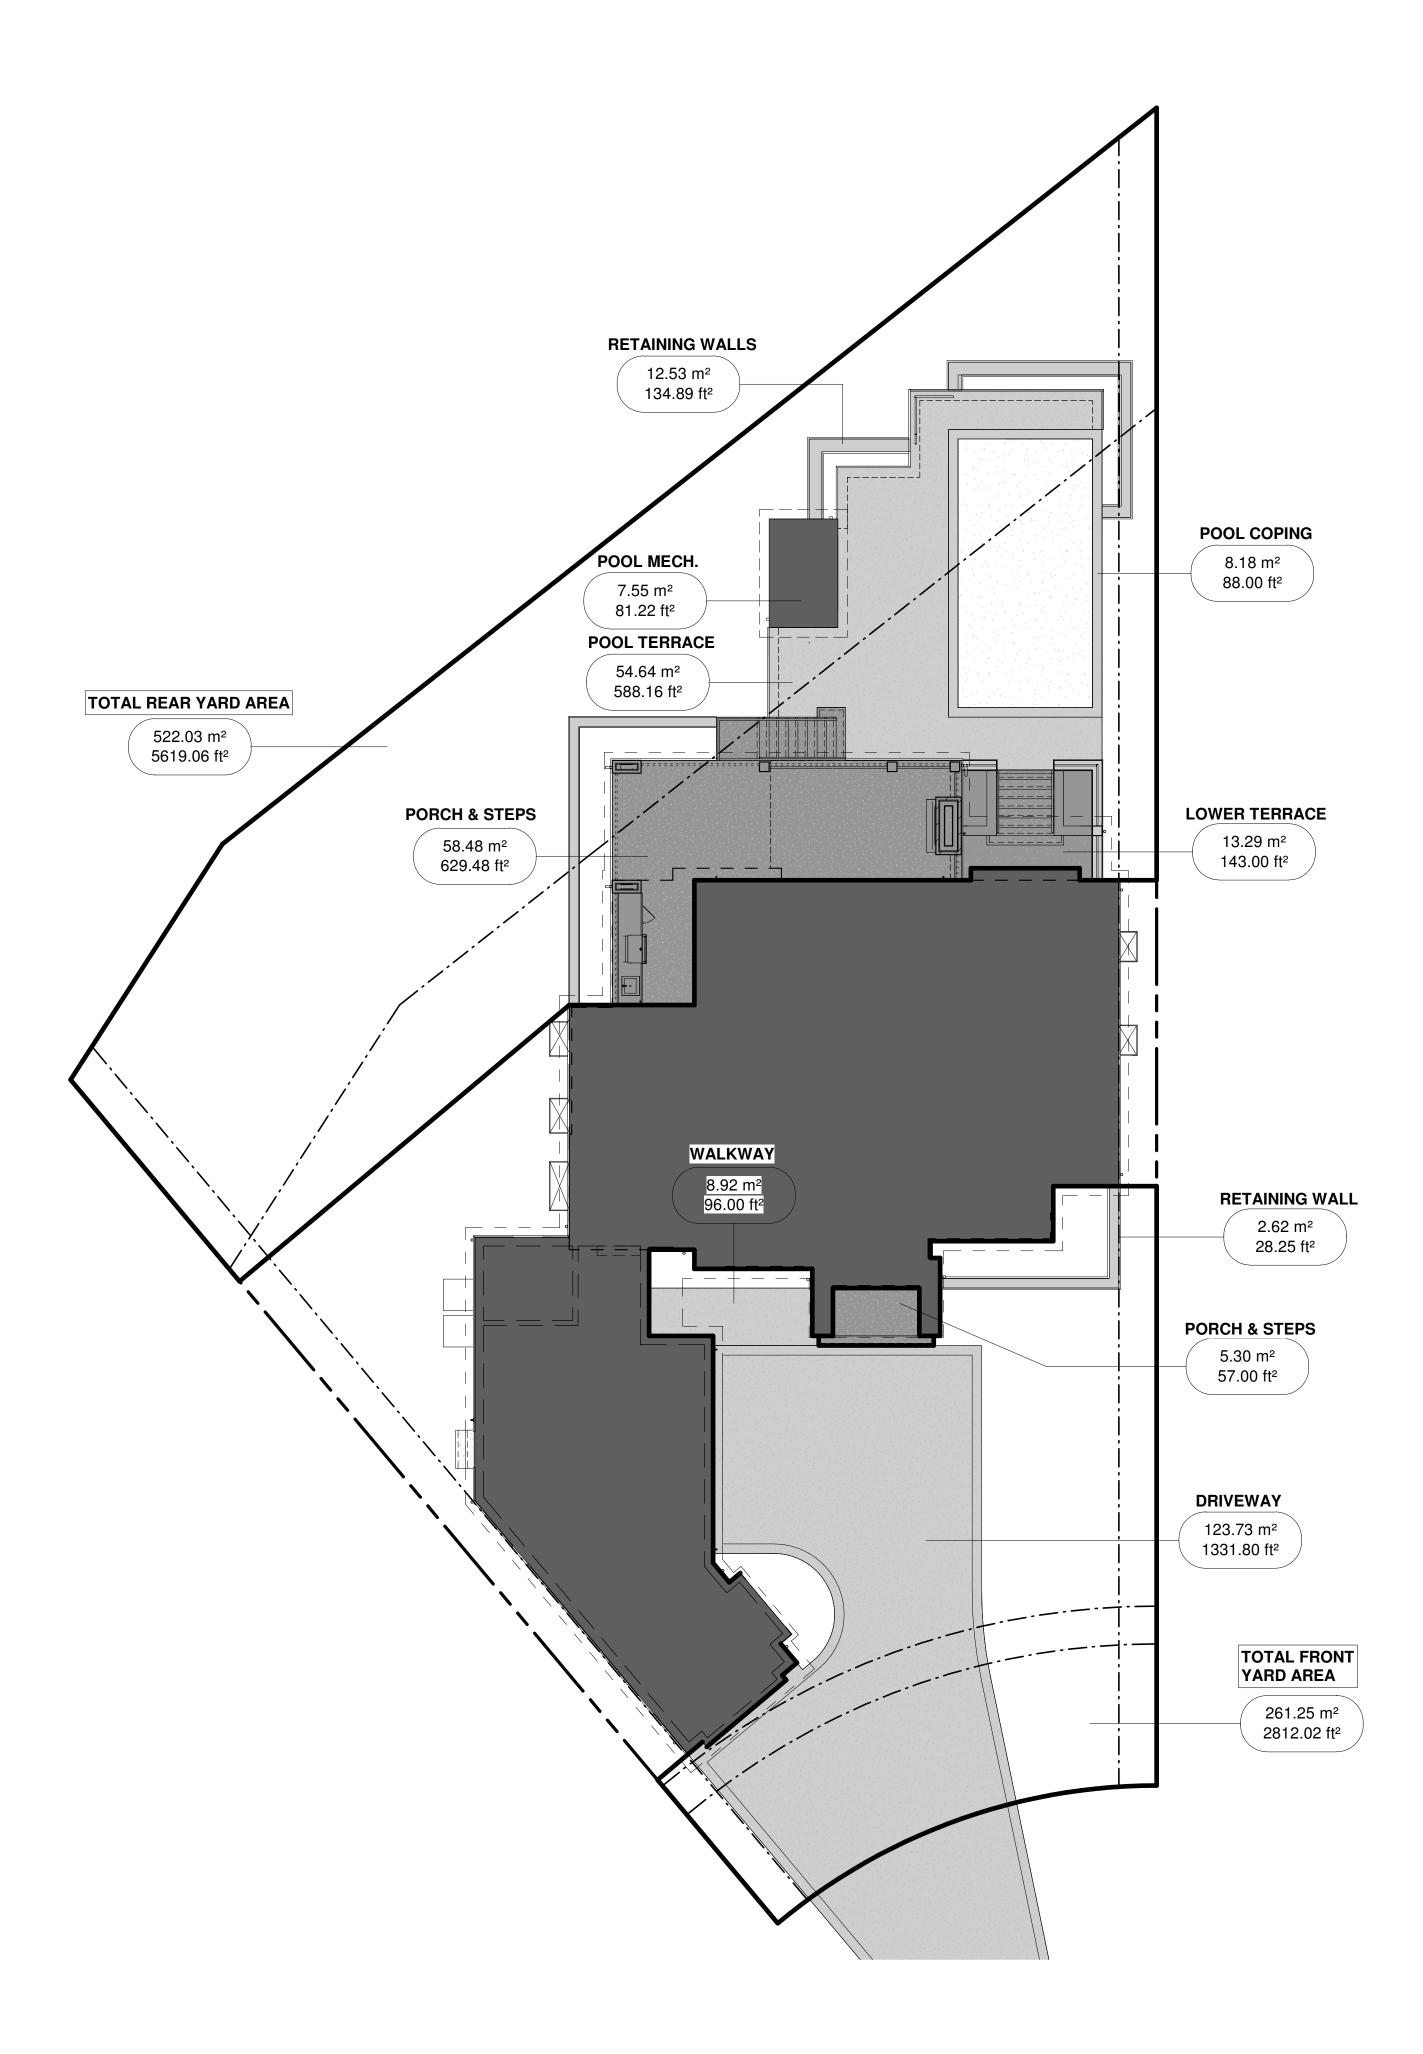

1 LANDSCAPE DIAGRAM 1" = 10'-0"

		LAN
		l
Total Front Yard Area (Con	tains D	riveway
Total Front Yard Area		
Excluding		
Porch & Steps		
Driveway/Ramp		
Total Front Yard Landscaping Area		13(
Less Hardscaping		
Walkway		
Patios/Terraces		
Retaining Walls		
Total Front Yard Softscaping Area		78
Total Rear Yard Area (great	ter than	132.00
Total Rear Yard Area		
Excluding		
Porch & Steps		
Lower Terrace		
Total Rear Yard Landscaping Area		
Less Hardscaping		
Walkway		
Pool Terrace		
Pool Mech.		
Retaining Walls		
Pool Coping		
Total Rear Yard Softscaping Area		313
NOTES: In the R1, R1A, R1B, R1C, R1D, R <sup>-1</sup> 60% soft landscape.	1E, R2, R2	2A, R3, R4
In Residential Zone, except for RM a. Where lot frontage is between 6.0 b. Where lot frontage is 12.0 m or g of which 60% shall be soft landscap	0 m and 1 reater, or	1.99 m, the
Hard landscape = artificial turf, unit	pavers, pa	atio stones

Hard landscape = artificial turf, unit pavers, patio stones, concrete, decorative stonework or other arch. elements designed and used to enhance the visual amenity of a property Soft landscape = open land used for grass, flowers, shrubs, trees, and similar vegetation, and may include granular geological materials.

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ANDSCAPE ARE	A			
Permitted		Prop	oosed	
way)				
	2,812.02	sq.f	261.25	m2
	57.00	sq.f	5.30	m2
	1,331.80	sq.f	123.73	m2
130.62 m2	1,423.22	sq.f	132.22	m2
50.00%			50.61%	
	96.00	sq.f	8.92	m2
	0.00	sq.f	0.00	m2
	28.25	sq.f	2.62	m2
78.37 m2	1,298.97	sq.f	120.68	m2
60.00%			92.39%	
2.00 m2)				
	5,619.06	sq.f	522.03	m2
	629.48	sq.f	58.48	m2
	134.72	sq.f	12.52	m2
	4,854.86	sq.f	451.03	m2
			86.40%	
	0.00	sq.f	0.00	m2
	588.16	sq.f	54.64	m2
	81.22	sq.f	7.55	m2
	134.89	sq.f	12.53	m2
	88.00	sq.f	8.18	m2
313.22 m2	3,962.59	sq.f	368.14	m2
60.00%			70.52%	

3, R4, R5 & RT Zones, any portion of a yard in excess of 135.0 m2 must be min


wing requirements shall apply to the yard in which a driveway is located: n, the min. landscape shall be 33%, of which 60% shall be soft landscape. lot contains circular driveway, the min. landscape requirement shall be 50%,

No. Issued for: Date SEAL **contempo**studio 1140 The Queensway, Toronto, Ontario M8Z 1P7 info@contempostudio.ca w. contempostudio.ca t. (416) 770-0071 f. (416) 642-1691 The undersigned has reviewed and takes responsibility for this design, and has the qualifications and meets the requirements set out in the Ontario Building Code to design the work shown on the attached documents: QUALIFICATION INFORMATION Required unless design is exempt under 3.2.4.3.(5) Division C of the Ontario Building Code.
MARIN ZABZUNI
45 MARIN ZABZUNI 45250 SIGNATURE NAME BCIN REGISTRATION INFORMATION Required unless design is exempt under 3.2.4.7. Division C of the Ontario Building Code. CONTEMPO STUDIO 46972 FIRM NAME BCIN PROPOSED 2-STOREY DWELLING 104 SIR MODESTO COURT, VAUGHAN, ON LANDSCAPE DIAGRAM Project number: Rev. no.: Scale: Date: Drawn by: 2023-24 1" = 10'-0" JANUARY, 2025 J.T. + M.R Approved by: M.Z.


Permitted Proposed				sed		
Max FSI	N/A		0.38			
Max GFA						
First Floor		2,064.94	sq.f	191.84	m2	
(Includes 77.67sf stairs. Excludes 0.00sf OT	B, 24.58sf elevator, & 0.00sf n	nech room)				
Second Floor		2,015.02	sq.f	187.20	m2	
(Includes 77.67sf stairs. Excludes 141.84sf OTB, 24.58sf elevator, & 26.75sf mech room)						
GFA Subtotal		4,079.96	sq.f	379.04	m2	
Plus Attached Garage	1,062.40	sq.f	98.70	m2		
(Attached or detached garage, to exterior fac	ce of garage walls)					
Less Required Parking		331.31	sq.f	30.78	m2	
(Parking space area = 2.7m x 5.7m = 15.39s	sm each. Min 2 spaces per dw	elling unit required)				
GFA Total	N/A	4,811.05	sq.f	446.96	m2	
Garage Interior (incl. garbage bin st	torage)	938.23	sq.f	87.16	m2	
(To interior face of garage walls)						
Finished Basement	2,278.45	sq.f	211.67	m2		
(To interior face of basement walls, ONLY fin						

	LOT COVE	RAGE				
	Permitted			Prop	osed	
			3,277.51	sq.f	304.49	m2
House Footprint					25.91%	
Front Covered Porch			45.00	sq.f	4.18	m2
					0.36%	
Rear Covered Porch			440.52	sq.f	40.93	m2
					3.48%	
Max Main Building/ Structure			3,763.03	sq.f	349.60	m2
Subtotal					29.75%	
Pool Mech.			81.22	sq.f	7.55	m2
Max Accessory	67.00	m2	81.22	sq.f	7.55	m2
Structure Subtotal	5.70%			263	0.64%	
Max Total	646.40	m2	3,844.25	sq.f	357.14	m2
Max Total	55.00%				30.39%	



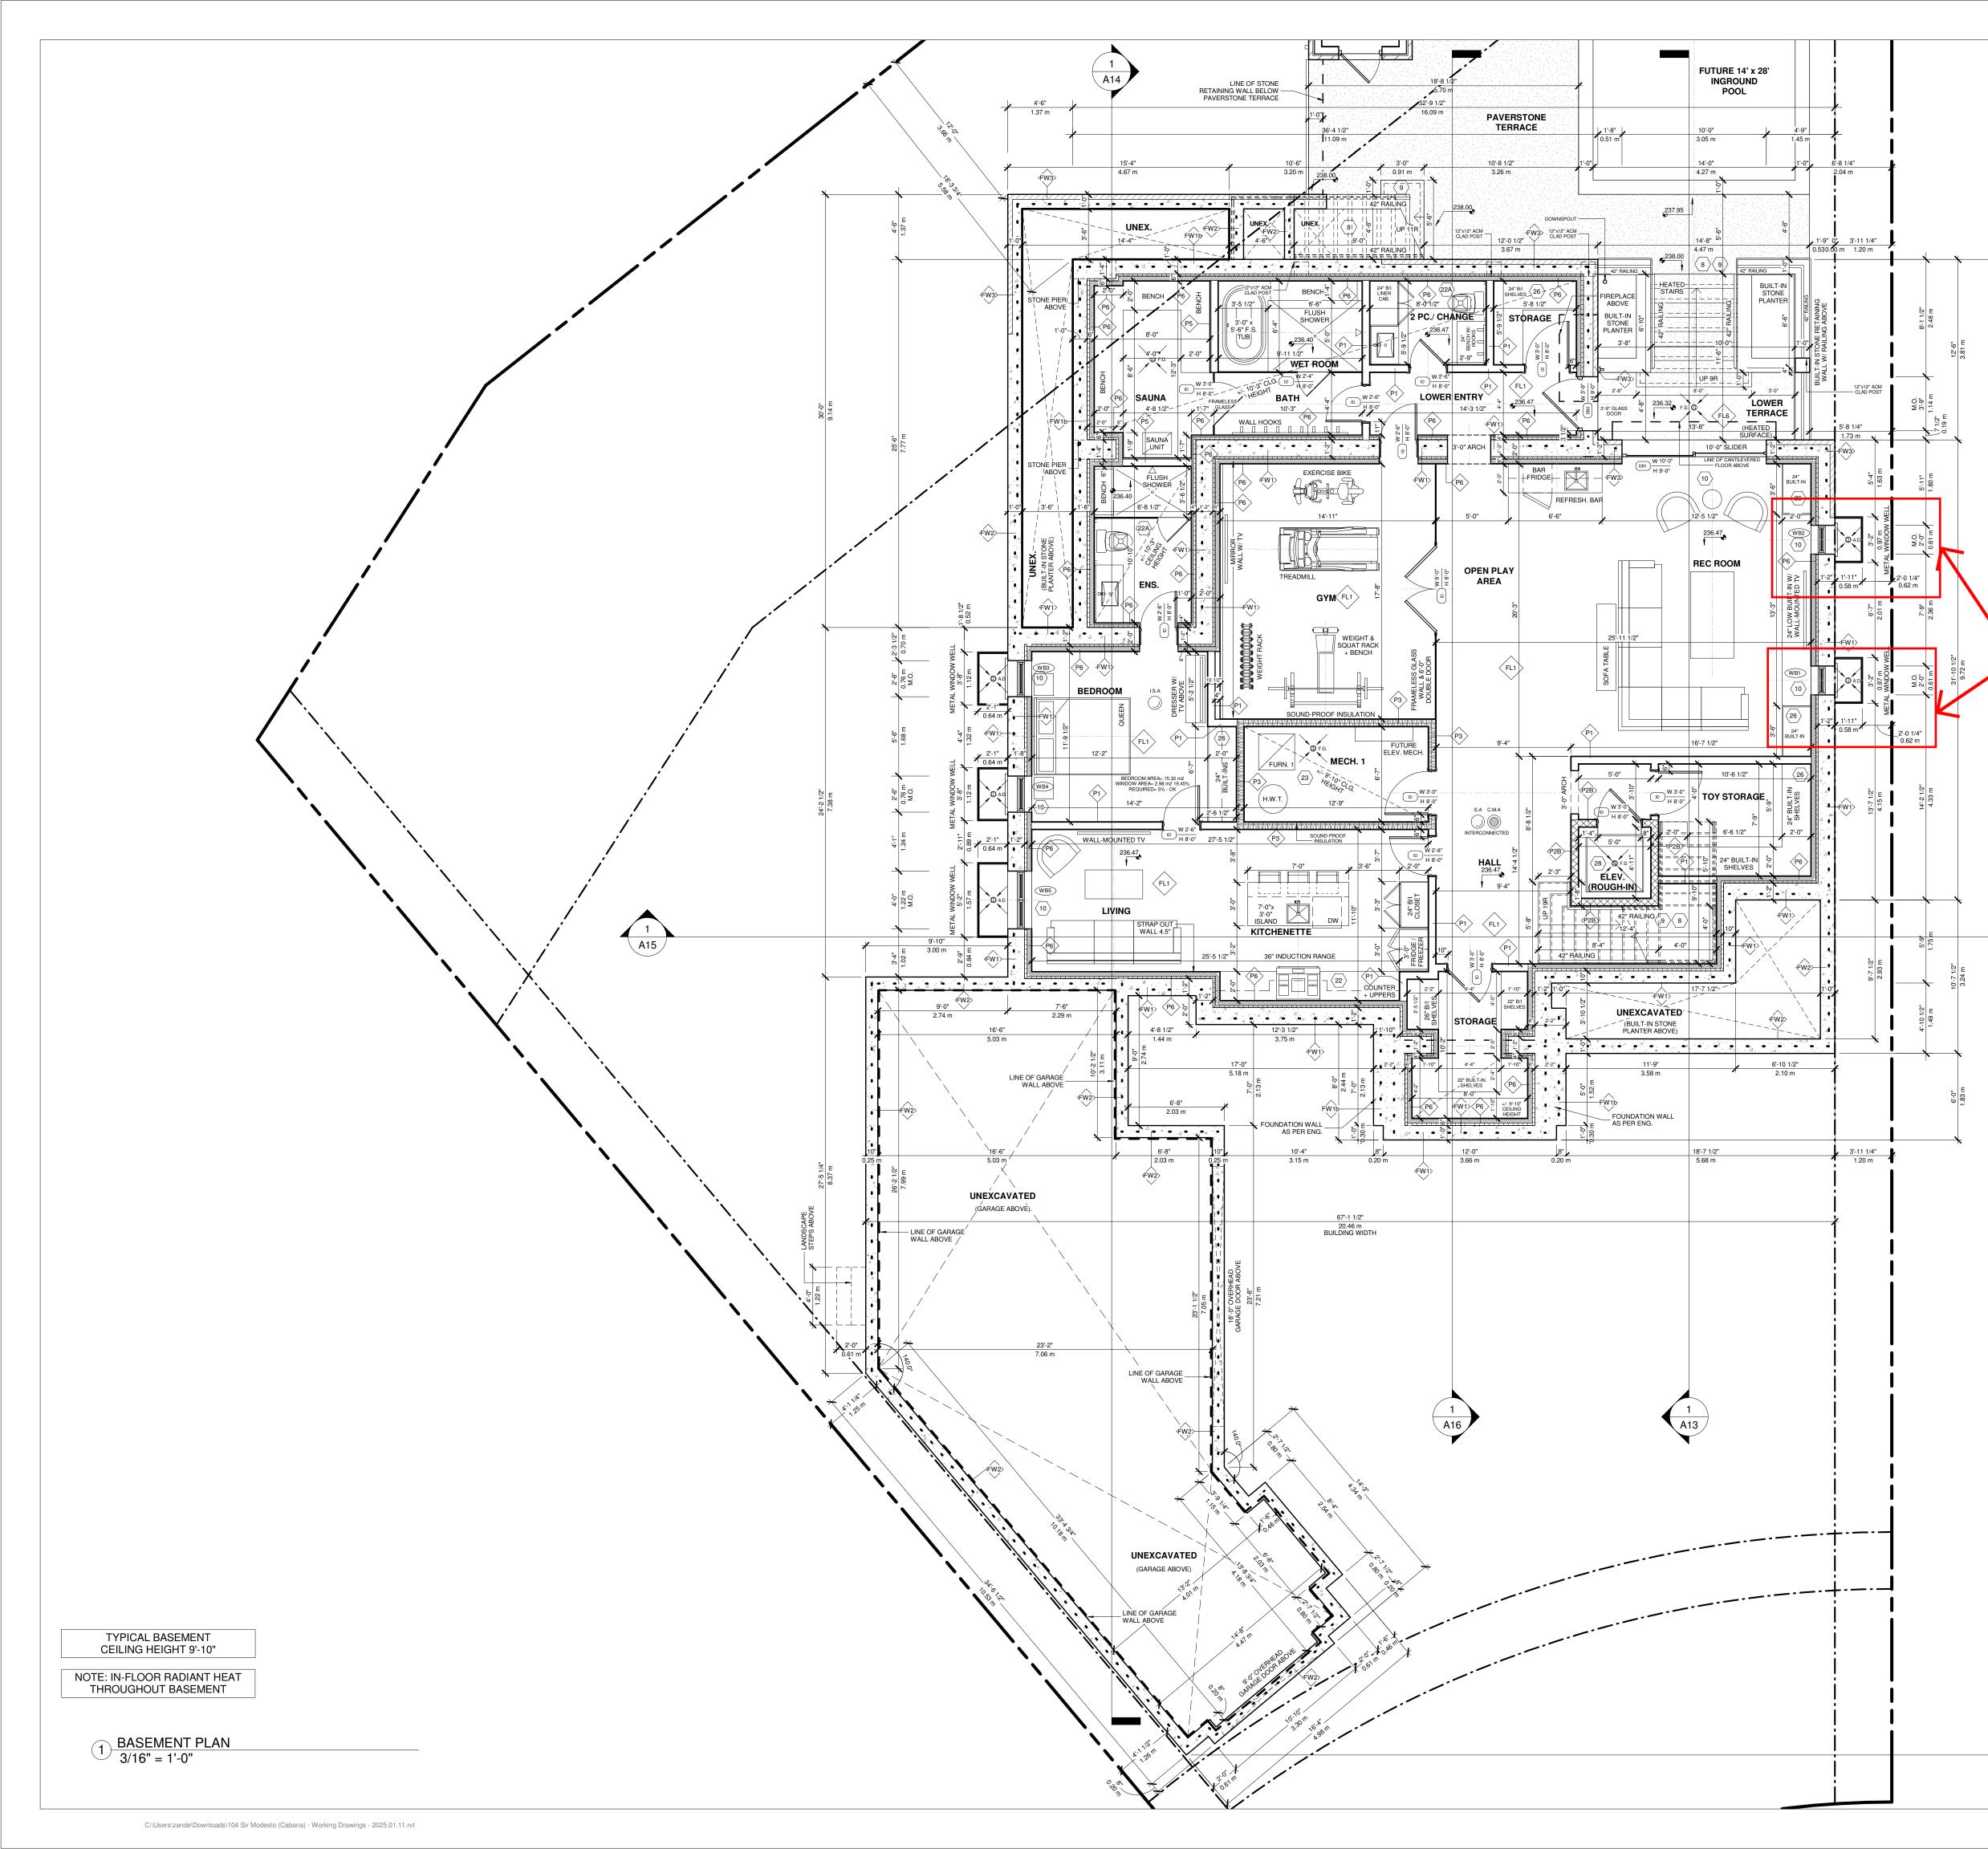

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$\rightarrow$		
VARIANCE #2 Window well with a depth of		_
Window well with a depth of 1.13m is setback from interior side lot line 0.62m	No. Issued for: Date 1.	
	2.	
	SEAL	
HE SN		
103:-7 1/4" 31:58 m BUILDING LEN		_
	<b>contempo</b> studio	
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	t. (416) 770-0071 f. (416) 642-1691	
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	the Ontario Building Code. MARIN ZABZUNI 45250	_
	NAME SIGNATURE BCIN REGISTRATION INFORMATION Required unless design is exempt under 3.2.4.7. Division C	
	of the Ontario Building Code.       CONTEMPO STUDIO       FIRM NAME       BCIN	-
		-
	PROPOSED 2-STOREY DWELLING	
	ат 104 SIR MODESTO COURT, VAUGHAN, ON	
	BASEMENT PLAN	-
	·	-
	Project number:         2023-24           Rev. no.:         3/16" = 1'-0"           Scale:         3/16" = 1'-0"           Data:         IANILIARY 2025	
	Date:JANUARY, 2025Drawn by:J.T. + M.RApproved by:M.Z.	_
-	Drawing number:	)

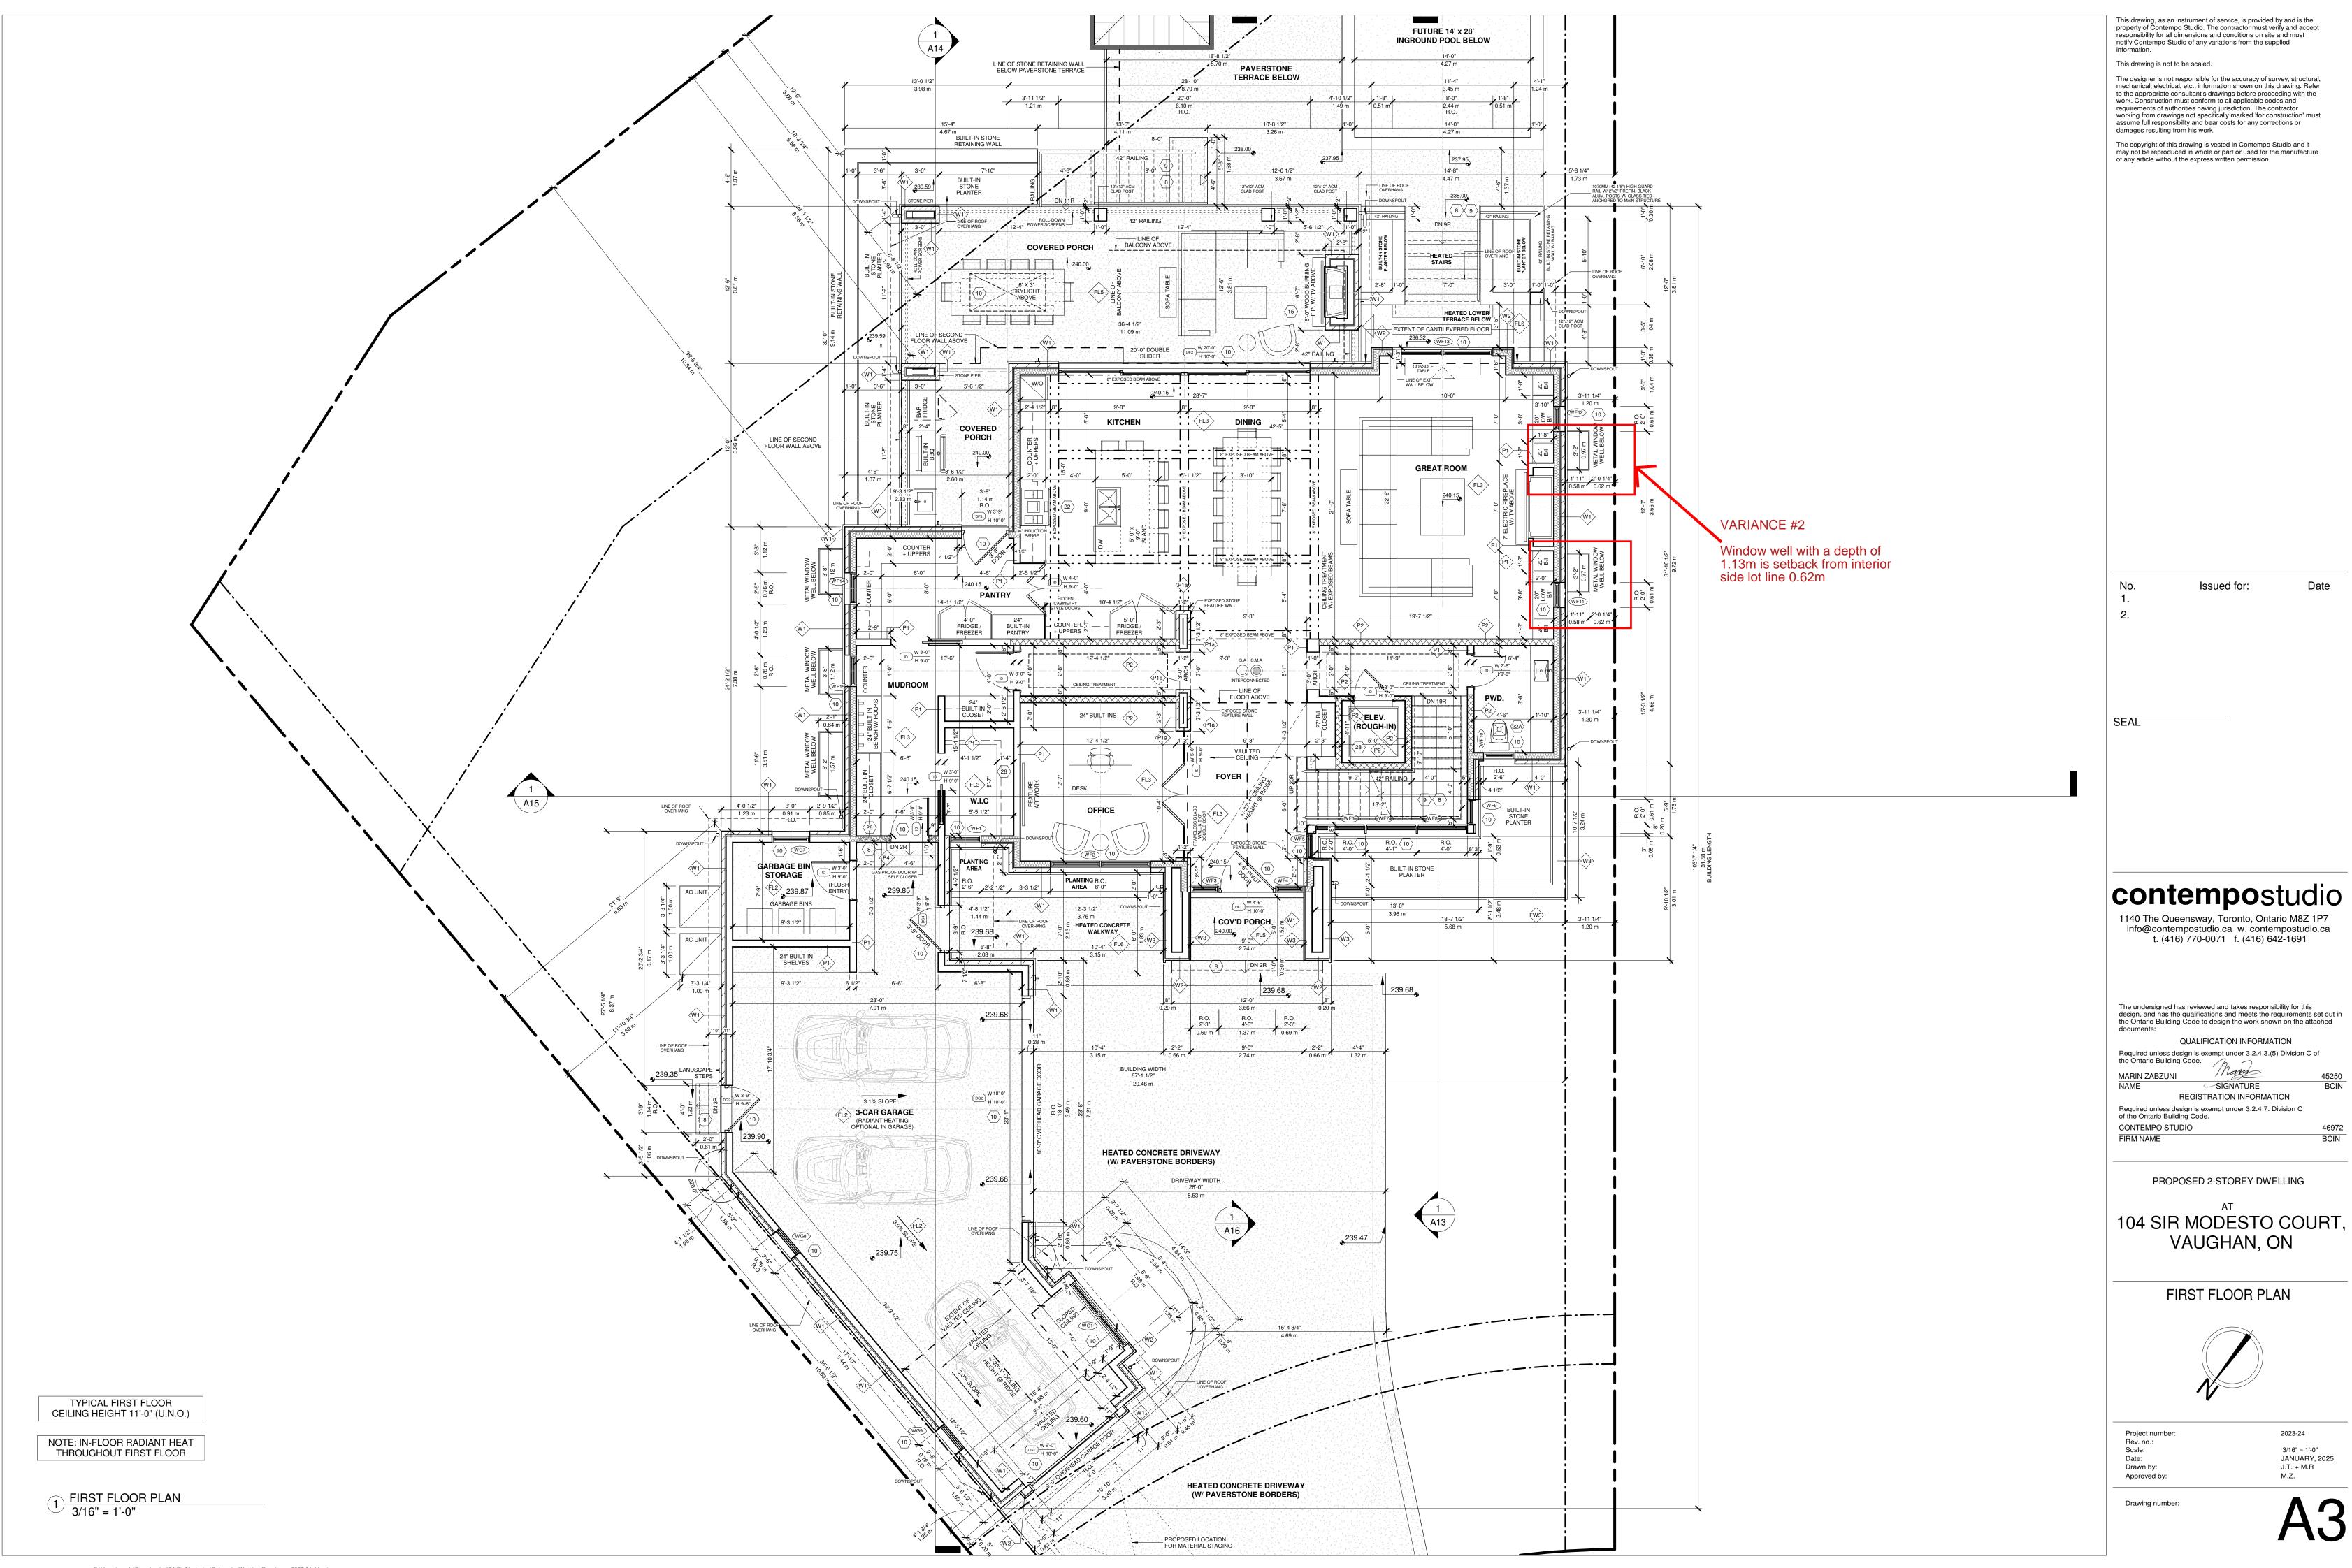

Date

BCIN


46972

BCIN

### 1 <u>SECOND FLOOR PLAN</u> 3/16" = 1'-0"

NOTE: IN-FLOOR RADIANT HEAT THROUGHOUT SECOND FLOOR

TYPICAL SECOND FLOOR CEILING HEIGHT 10'-0" (U.N.O.)

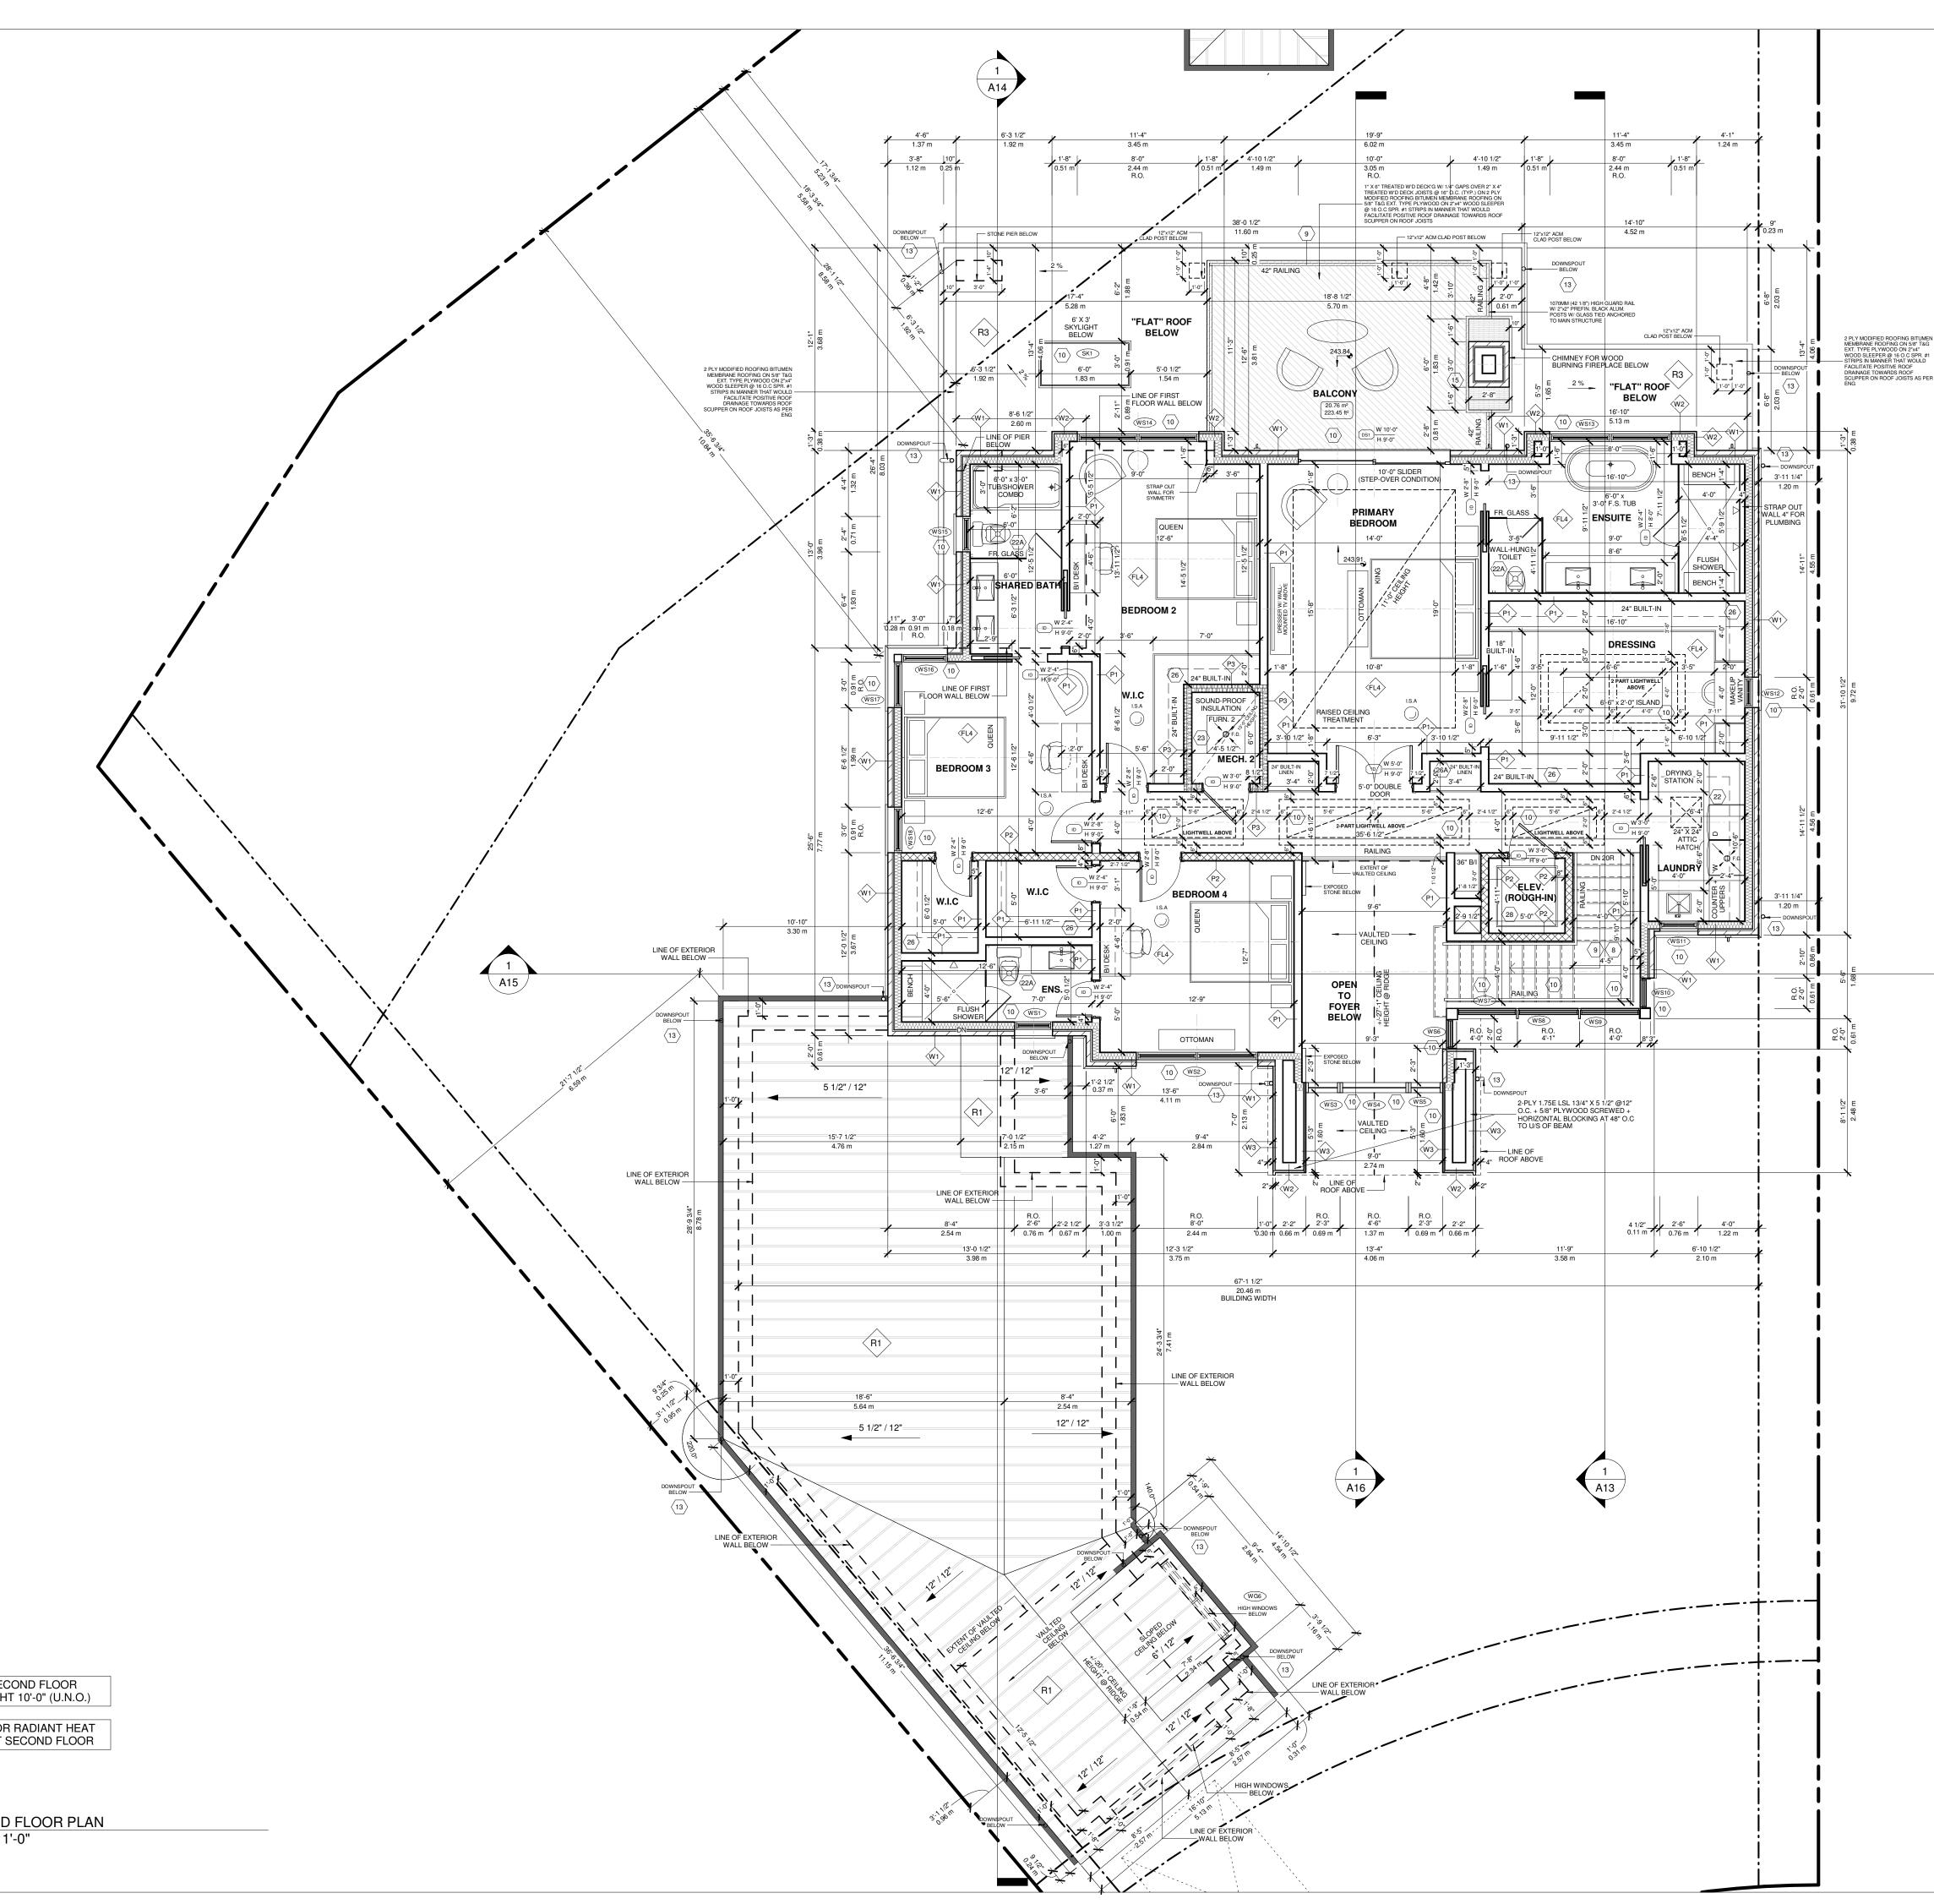

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PROPOSED 2-STOREY DWELLING

AT 104 SIR MODESTO COURT, VAUGHAN, ON

### SECOND FLOOR PLAN




Project number: Rev. no.: Scale: Date: Drawn by: Approved by:

FIRM NAME

2023-24 3/16" = 1'-0" JANUARY, 2025 J.T. + M.R M.Z.

BCIN



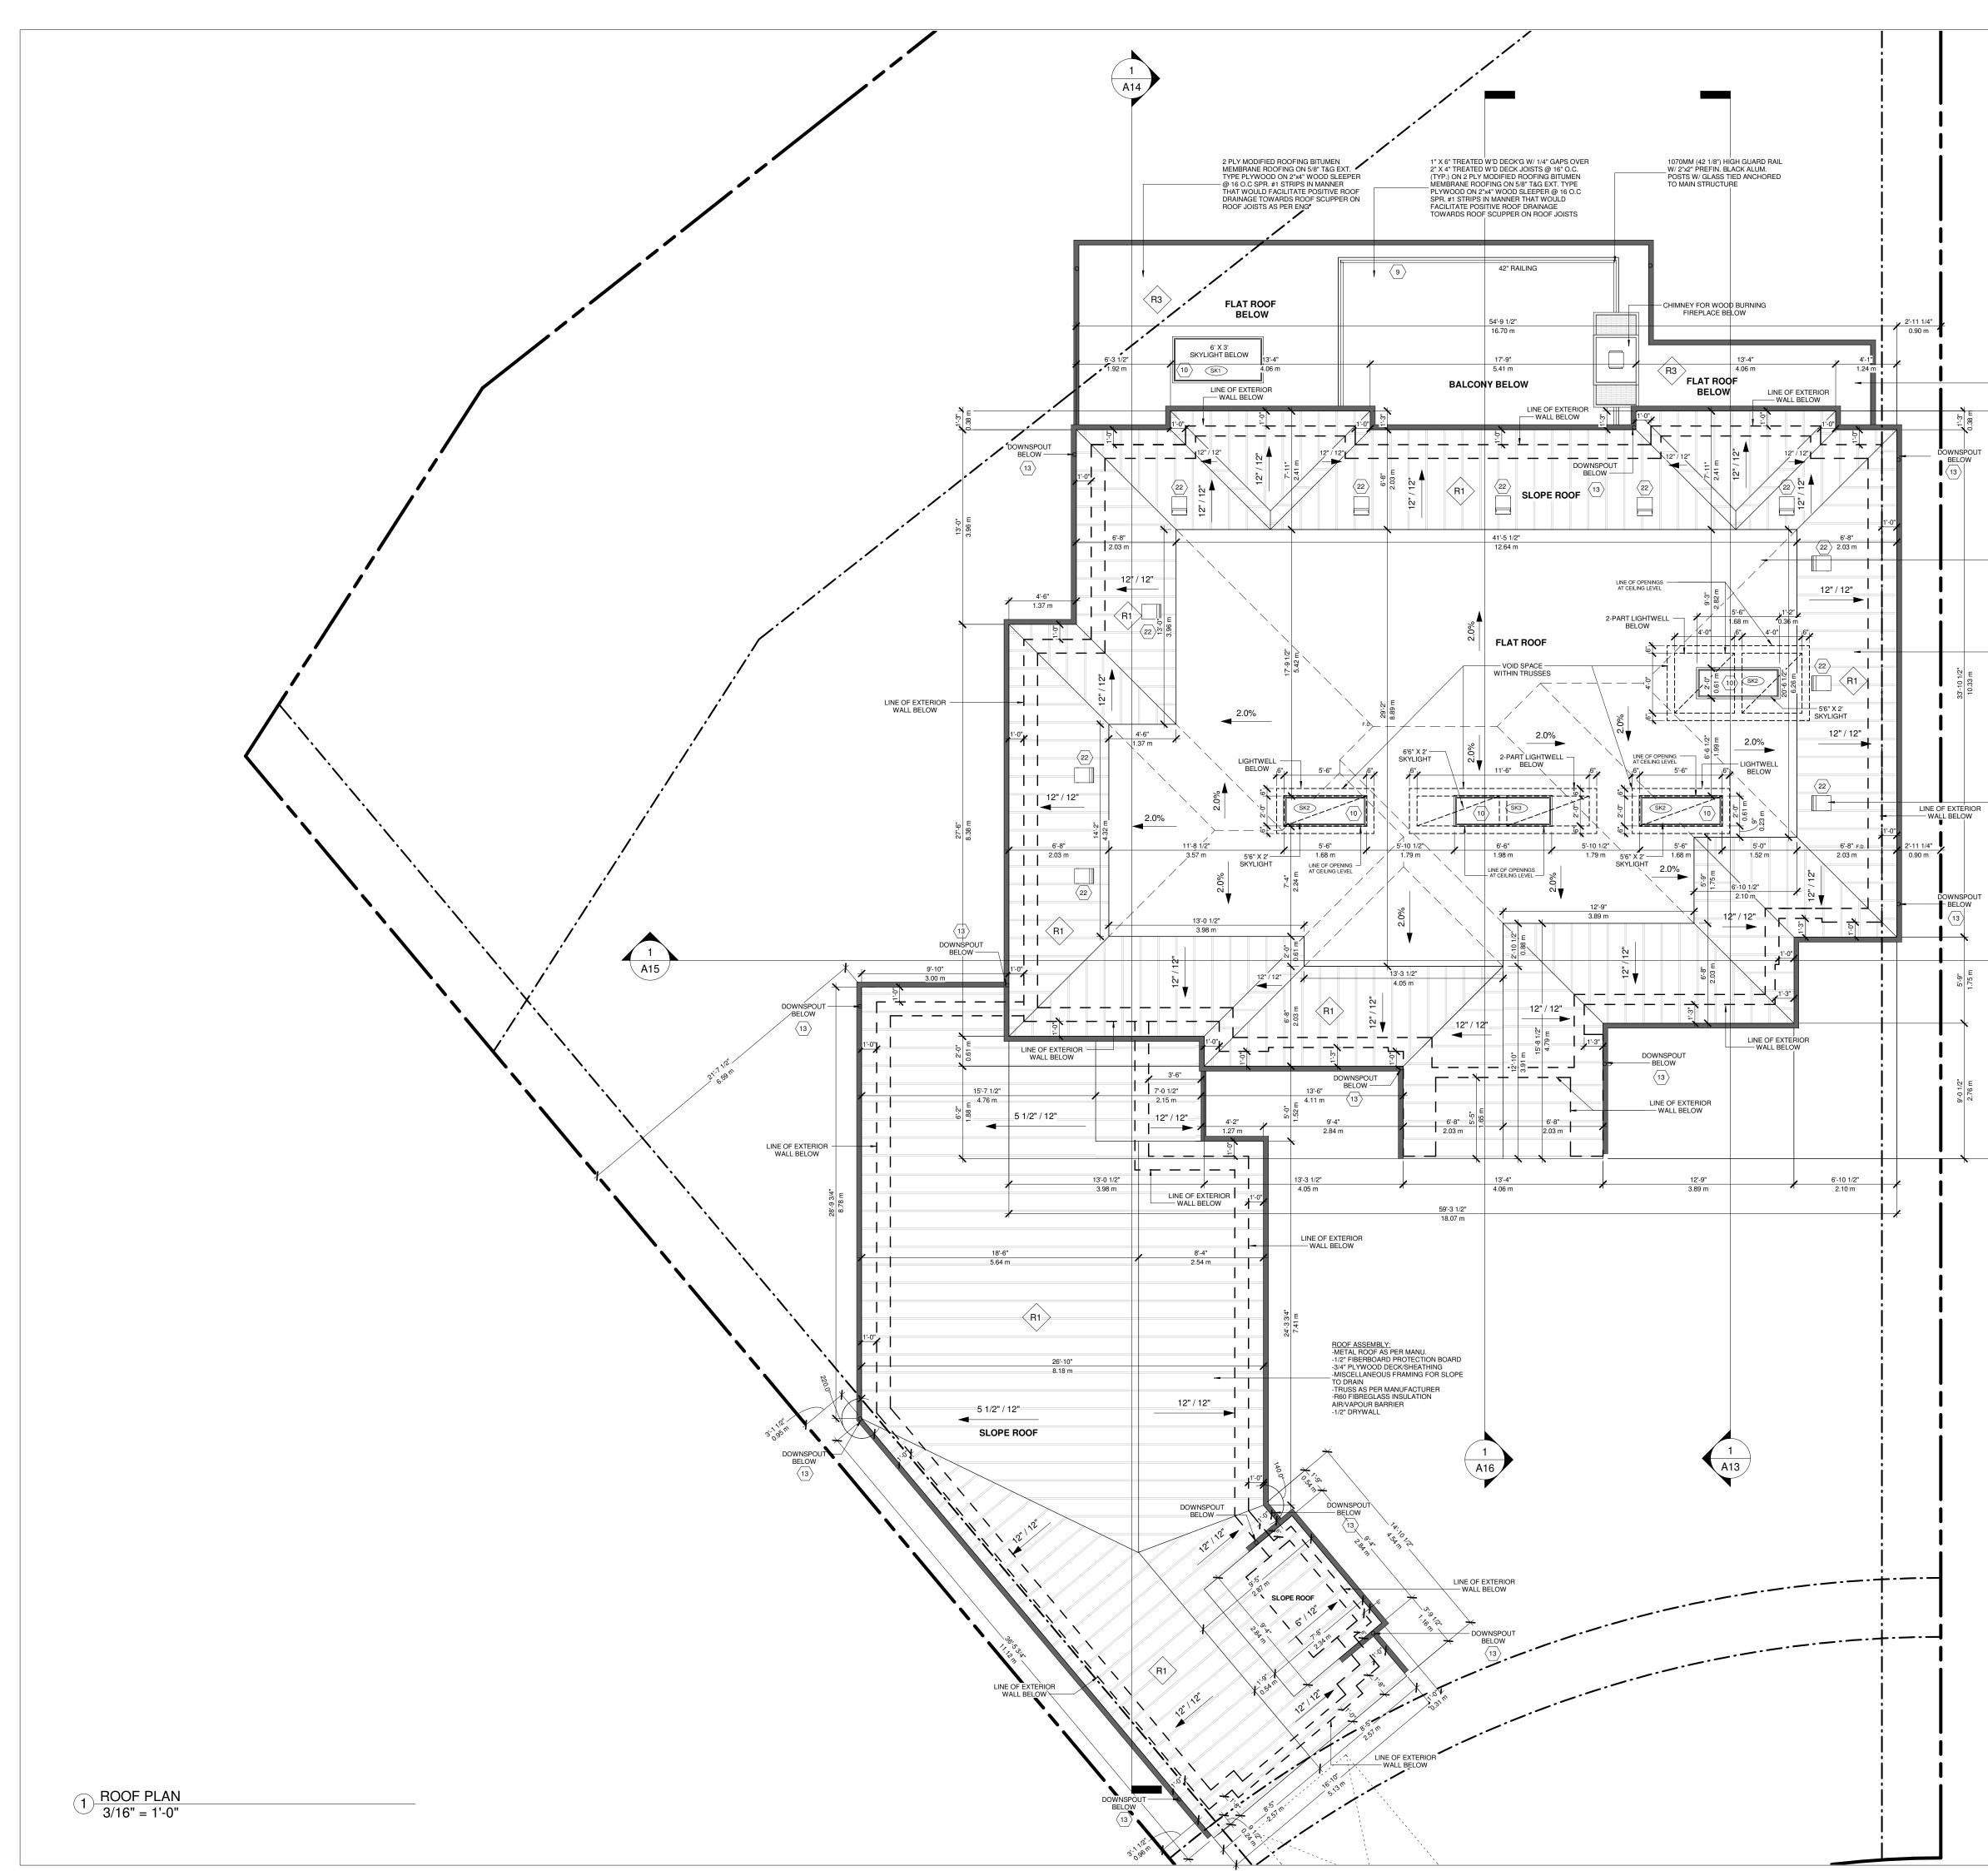

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WHEN TRUSS LAYOUT IS DIFFERENT FROM WHAT IS SHOWN ON PERMIT PLANS AND SOLID BEARING OF GIRDER TRUSS IS SITTING ON WINDOW'S LINTEL, LINTEL SHALL BE DESIGN BY TRUSS MANUFACTURER.

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damages resulting from his work.

### 2 PLY MODIFIED ROOFING BITUMEN MEMBRANE ROOFING ON 5/8" T&G EXT. TYPE PLYWOOD ON 2"x4" WOOD SLEEPER - @ 16 O.C SPR. #1 STRIPS IN MANNER THAT WOULD FACILITATE POSITIVE ROOF DRAINAGE TOWARDS ROOF SCUPPER ON ROOF JOISTS AS PER ENG

# ROOF ASSEMBLY: 2 PLY MODIFIED ROOFING BITUMEN MEMBRANE ROOFING ON 5/8" T&G EXT. TYPE PLYWOOD ON 2"x4" EXT. TYPE PLYWOOD ON 2"X4" WOOD SLEEPER @ 16 O.C SPR. #1 STRIPS IN MANNER THAT WOULD FACILITATE POSITIVE ROOF DRAINAGE TOWARDS ROOF SCUPPER ON ROOF TRUSSES

# ROOF ASSEMBLY: -METAL ROOF AS PER MANU. -1/2" FIBERBOARD PROTECTION BOARD -3/4" PLYWOOD DECK/SHEATHING -MISCELLANEOUS FRAMING FOR SLOPE TO DRAIN -TRUSS AS PER MANUFACTURER -R60 FIBREGLASS INSULATION AIR/VAPOUR BARRIER -1/2" DRYWALL

# ROOF VENTS (TYP.) ROOF VENTILATION 1:300 OF

INSULATED CEILING AREA UNIFORMLY DISTRIBUTED (TYP.)

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PROPOSED 2-STOREY DWELLING

### AT 104 SIR MODESTO COURT, VAUGHAN, ON


ROOF PLAN



Project number: Rev. no.: Scale: Date: Drawn by: Approved by:


2023-24 3/16" = 1'-0" JANUARY, 2025 J.T. + M.R M.Z.



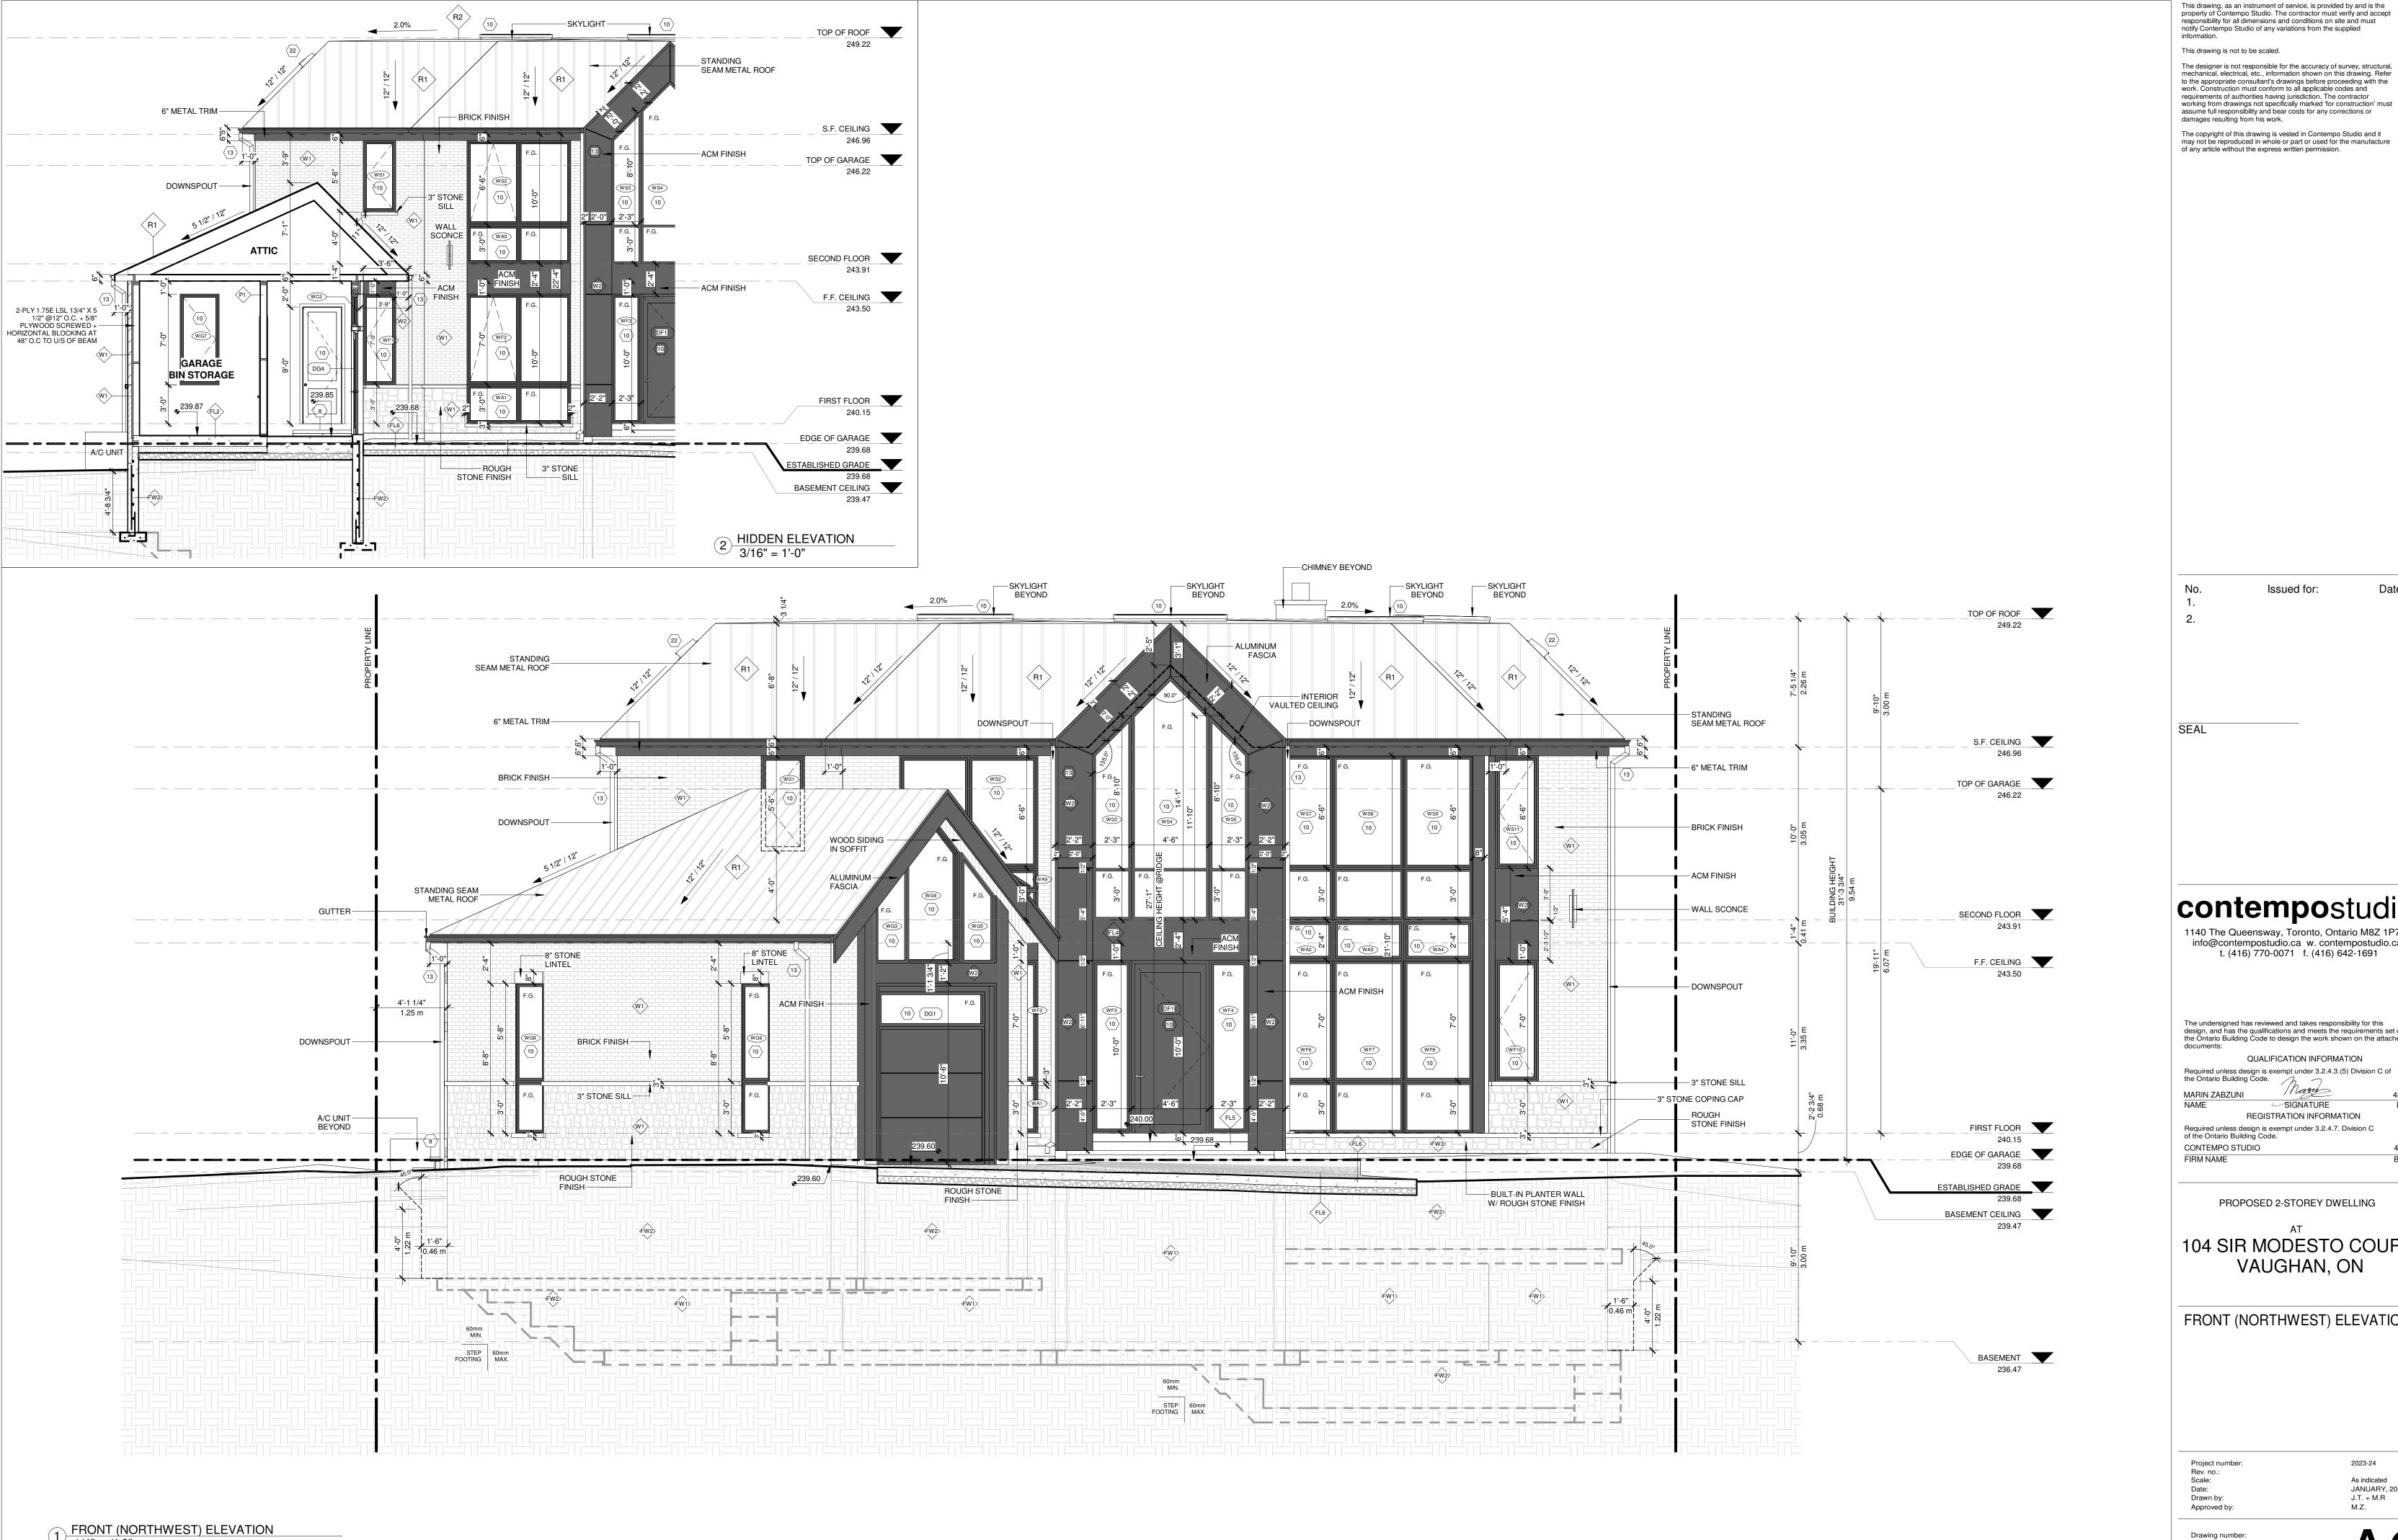


1 FRONT (NORTHWEST) ELEVATION 1/4" = 1'-0"


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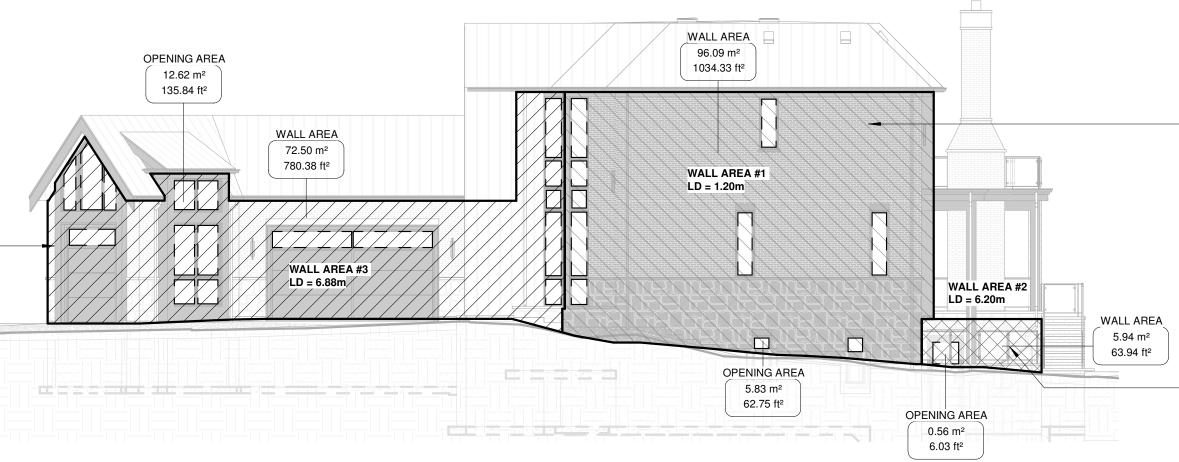


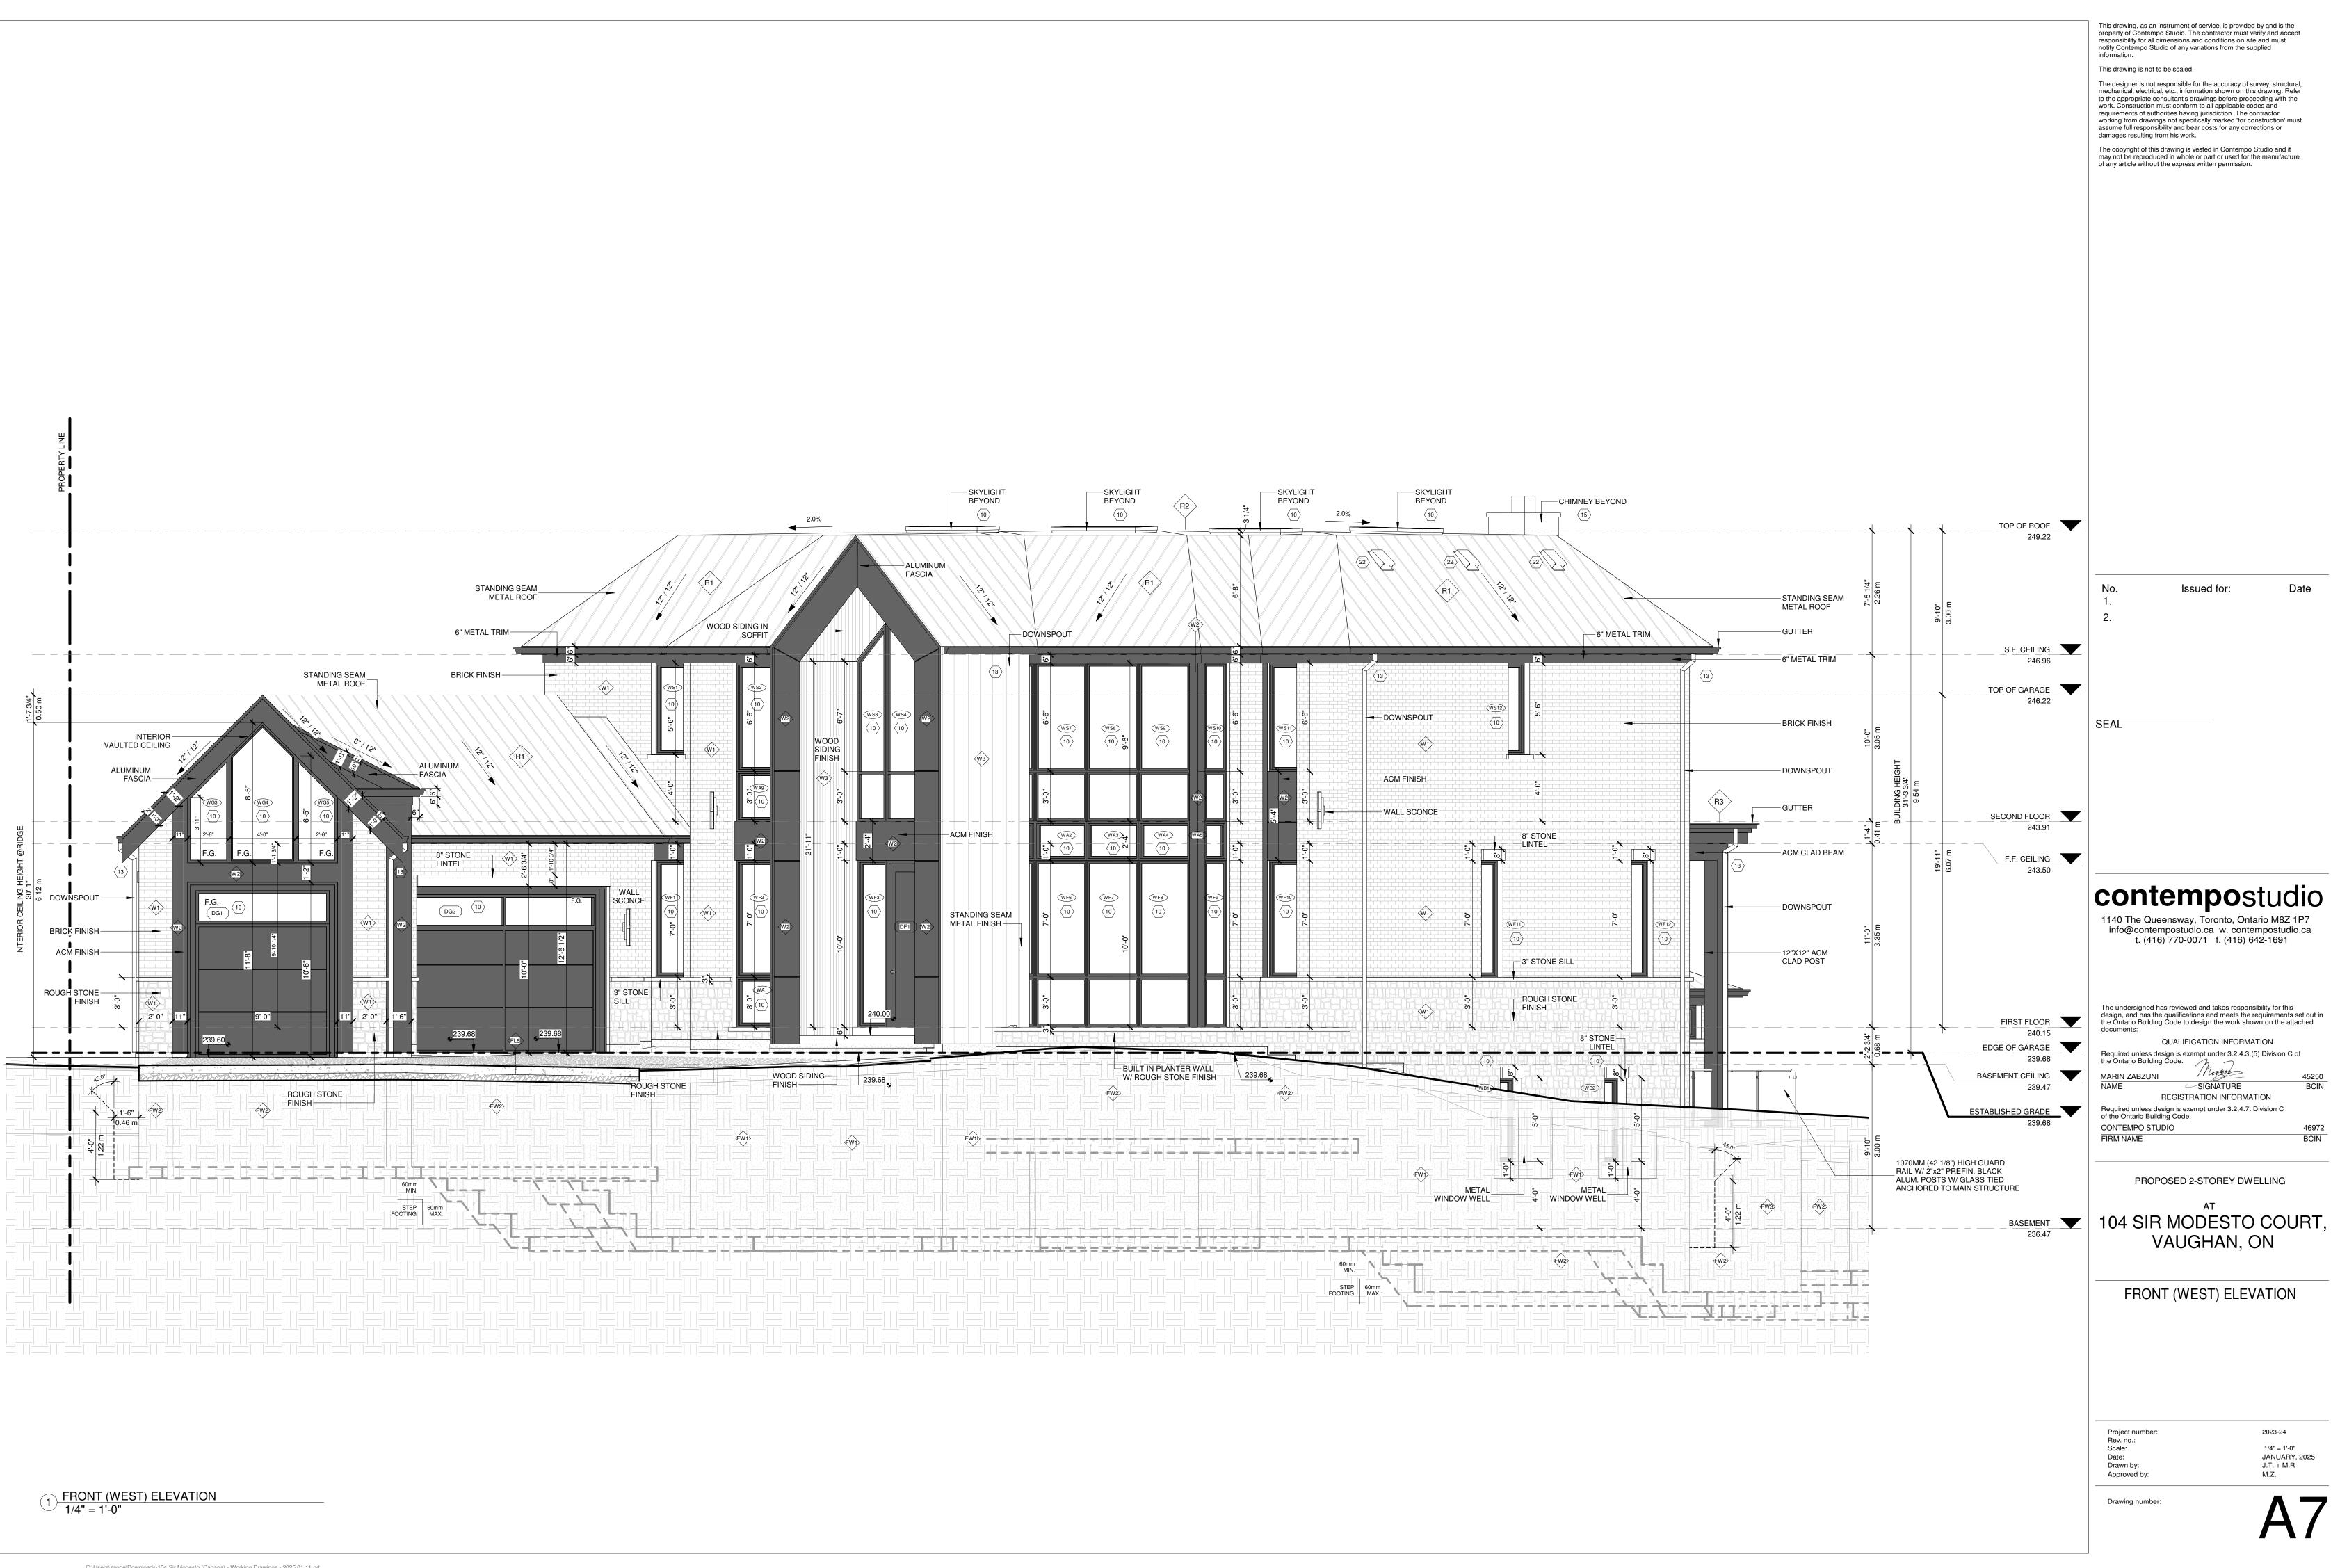



1 REAR (SOUTHEAST) ELEVATION 1/4" = 1'-0"

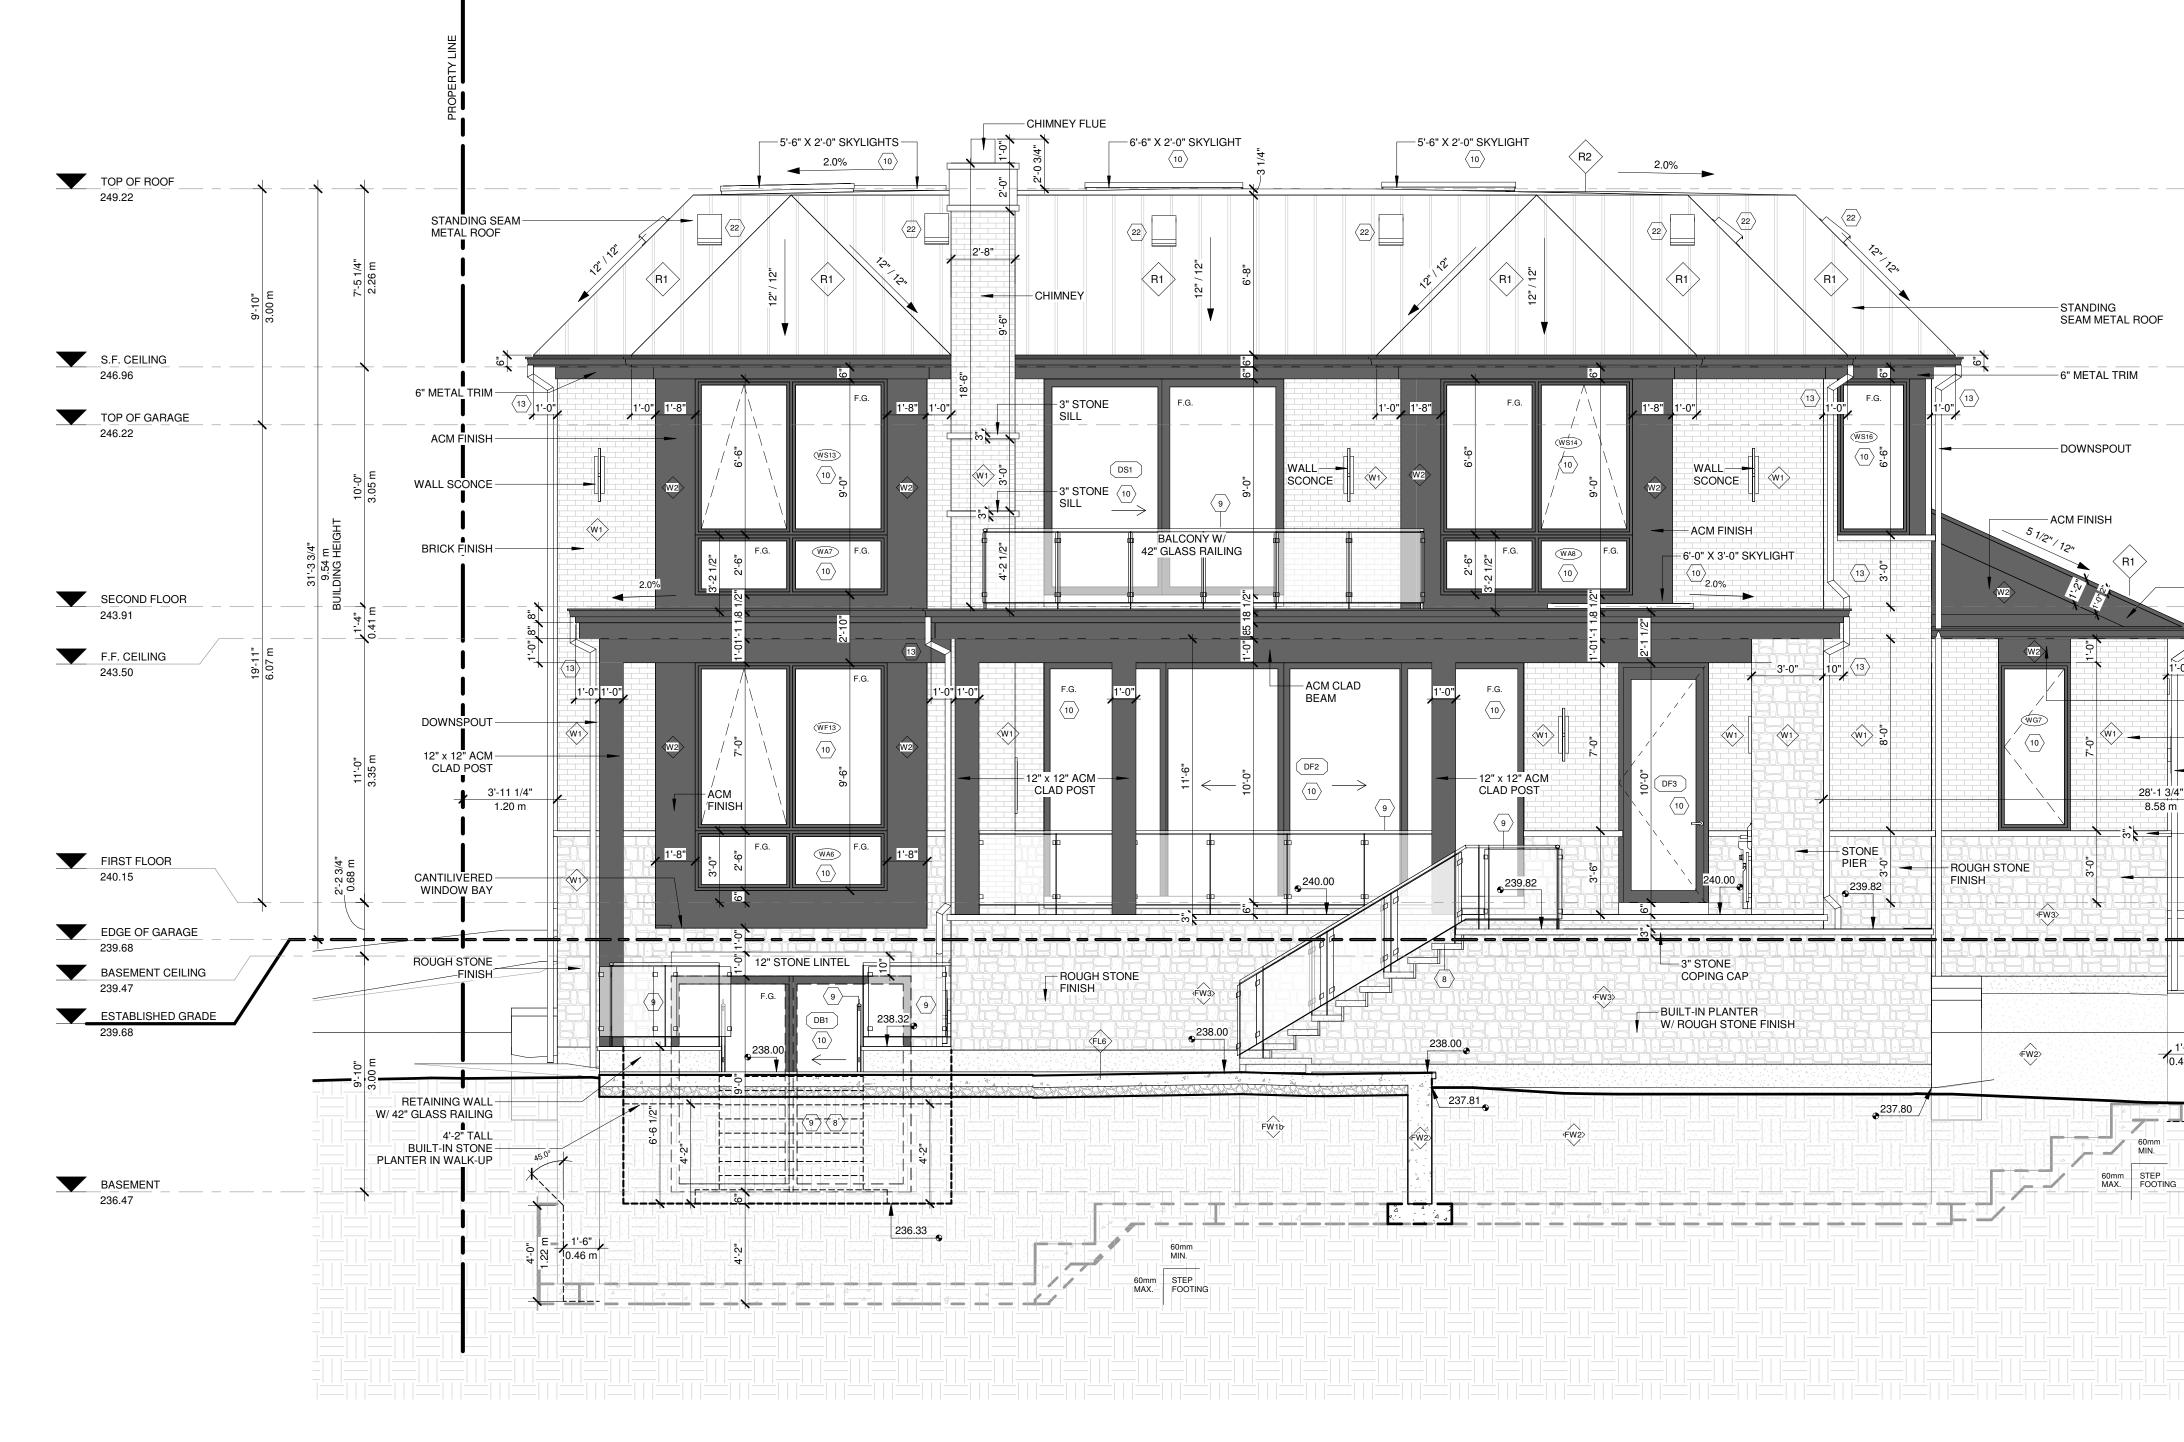



1'-6" 0.45 m

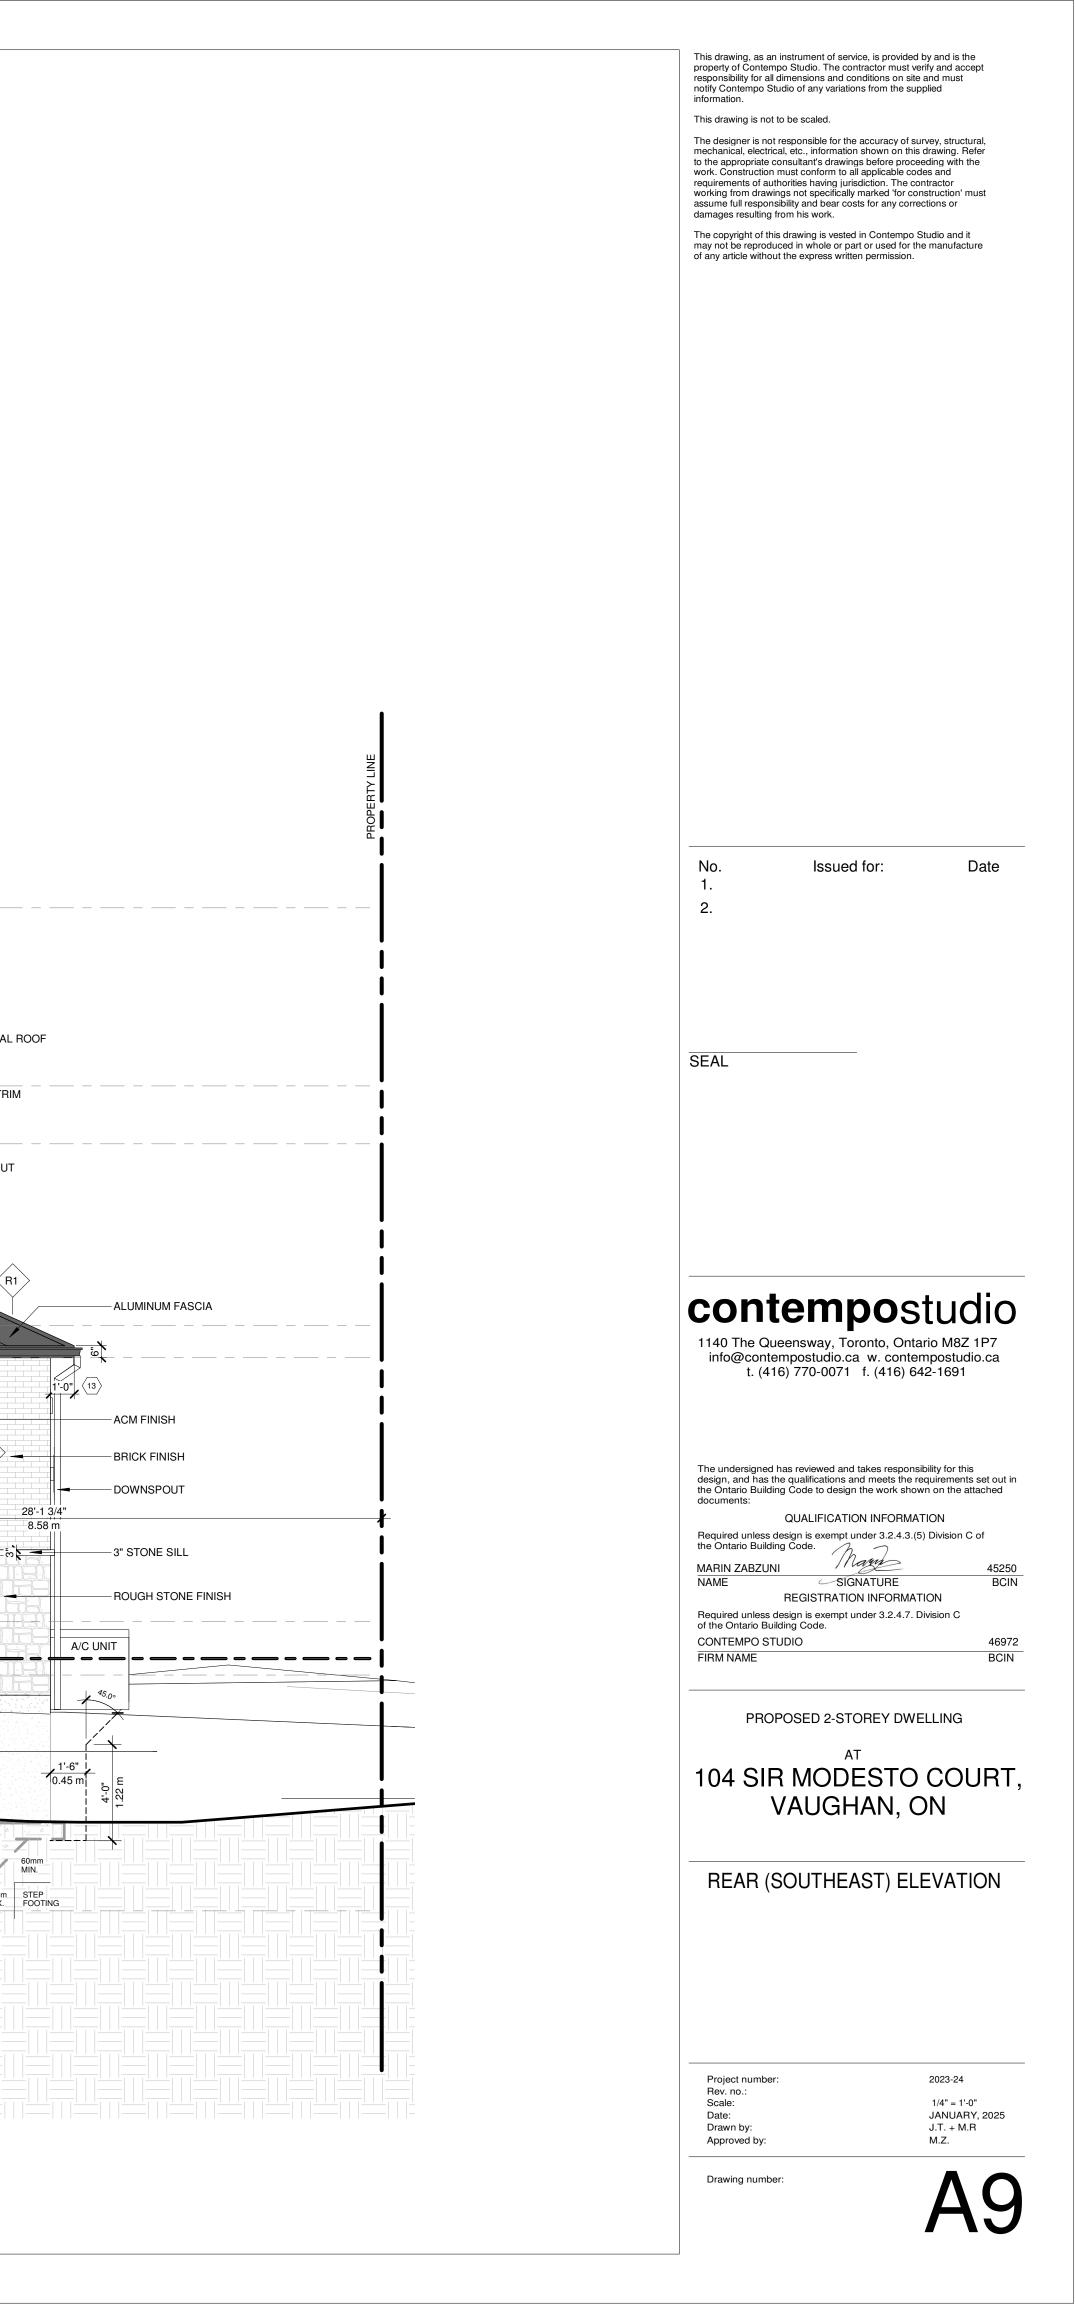


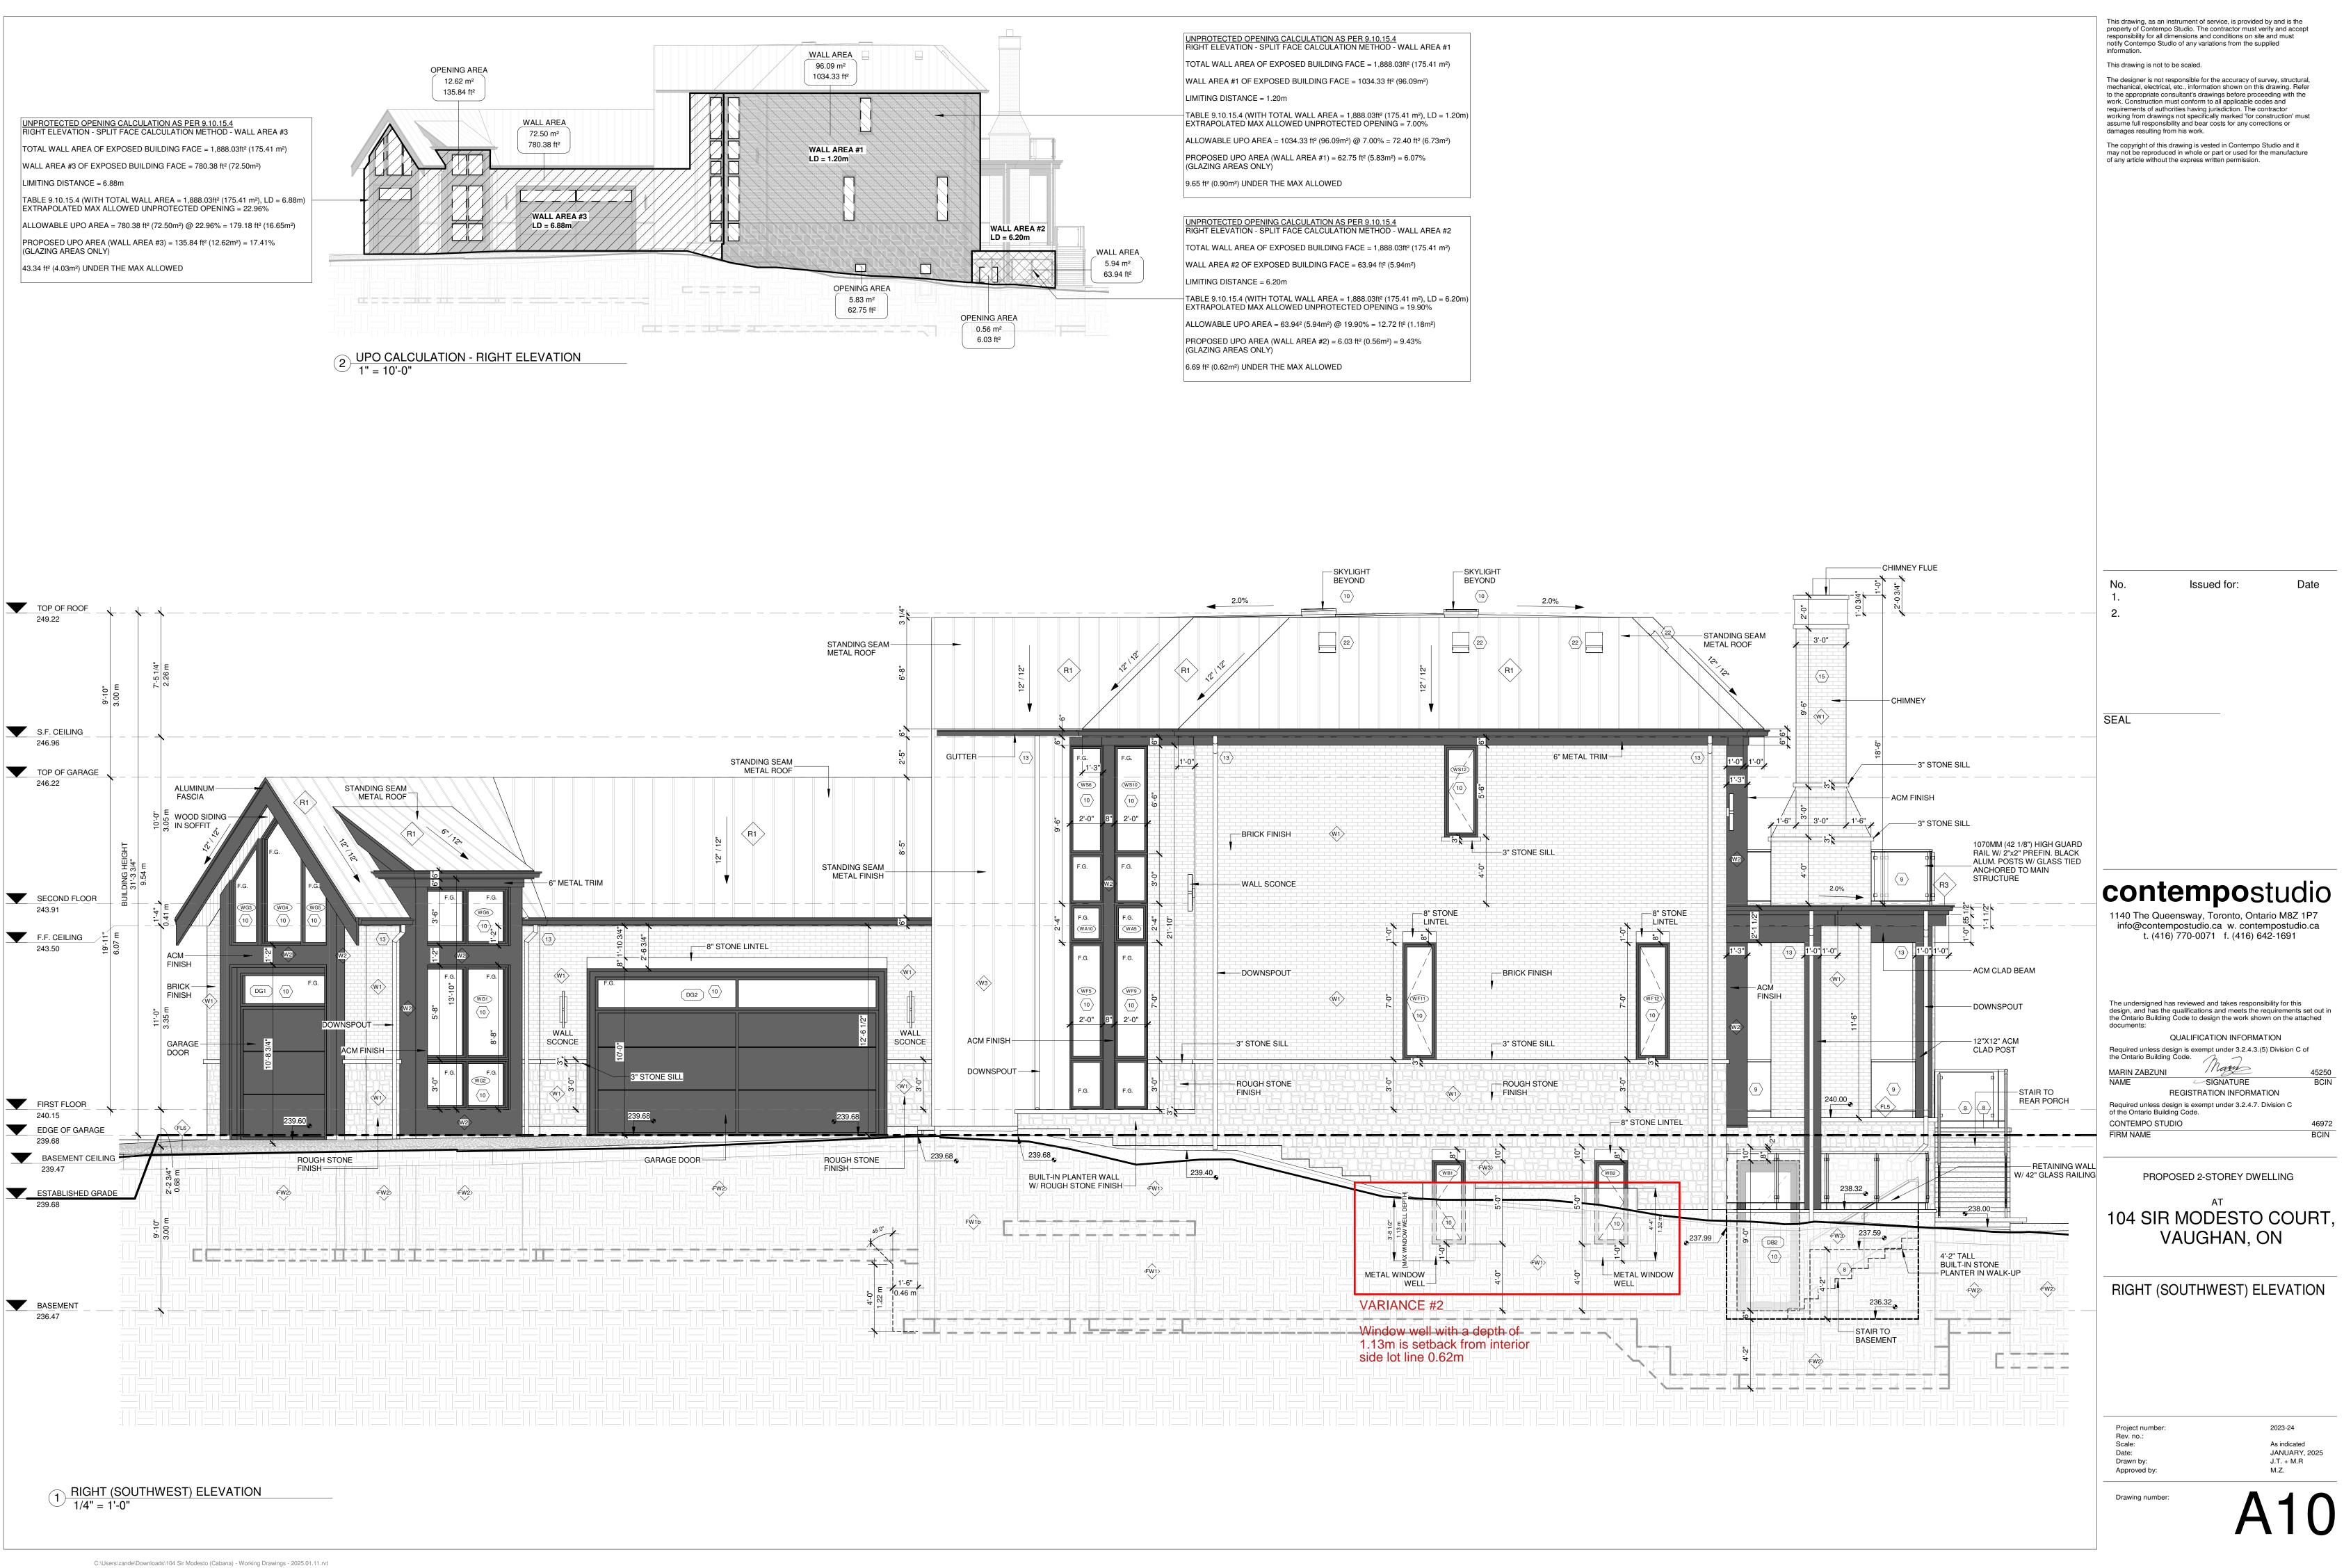


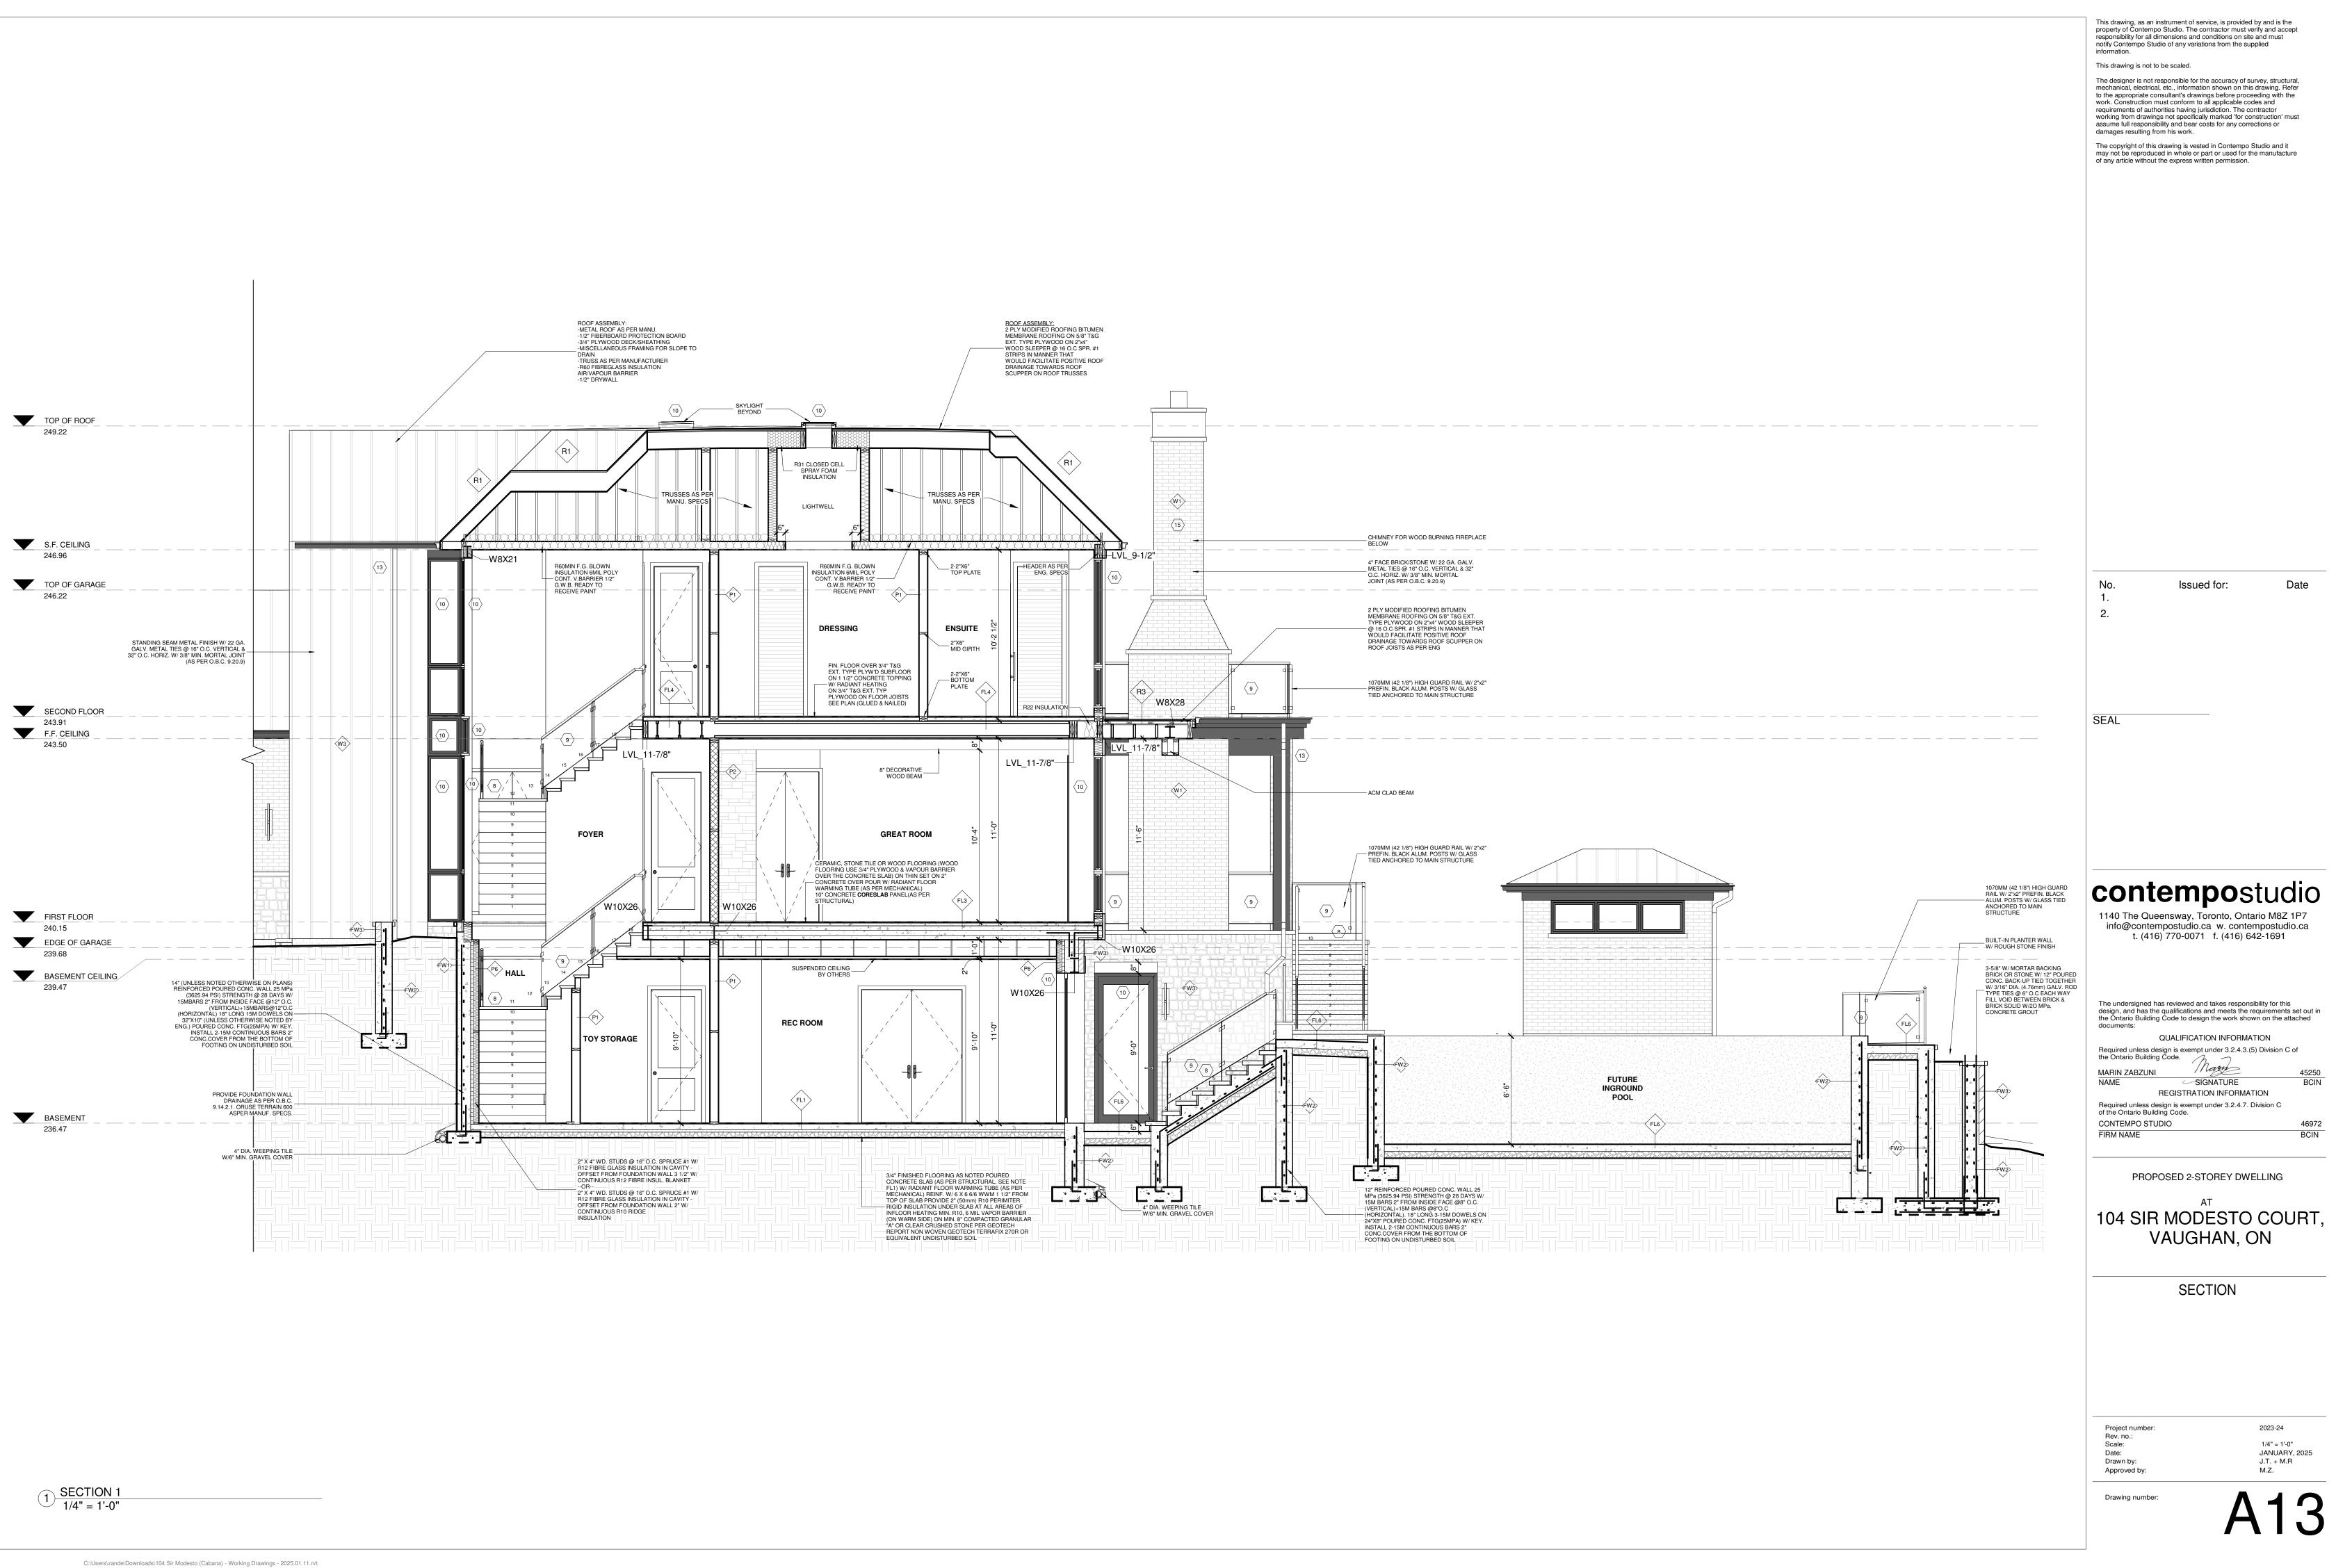

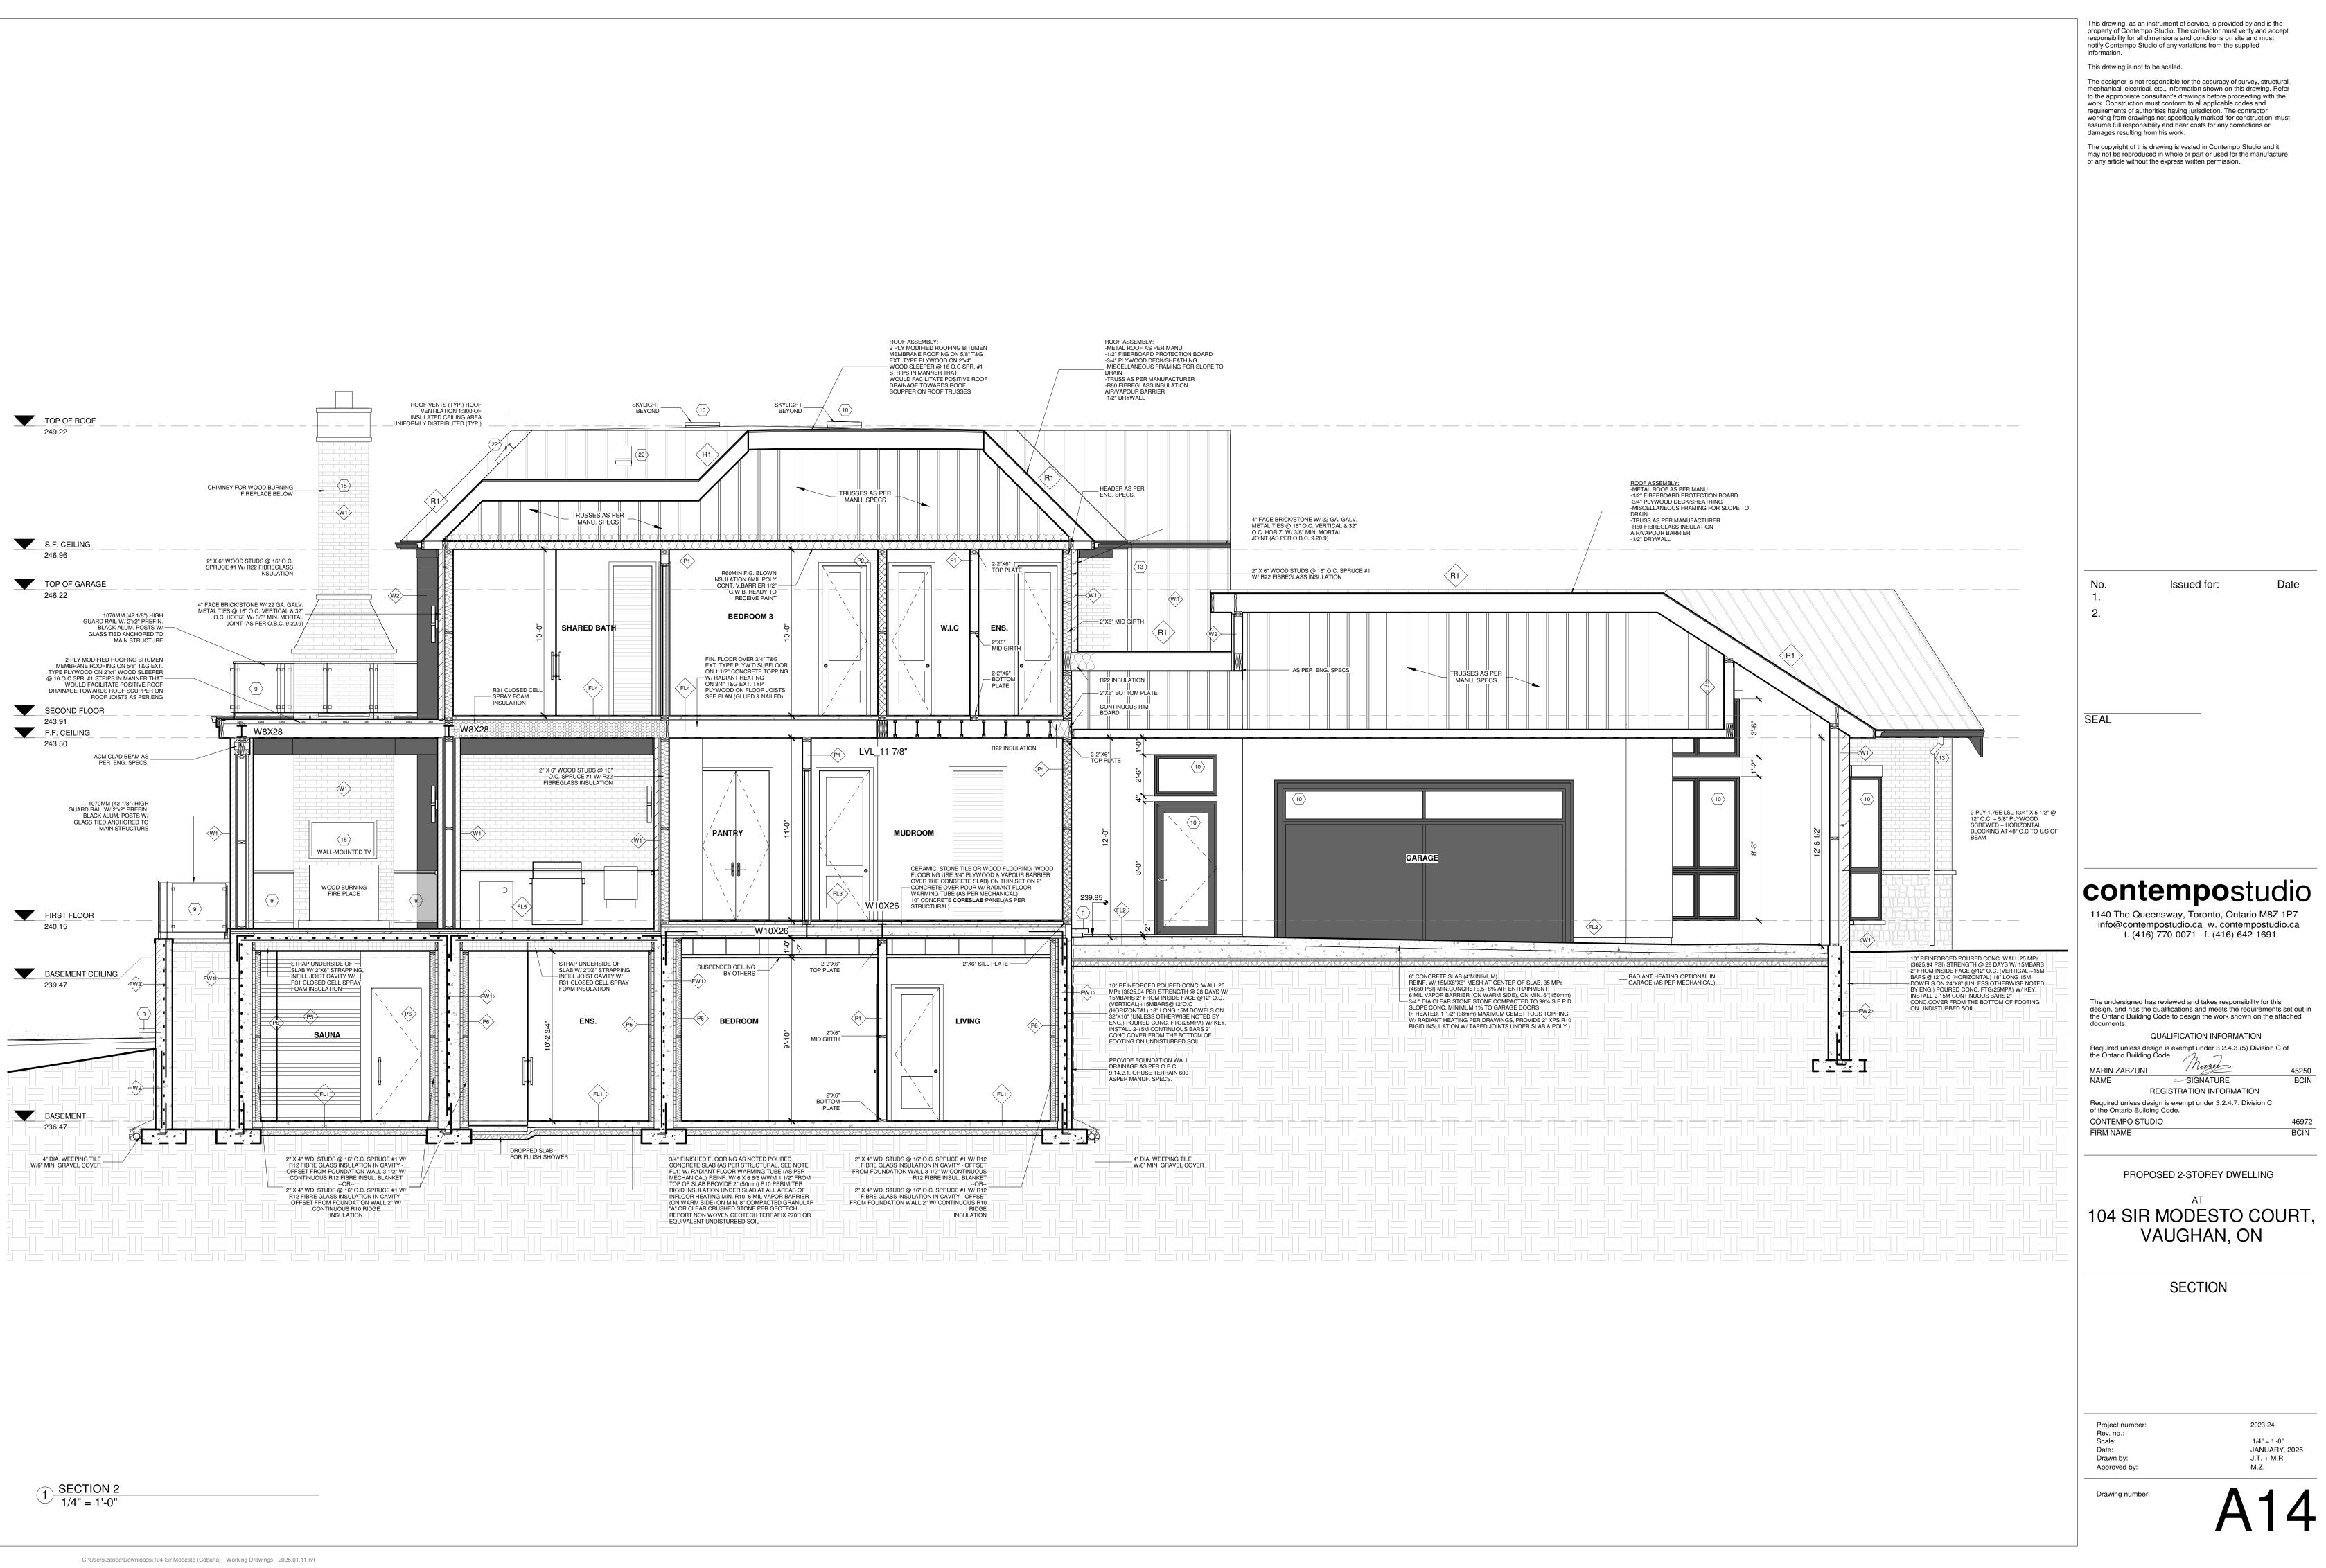

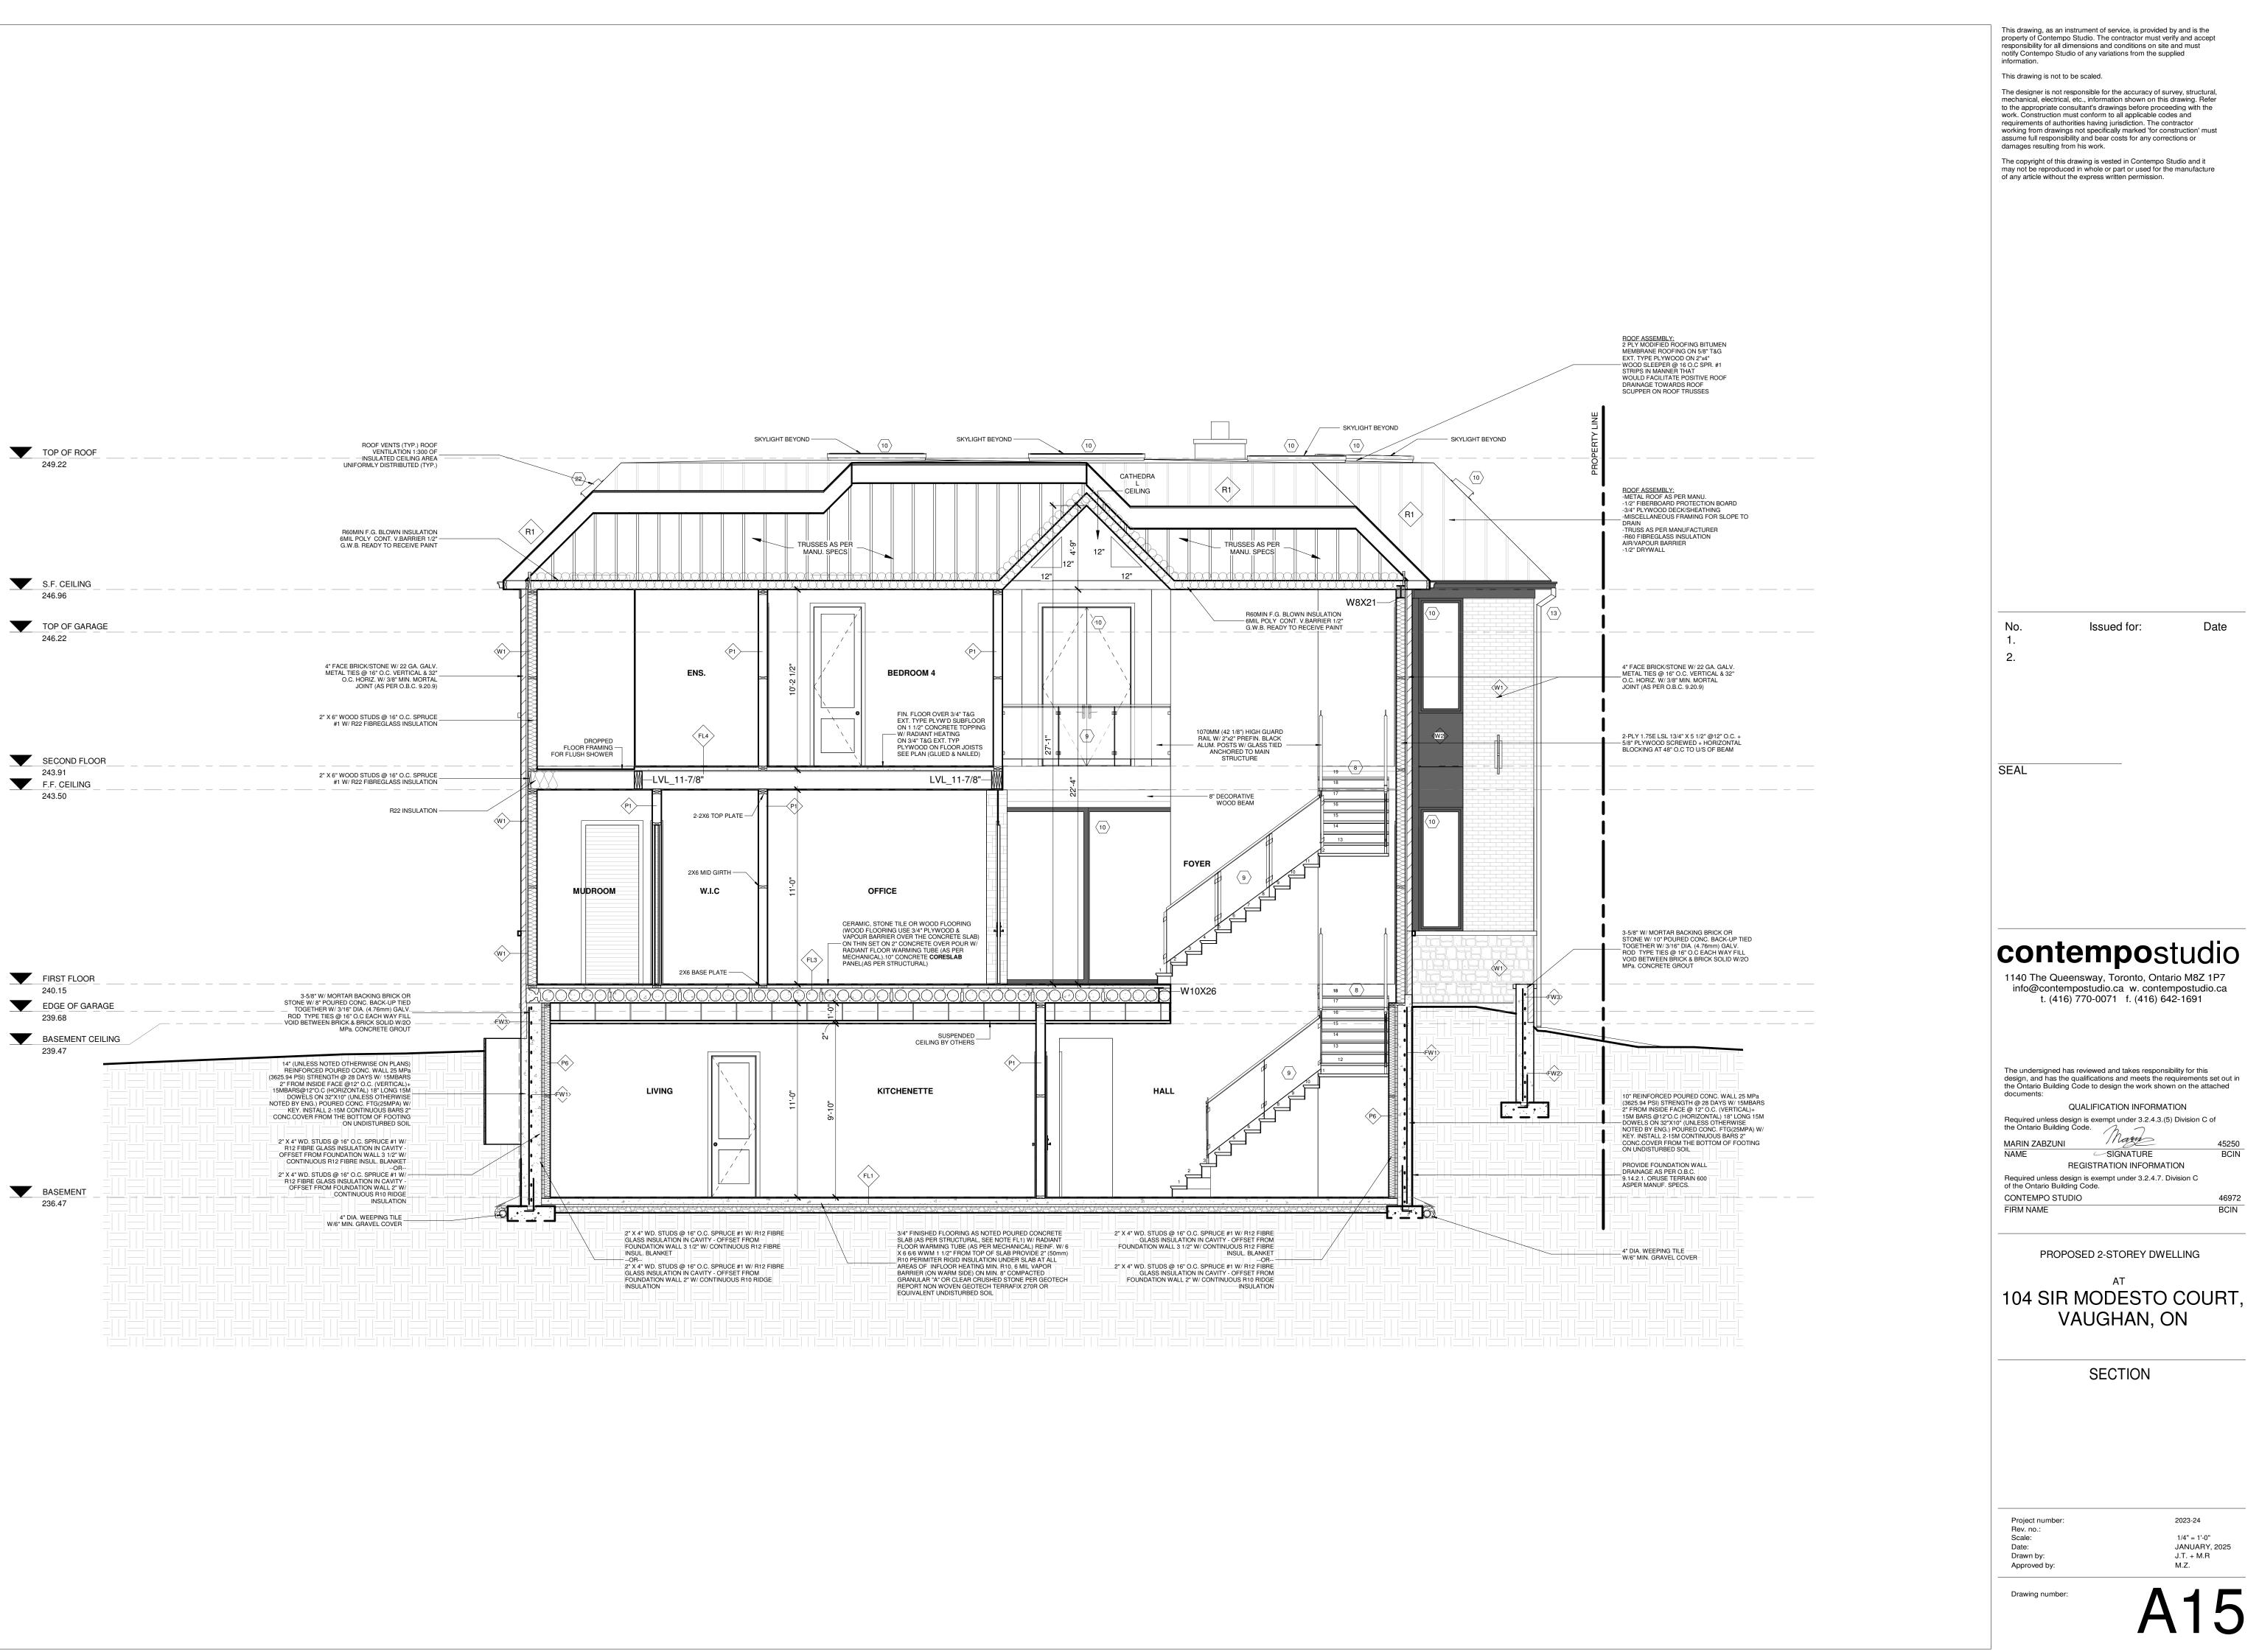

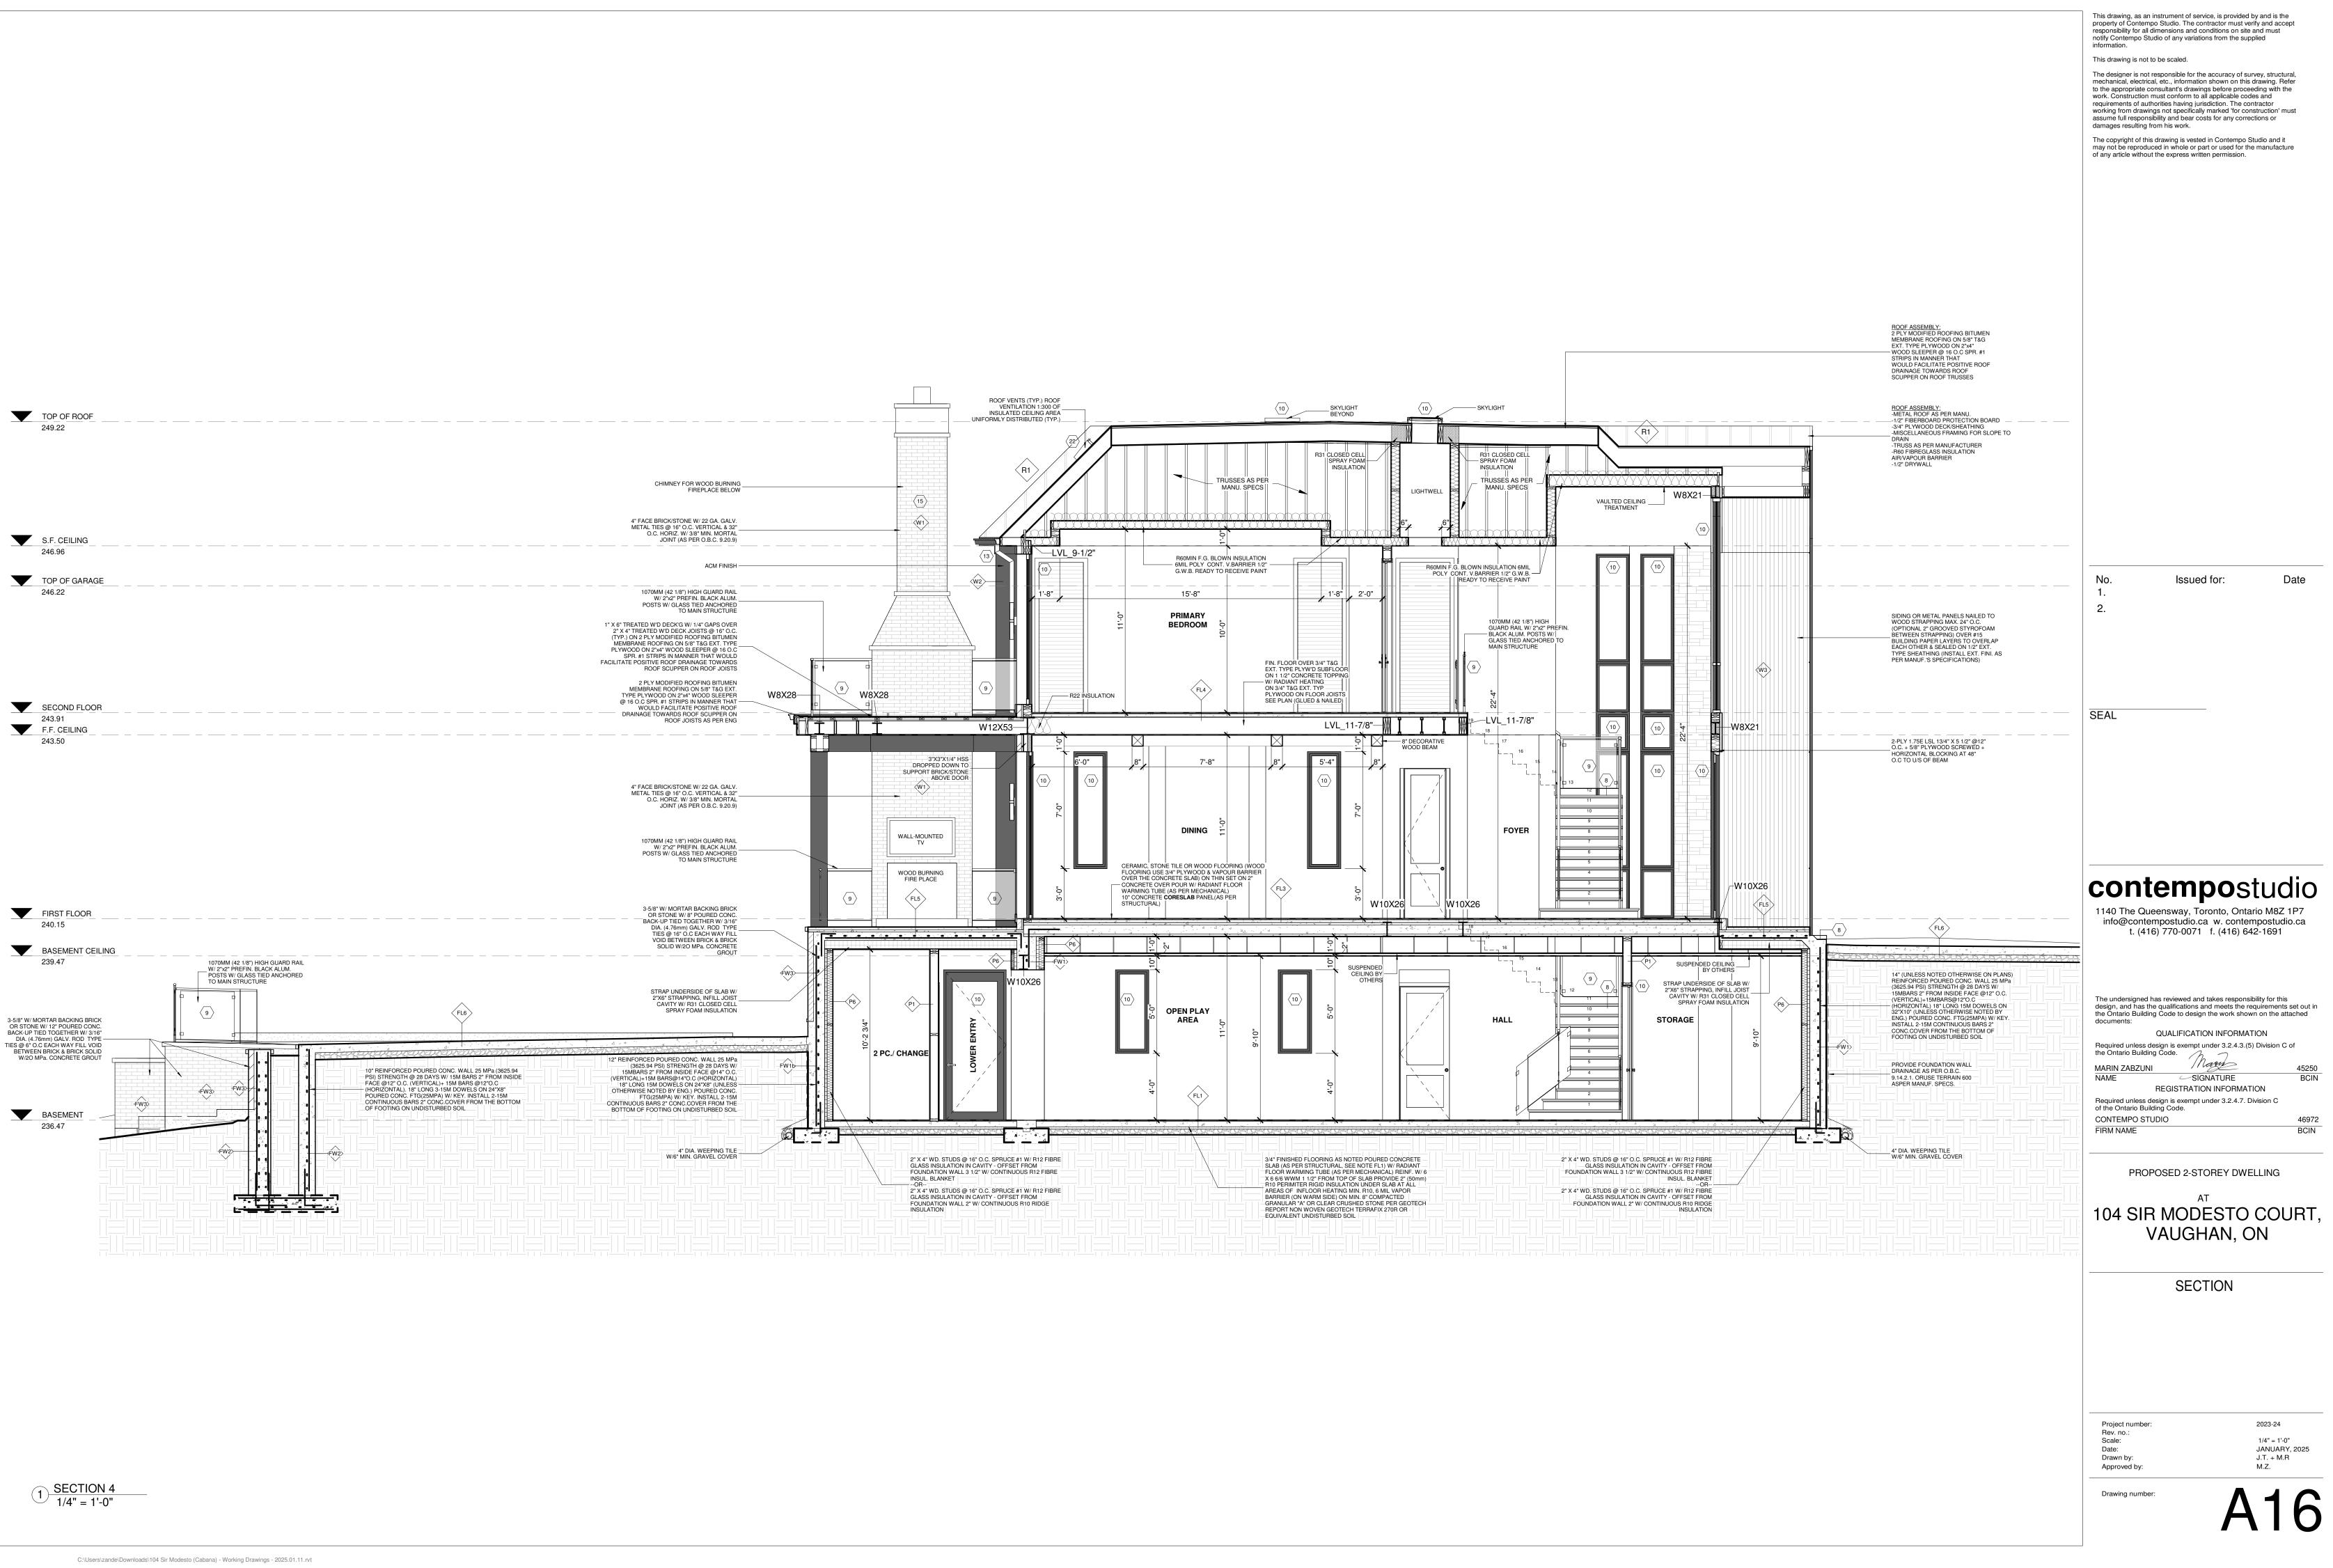

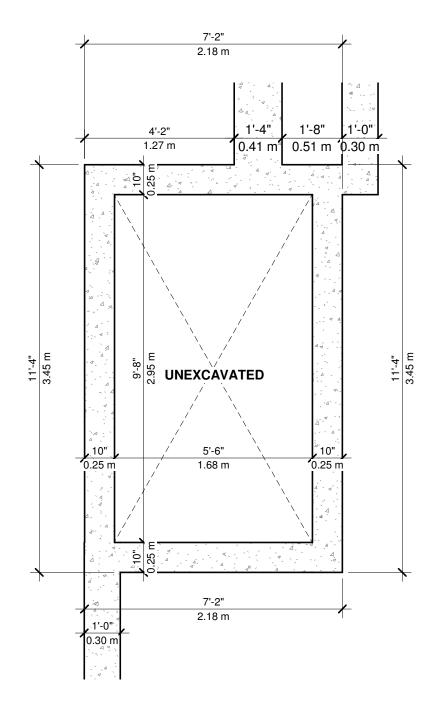

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 MARIN ZABZUNI
 450

 NAME
 SIGNATURE

 45250 BCIN REGISTRATION INFORMATION Required unless design is exempt under 3.2.4.7. Division C of the Ontario Building Code. CONTEMPO STUDIO 46972

BCIN

PROPOSED 2-STOREY DWELLING

104 SIR MODESTO COURT, VAUGHAN, ON

### POOL MECH. FOUNDATION PLAN




Project number: Rev. no.: Scale: Date: Drawn by: Approved by:

FIRM NAME

2023-24 3/8" = 1'-0" JANUARY, 2025 J.T. + M.R M.Z.



C:\Users\zande\Downloads\104 Sir Modesto (Cabana) - Working Drawings - 2025.01.11.rvt

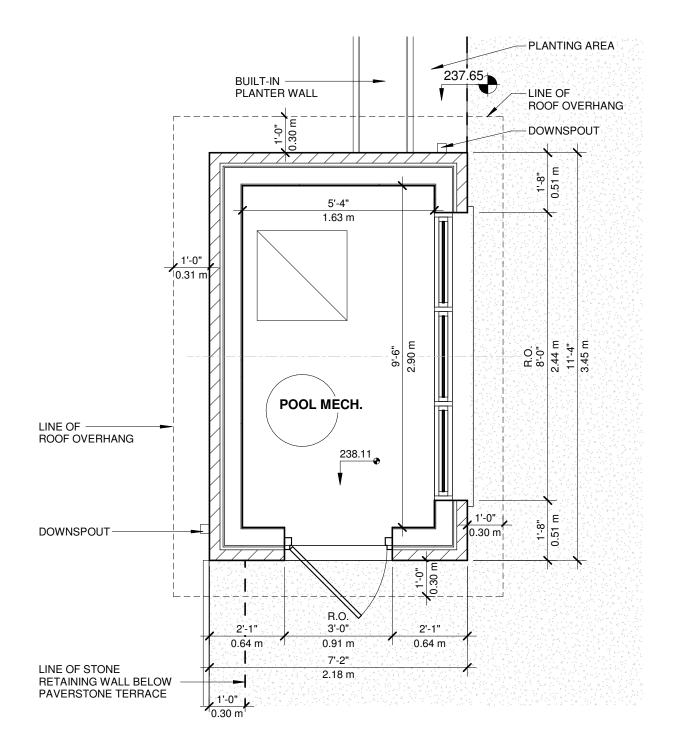

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1140 The Queensway, Toronto, Ontario M8Z 1P7 info@contempostudio.ca w. contempostudio.ca t. (416) 770-0071 f. (416) 642-1691

The undersigned has reviewed and takes responsibility for this design, and has the qualifications and meets the requirements set out in the Ontario Building Code to design the work shown on the attached documents: QUALIFICATION INFORMATION 

 Required unless design is exempt under 3.2.4.3.(5) Division C of the Ontario Building Code.

 MARIN ZABZUNI
 450

 NAME
 SIGNATURE

 45250 BCIN REGISTRATION INFORMATION Required unless design is exempt under 3.2.4.7. Division C of the Ontario Building Code. CONTEMPO STUDIO 46972 FIRM NAME BCIN

PROPOSED 2-STOREY DWELLING

104 SIR MODESTO COURT, VAUGHAN, ON

POOL MECH. FLOOR PLAN




Project number: Rev. no.: Scale: Date: Drawn by: Approved by:

2023-24 3/8" = 1'-0" JANUARY, 2025 J.T. + M.R M.Z.

### $1 \frac{\text{POOL MECH. TOP OF ROOF}}{3/8" = 1'-0"}$

\_\_\_\_\_

13'-4" 4.06 m 11'-0" 3.45 m 3.45 m

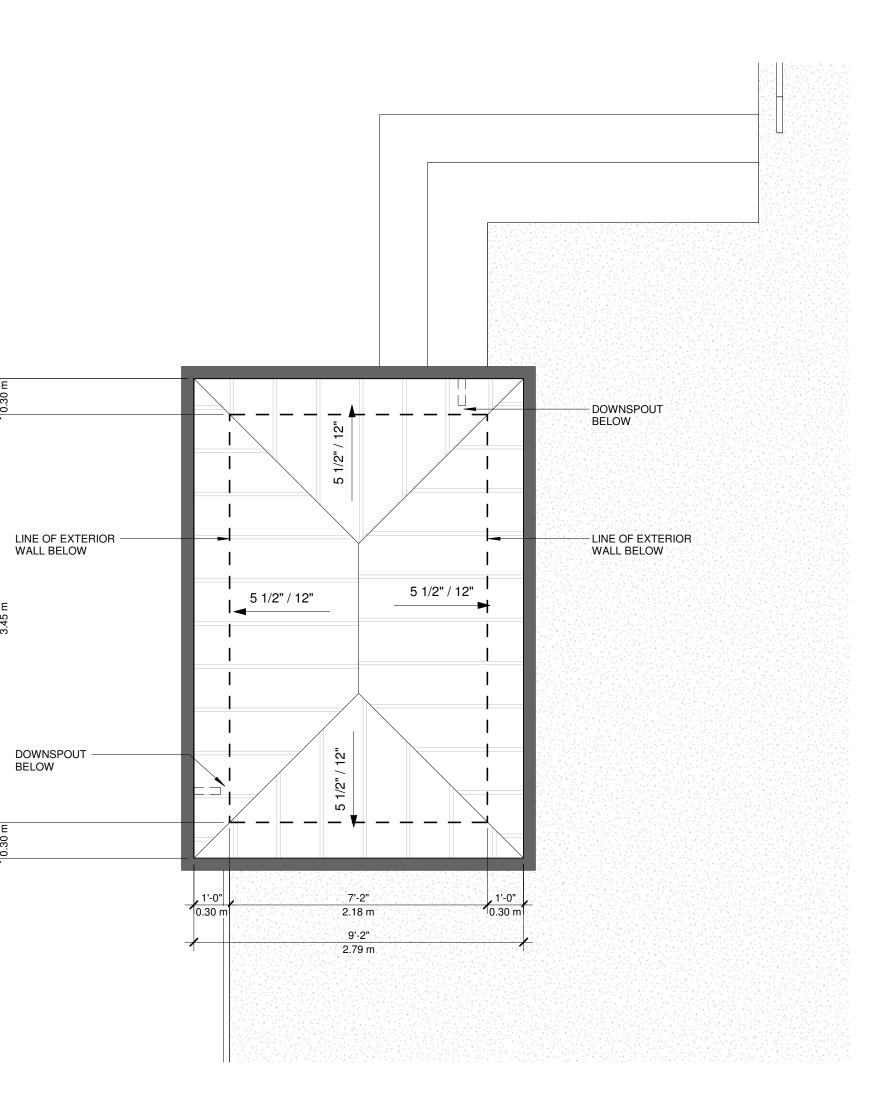

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MARIN ZABZUNI	45250			
NAME SIGNATURE	BCIN			
REGISTRATION INFORMATION				
Required unless design is exempt under 3.2.4.7. Division C of the Ontario Building Code.				
CONTEMPO STUDIO	46972			
FIRM NAME	BCIN			

PROPOSED 2-STOREY DWELLING

### <sup>ат</sup> 104 SIR MODESTO COURT, VAUGHAN, ON

POOL MECH. ROOF PLAN



Project number: Rev. no.: Scale: Date: Drawn by: Approved by: 2023-24 3/8" = 1'-0" JANUARY, 2025 J.T. + M.R M.Z.






to top of roof



 $1 \frac{\text{POOL MECH. FRONT ELEVATION}}{3/8" = 1'-0"}$ 

C:\Users\zande\Downloads\104 Sir Modesto (Cabana) - Working Drawings - 2025.01.11.rvt

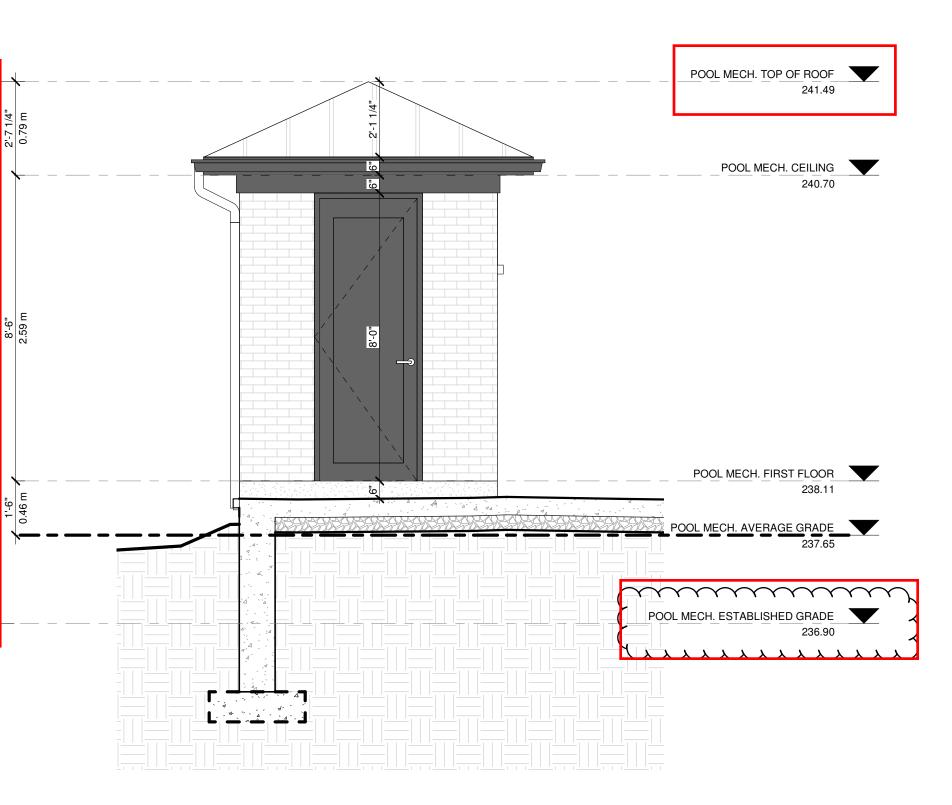

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 MARIN ZABZUNI
 45.

 NAME
 SIGNATURE

 45250 BCIN REGISTRATION INFORMATION Required unless design is exempt under 3.2.4.7. Division C of the Ontario Building Code. CONTEMPO STUDIO 46972 FIRM NAME

PROPOSED 2-STOREY DWELLING

AT 104 SIR MODESTO COURT, VAUGHAN, ON

### POOL MECH. FRONT ELEVATION

Project number: Rev. no.: Scale: Date: Drawn by: Approved by:

2023-24 3/8" = 1'-0" JANUARY, 2025 J.T. + M.R M.Z.


BCIN



### $1 \frac{\text{POOL MECH. LEFT ELEVATION}}{3/8" = 1'-0"}$

 $\rightarrow$ Accessory structure has height of 4.59m from established grade

VARIANCE #3

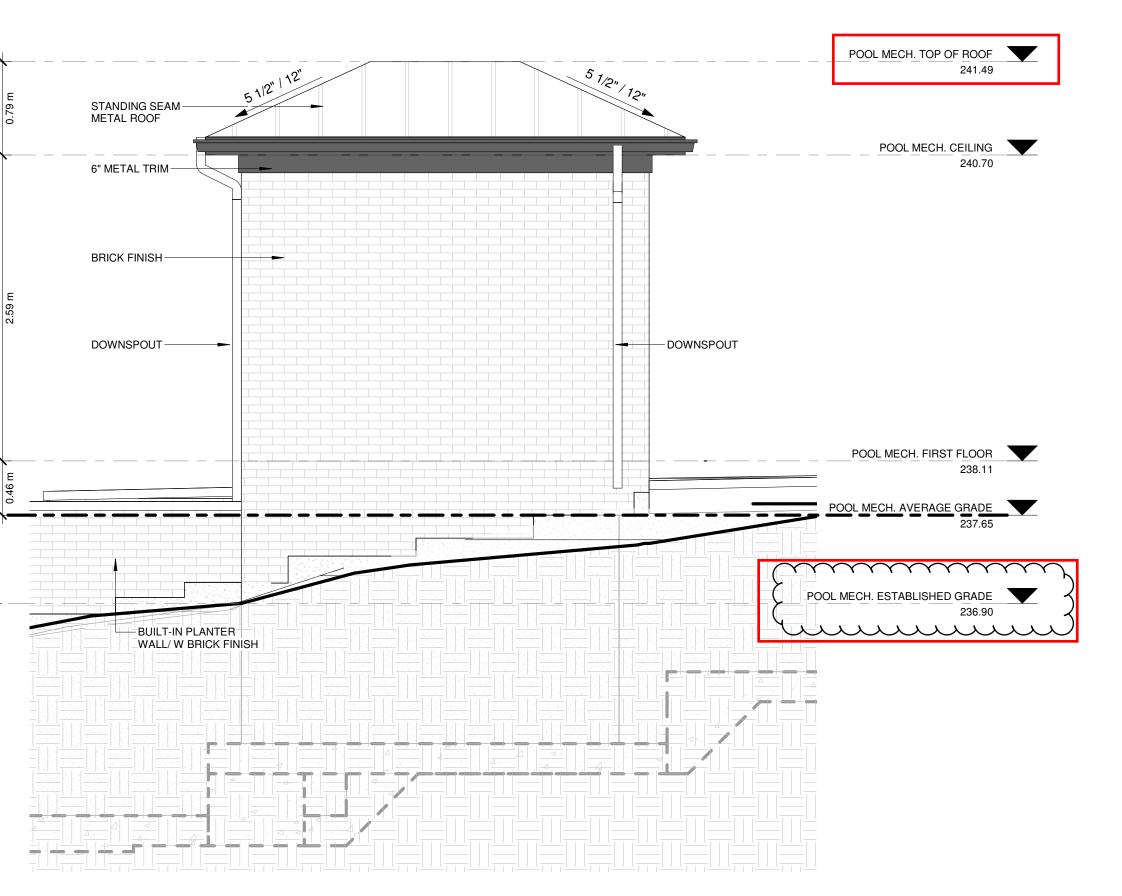

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 Marin ZABZUNI
 45.

 MARIN ZABZUNI
 SIGNATURE
 B

 45250 BCIN REGISTRATION INFORMATION Required unless design is exempt under 3.2.4.7. Division C of the Ontario Building Code. CONTEMPO STUDIO 46972 FIRM NAME BCIN

PROPOSED 2-STOREY DWELLING

104 SIR MODESTO COURT, VAUGHAN, ON

### POOL MECH. LEFT ELEVATION

Project number: Rev. no.: Scale: Date: Drawn by: Approved by:


2023-24 3/8" = 1'-0" JANUARY, 2025 J.T. + M.R M.Z.



VARIANCE #3

Accessory structure has height of 4.59m from established grade to top of roof

<u>د</u>	<b>-</b>	
		2'-7 1/4" 0.79 m
POOL MECH. HEIGHT 15-0 3/4"	4.59 m	8'-6" 2.59 m
		0.46 m
		▼

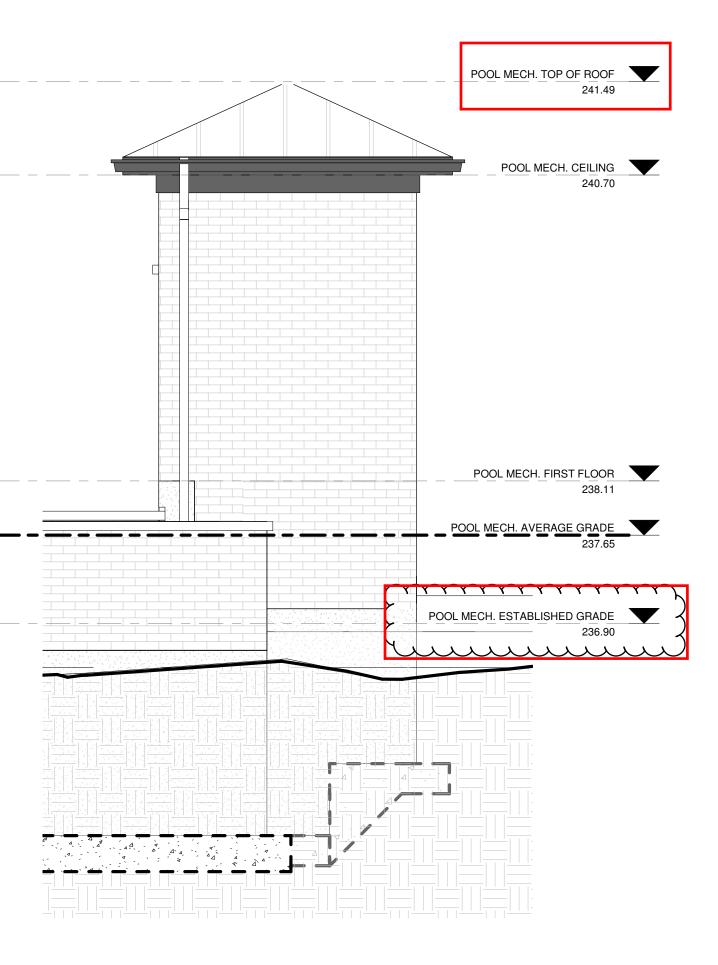

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 MARIN ZABZUNI
 45250

 NAME
 SIGNATURE

 BCIN
 REGISTRATION INFORMATION

 Required unless design is exempt under 3.2.4.7. Division C of the Ontario Building Code.
 46972

 CONTEMPO STUDIO
 46972

 FIRM NAME
 BCIN

PROPOSED 2-STOREY DWELLING

<sup>АТ</sup> 104 SIR MODESTO COURT, VAUGHAN, ON

POOL MECH. REAR ELEVATION

Project number: Rev. no.: Scale: Date: Drawn by: Approved by:

2023-24 3/8" = 1'-0" JANUARY, 2025 J.T. + M.R M.Z.






VARIANCE #3

Accessory structure has height of 4.59m from established grade to top of roof

 $1 \frac{\text{POOL MECH. RIGHT ELEVATION}}{3/8" = 1'-0"}$ 

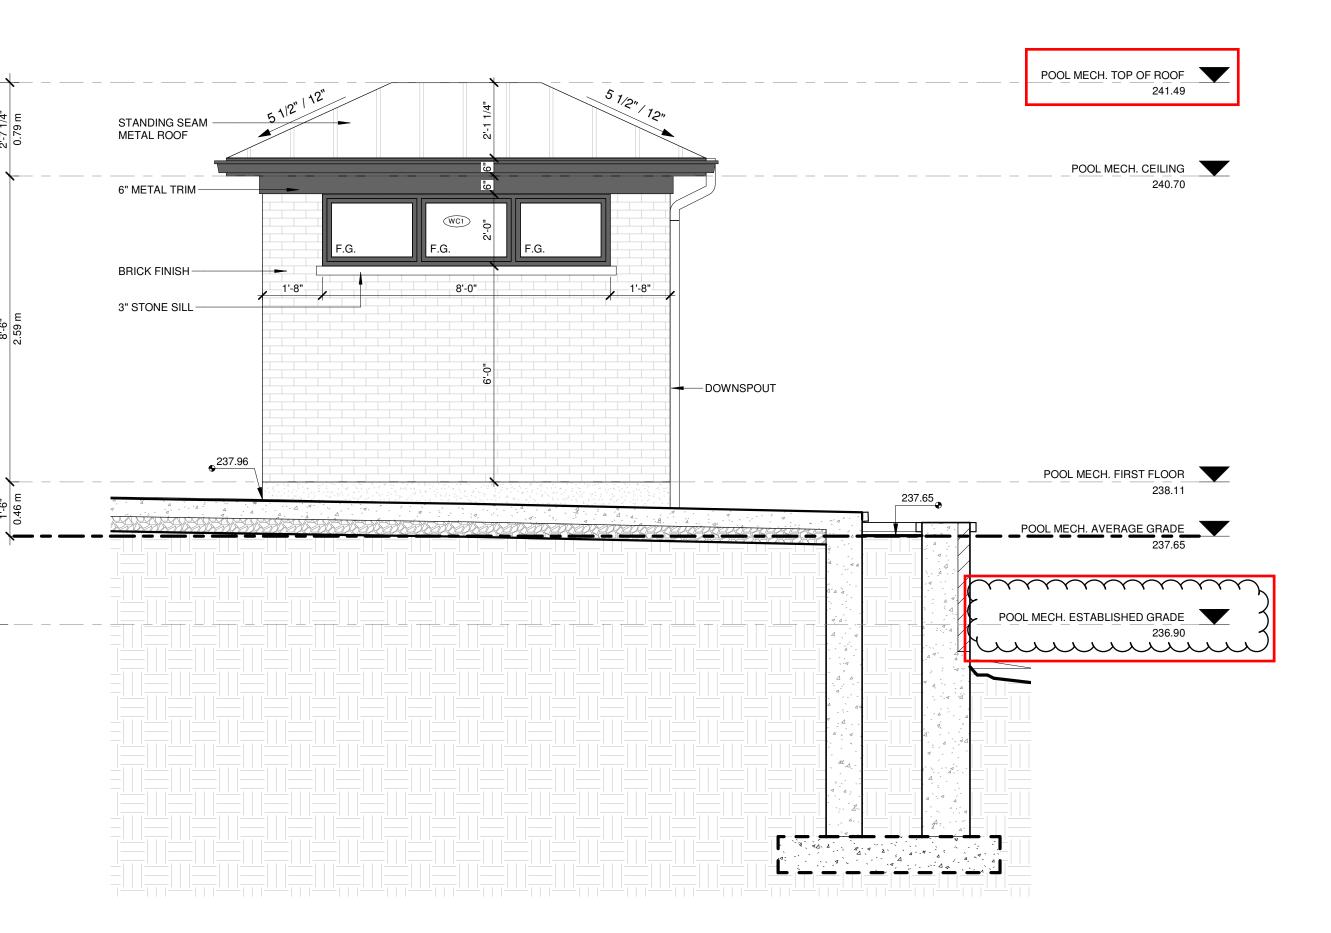

<text><text><text><text>

Issued for:	

Date

SEAL

No.

1.

2

### **contempo**studio

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MARIN ZABZUNI //lavy	45250
NAME SIGNATURE	BCIN
REGISTRATION INFORMATION	
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CONTEMPO STUDIO	46972
FIRM NAME	BCIN


PROPOSED 2-STOREY DWELLING

<sup>АТ</sup> 104 SIR MODESTO COURT, VAUGHAN, ON


### POOL MECH. RIGHT ELEVATION

Project number: Rev. no.: Scale: Date: Drawn by: Approved by: 2023-24 3/8" = 1'-0" JANUARY, 2025 J.T. + M.R M.Z.




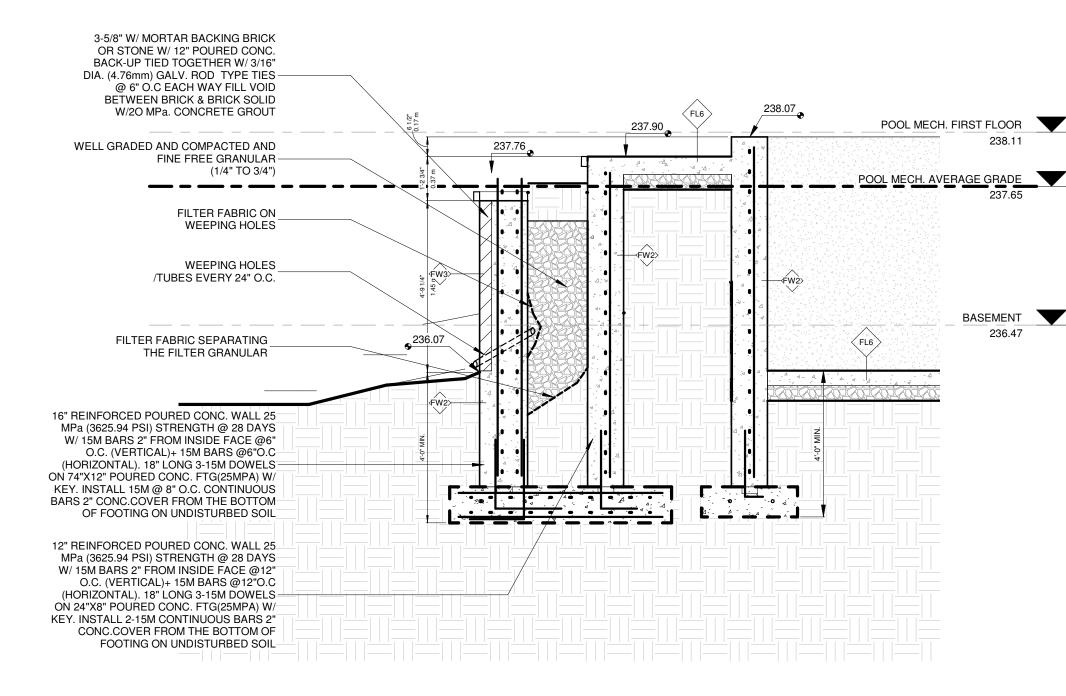


 $1 \frac{\text{RETAINING WALL SECTION 1}}{3/8" = 1'-0"}$ 

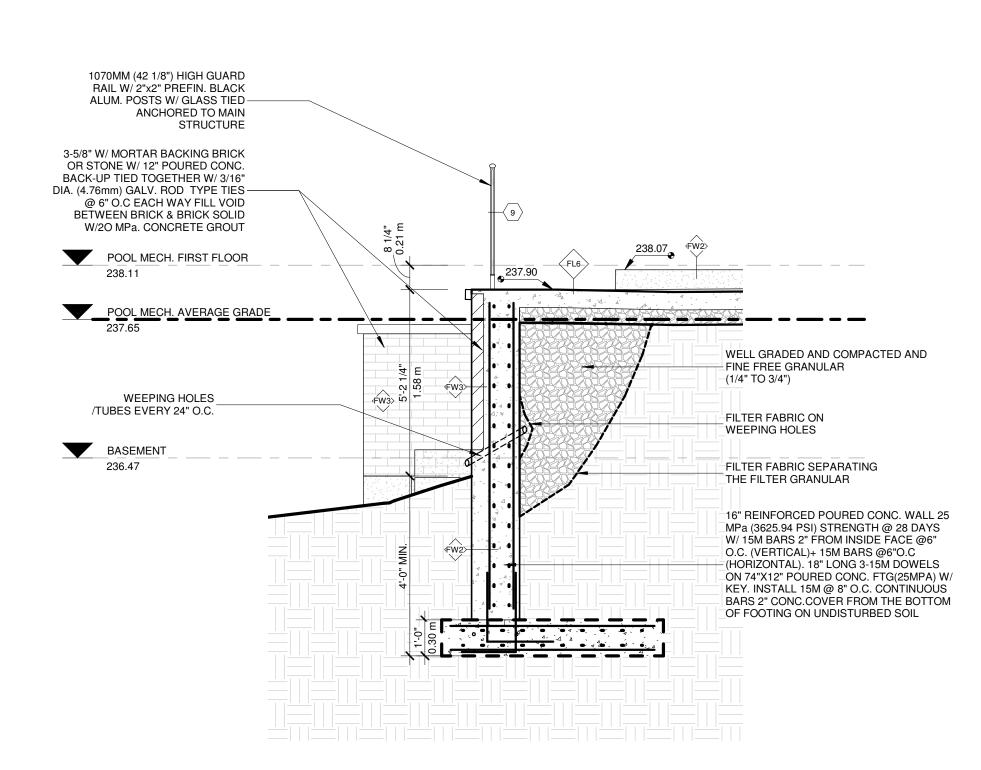

2 RETAINING WALL SECTION 2 3/8" = 1'-0"

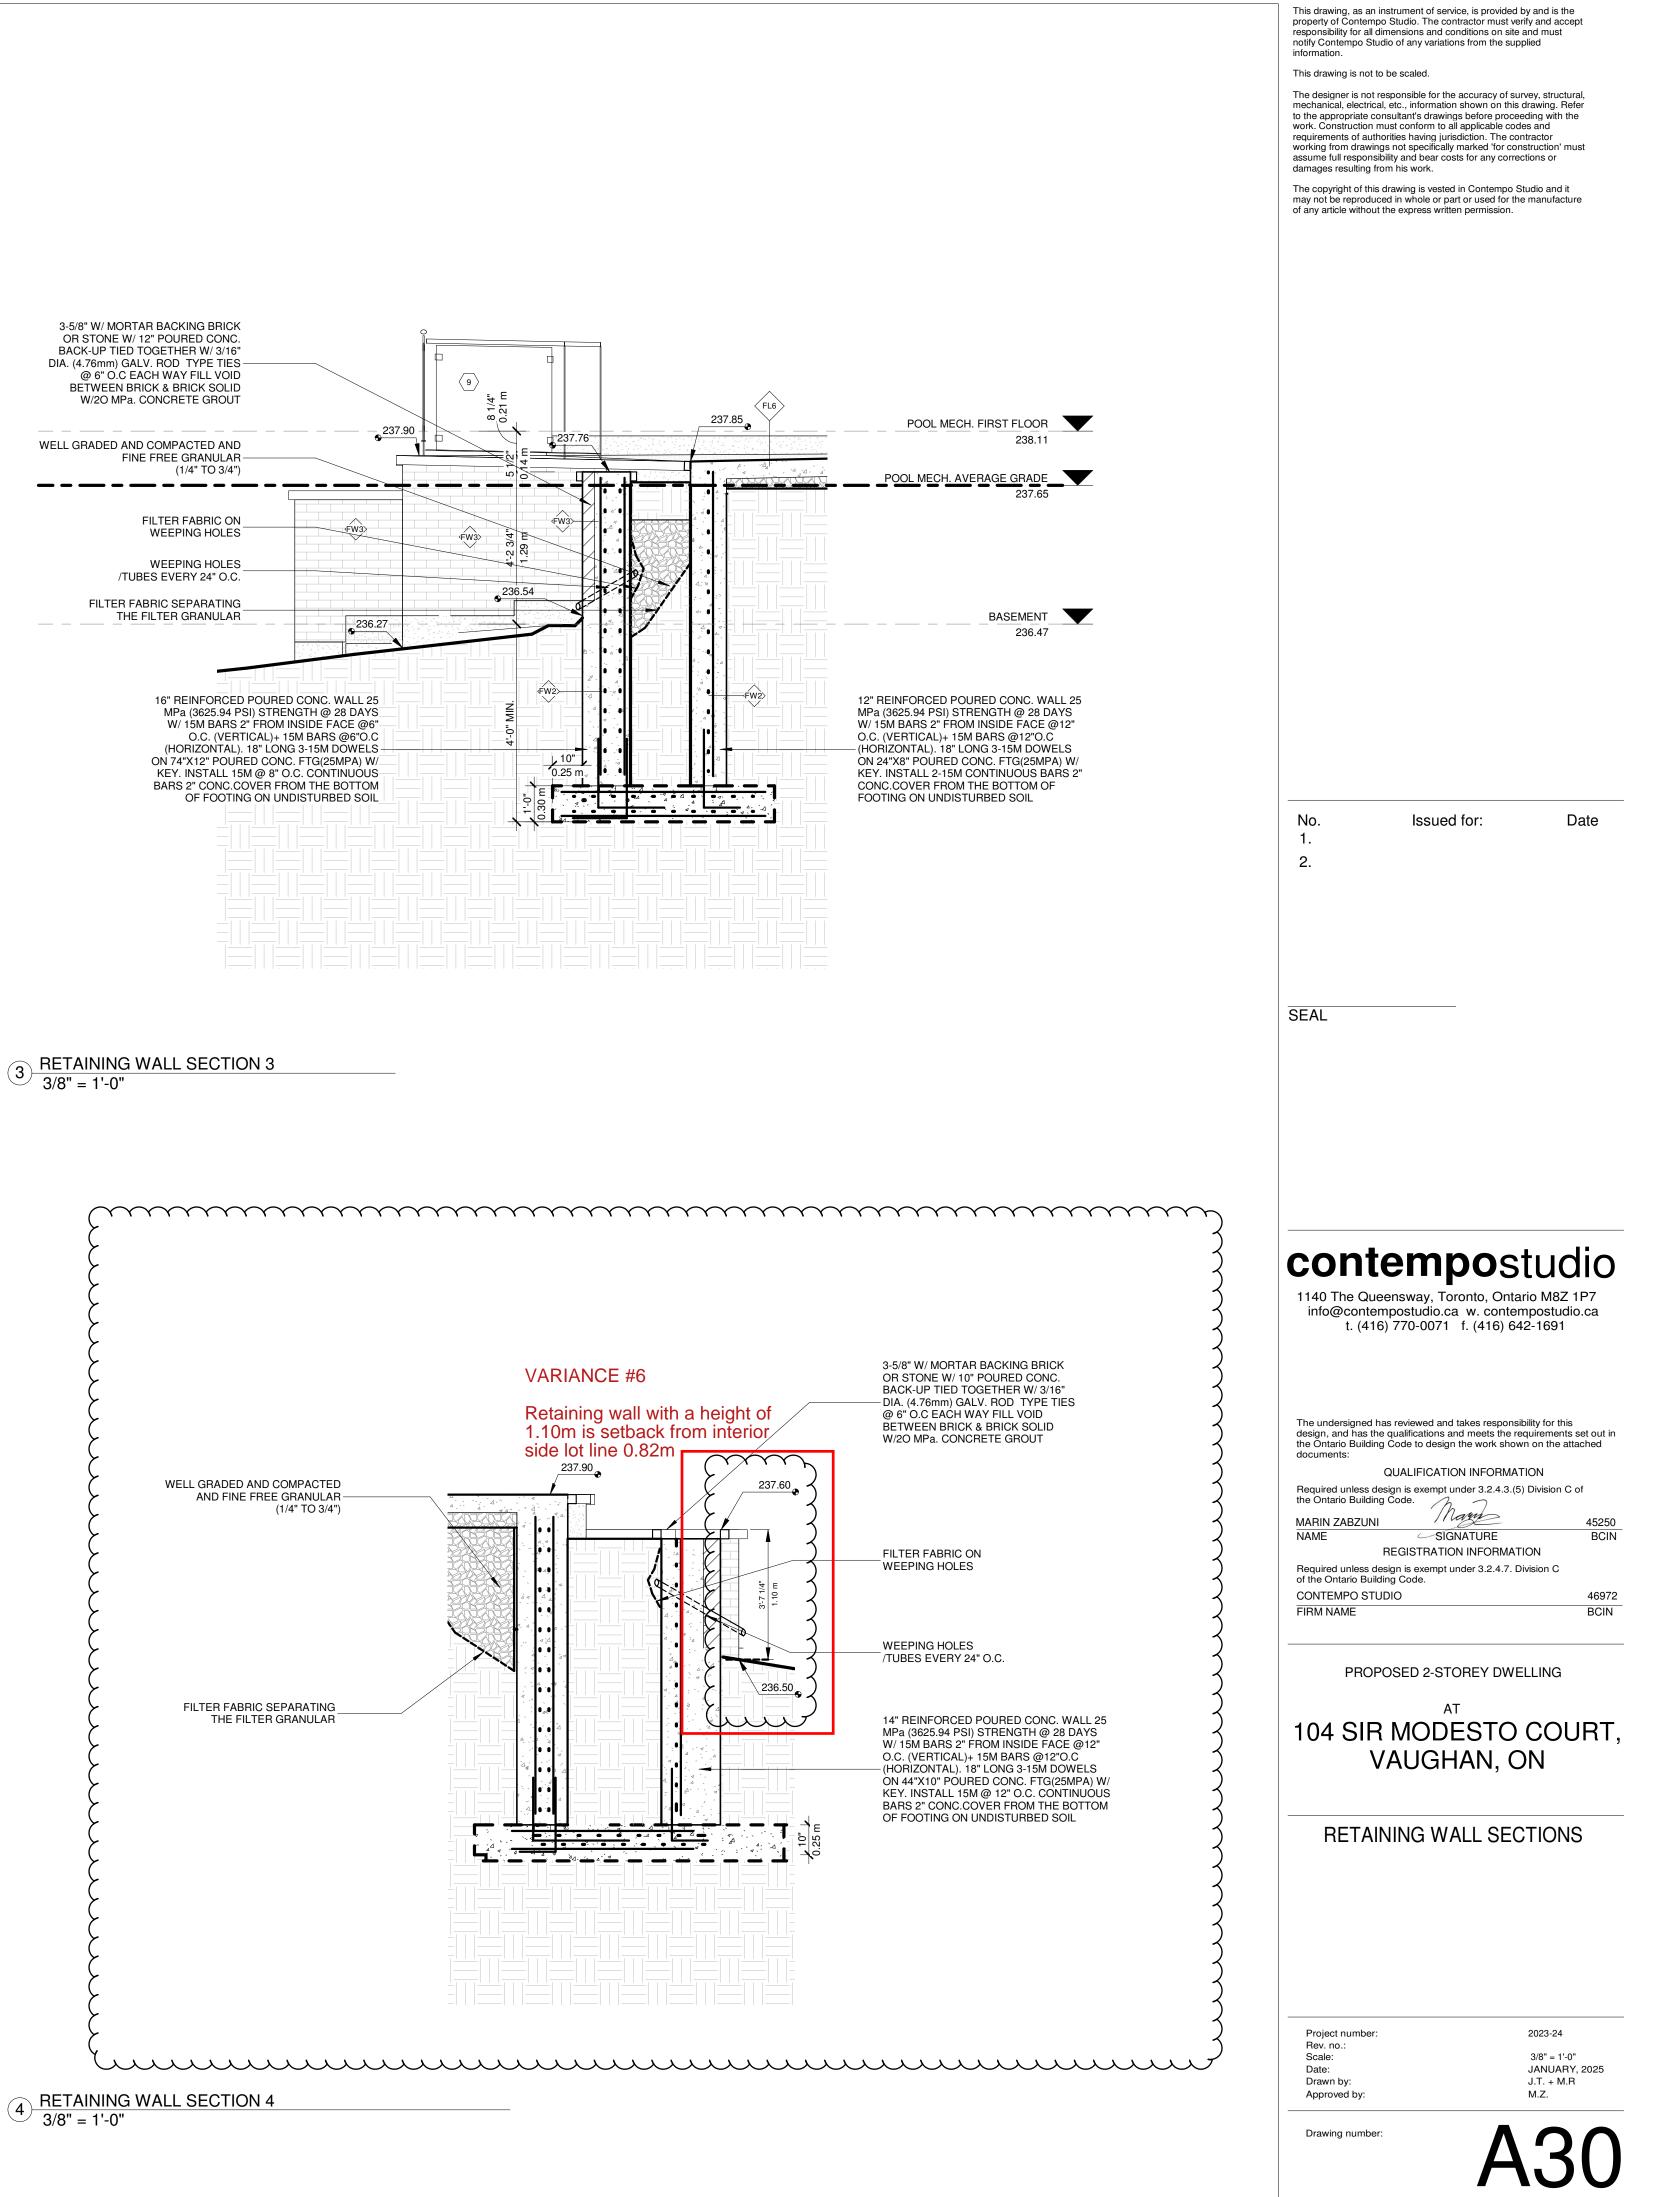

 $\bigcirc \frac{\text{RETAINING WALL SECTION 3}}{3/8" = 1'-0"}$ 

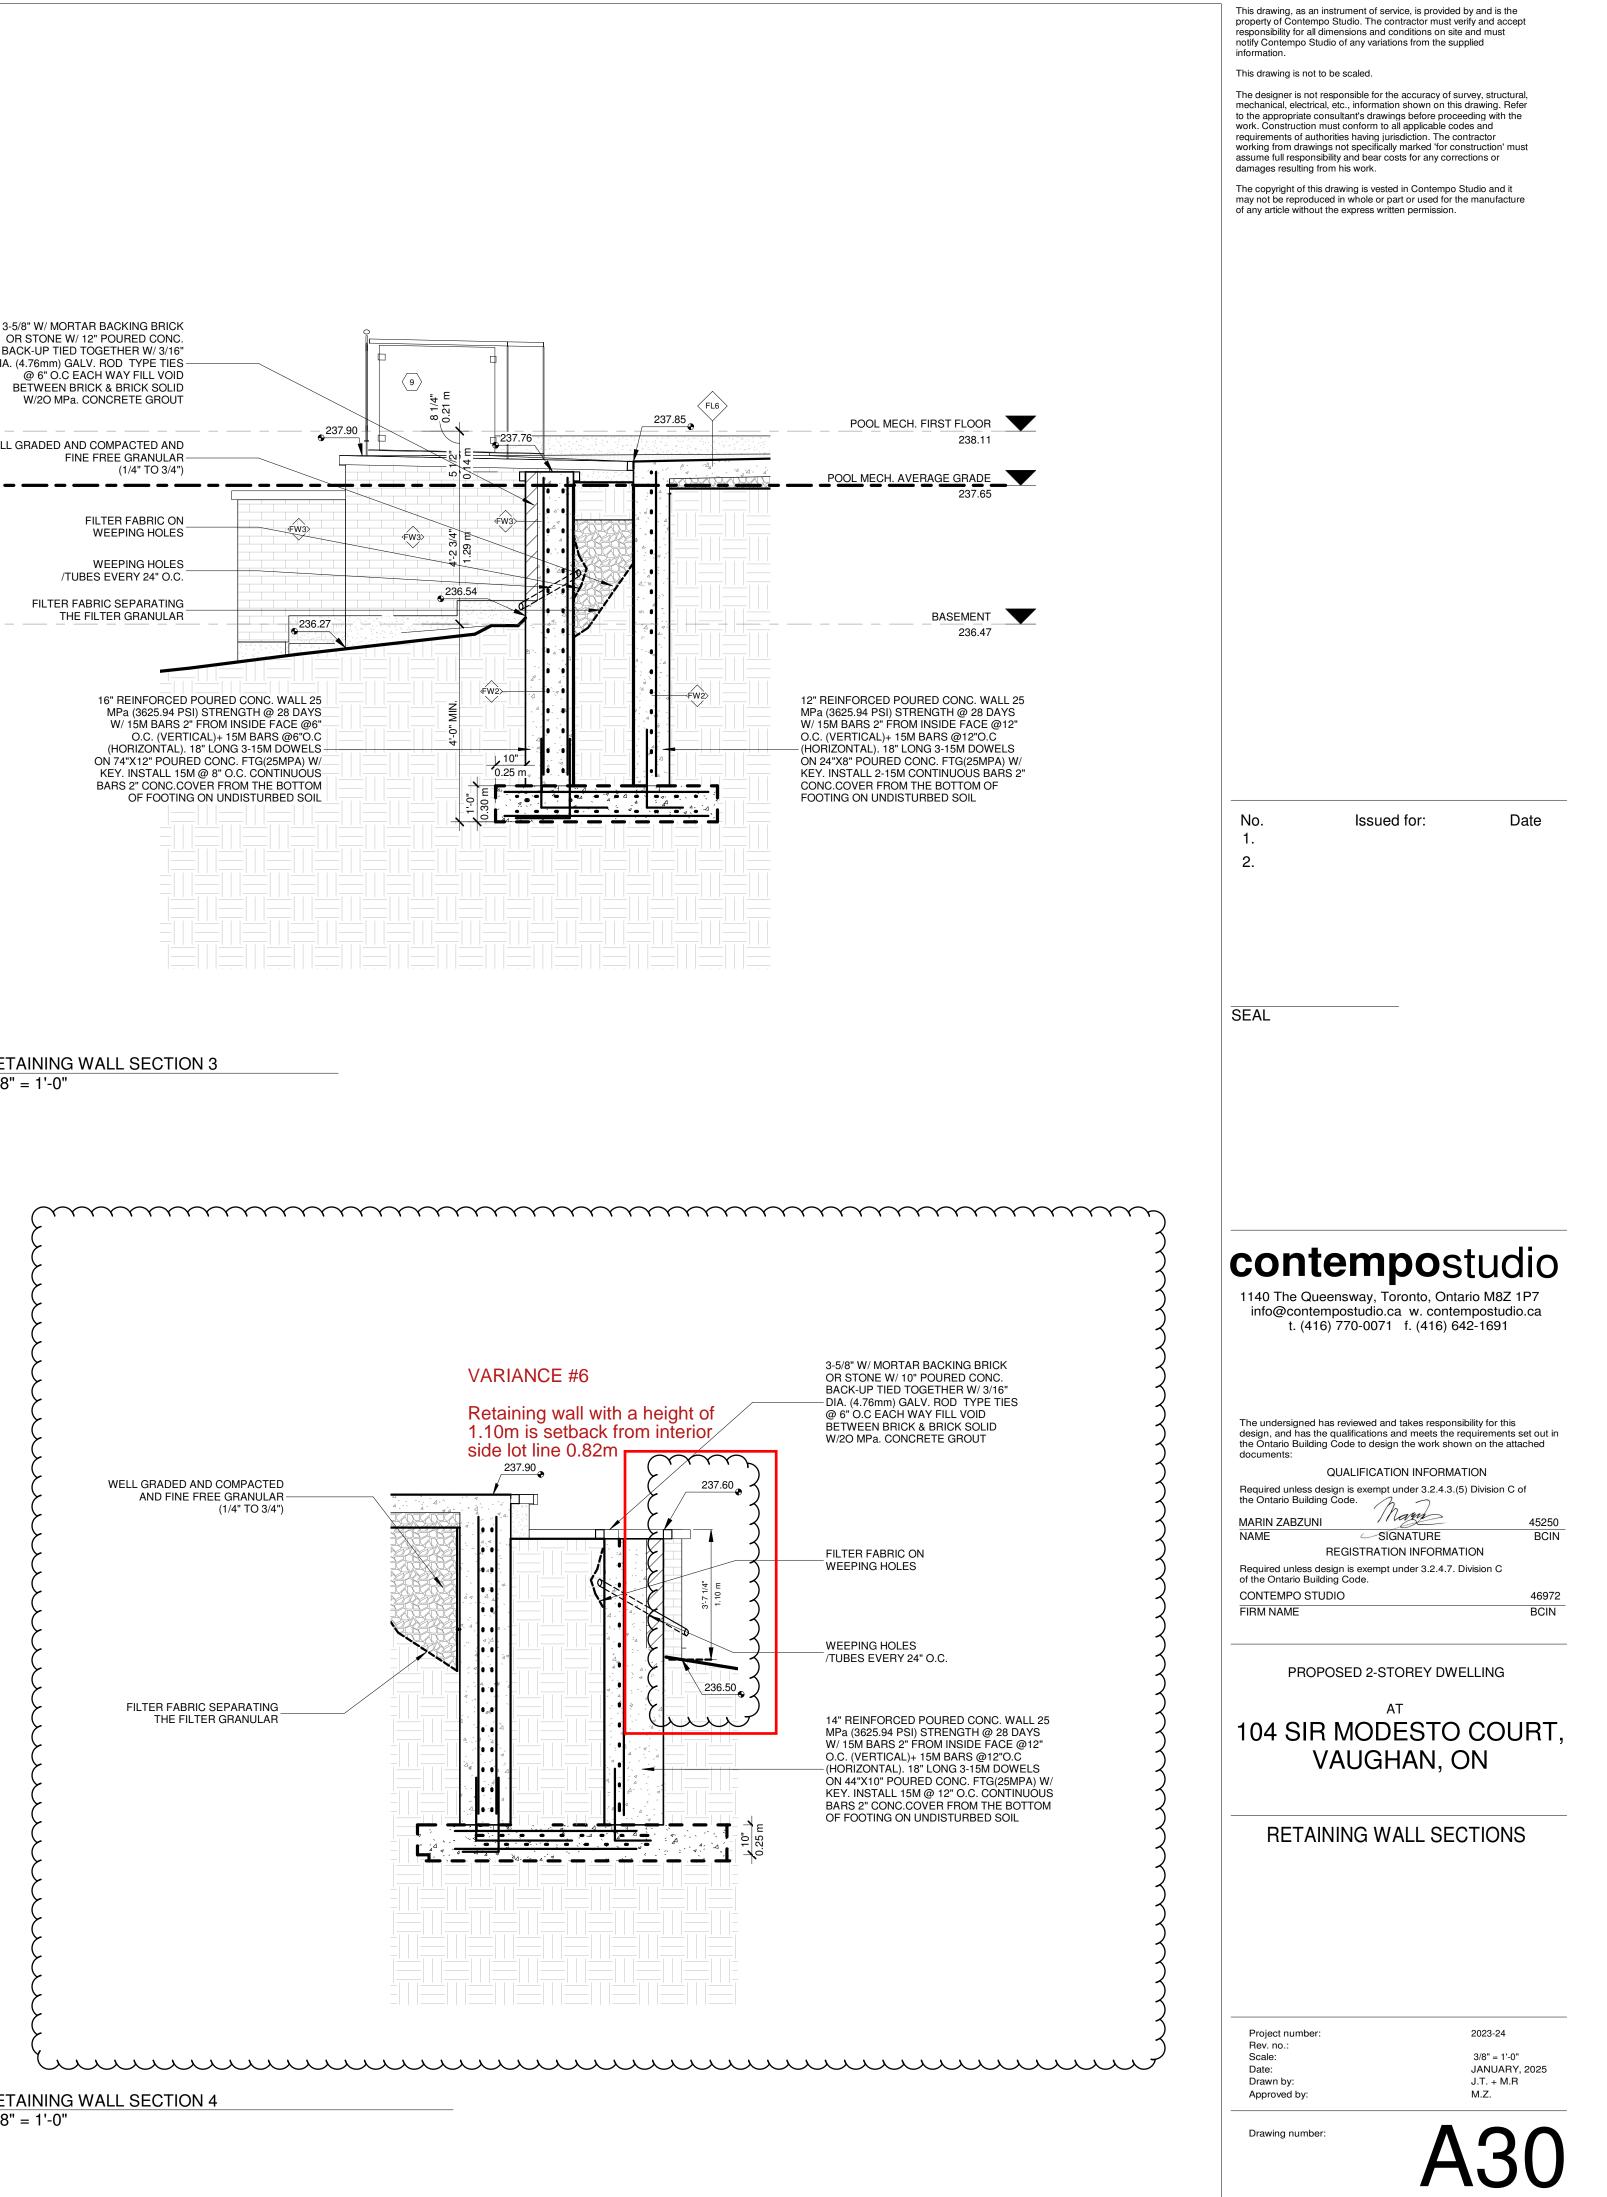

### SCHEDULE B: COMMENTS FROM AGENCIES, BUILDING STANDARDS & DEVELOPMENT PLANNING

Internal Departments *Comments Received	Condition	s Required	Nature of Comments
Building Standards (Zoning)	Yes 🗆	No 🖂	General Comments
Development Planning	Yes 🗆	No 🖂	Recommend Approval/No Conditions
External Agencies	Condition	s Required	Nature of Comments
External Agencies *Comments Received Alectra	Condition	s Required	Nature of Comments           *See Schedule B for full comments           General Comments
*Comments Received		•	*See Schedule B for full comments



Date:	February 12 <sup>th</sup> 2025
Attention:	Christine Vigneault
RE:	Request for Comments
File No.:	A013-25
Related Files:	
Applicant	Ori Smith



### COMMENTS:

X

We have reviewed the proposed Variance Application and have no comments or objections to its approval.

We have reviewed the proposed Variance Application and have no objections to its approval, subject to the following comments (attached below).

We have reviewed the proposed Variance Application and have the following concerns (attached below).

Alectra Utilities (formerly PowerStream) has received and reviewed the proposed Variance Application. This review, however, does not imply any approval of the project or plan.

All proposed billboards, signs, and other structures associated with the project or plan must maintain minimum clearances to the existing overhead or underground electrical distribution system as specified by the applicable standards, codes and acts referenced.

In the event that construction commences, and the clearance between any component of the work/structure and the adjacent existing overhead and underground electrical distribution system violates the Occupational Health and Safety Act, the customer will be responsible for 100% of the costs associated with Alectra making the work area safe. All construction work will be required to stop until the safe limits of approach can be established.

In the event construction is completed, and the clearance between the constructed structure and the adjacent existing overhead and underground electrical distribution system violates the any of applicable standards, acts or codes referenced, the customer will be responsible for 100% of Alectra's cost for any relocation work.

#### **References:**

- Ontario Electrical Safety Code, latest edition (Clearance of Conductors from Buildings)
- Ontario Health and Safety Act, latest edition (Construction Protection)
- Ontario Building Code, latest edition (Clearance to Buildings)
- PowerStream(Construction Standard 03-1, 03-4, 03-9), attached
- Canadian Standards Association, latest edition (Basic Clearances)

If more information is required, please contact either of the following:

Stephen Cranley, C.E.T

Supervisor, Distribution Design, ICI & Layouts (North) *Phone*: 1-877-963-6900 ext. 31297

*E-mail*: <u>stephen.cranley@alectrautilities.com</u>

Mitchell Penner

Supervisor, Distribution Design-Subdivisions *Phone*: 416-302-6215


Email: Mitchell.Penner@alectrautilities.com



### Construction Standard

03-1

		SYSTEM	VOLTAGE	
LOCATION OF WIRES, CABLES OR CONDUCTORS	SPAN GUYS AND COMMUNICATIONS WIRES		4.16/2.4kV TO 27.6/16kV (SEE NOTE 1)	44kV
	мінімим	VERTICAL CLE	ARANCES (SEE	NOTE 2)
OVER OR ALONGSIDE ROADS, DRIVEWAYS OR LANDS ACCESSIBLE TO <u>VEHICLES</u>	442cm	442cm	480cm	520cm
OVER GROUND ACCESSIBLE TO <u>PEDESTRIANS</u> AND <u>BICYCLES</u> ONLY	250cm	310cm	340cm	370cm
ABOVE TOP OF RAIL AT RAILWAY CROSSINGS	730cm	730cm	760cm	810cm

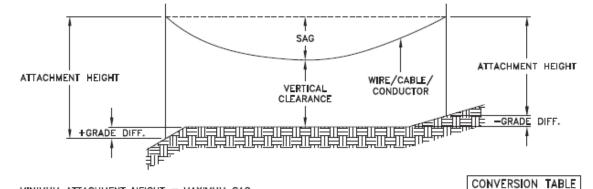

- MINIMUM ATTACHMENT HEIGHT = MAXIMUM SAG + MINIMUM VERTICAL CLEARANCE (FROM ABOVE TABLE) ± GRADE DIFFERENCE
  - + 0.3m (VEHICLE OR RAILWAY LOCATION) + SNOW DEPTH (PEDESTRIAN LOCATION, SEE NOTE 3)

NOTES:

- 1. THE MULTIGROUNDED SYSTEM NEUTRAL HAS THE SAME CLEARANCE AS THE 600V SYSTEM.
- 2. THE VERTICAL CLEARANCES IN THE ABOVE TABLE ARE UNDER MAXIMUM SAG CONDITIONS.
- 3. REFER TO CSA STANDARD C22.3 No.1, ANNEX D FOR LOCAL SNOW DEPTH VALUES.
- 4. ALL CLEARANCES ARE IN ACCORDANCE TO CSA STANDARD C22.3.

MINIMUM VERTICAL CLEARANCES OF

WIRES, CABLES AND CONDUCTORS ABOVE GROUND OR RAILS

SAGS AND TENSIONS SECTION 02 Certificate of Approval This construction Standard meets the safety requirements of Section 4 of Regulation 22/04 2012-JAN-09 Date Joe Crozier, P.Eng. Name P.Eng. Approval By: Joe Crozier

METRIC

810cm

760cm 730cm

520cm

480cm

442cm 370cm

340cm

310cm

250cm

REFERENCES

IMPERIAL (APPROX)

27'-0" 25'-4"

24'-4" 17'-4"

16'-0' 15'-5


12'-4

11'-4

10'-4

8'-

ORIGINAL ISSUE DATE: 2010-DEC-24 REVISION NO: R1 REVISION DATE: 2012-JAN-09

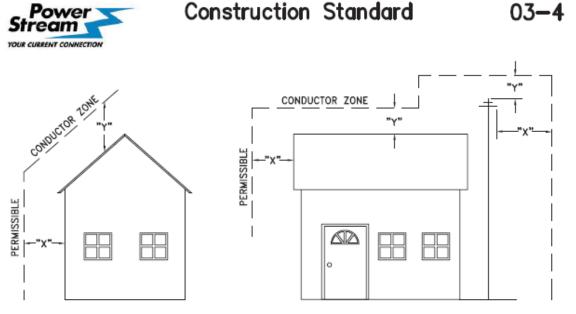

VOLTAGE	MINIMUM HORIZONTAL CLEARNACE UNDER MAXIMUM SWING CONDITIONS DIMENSION "X" (SEE NOTES 1, 3 & 4)	MINIMUM VERTICAL CLEARANCE UNDER MAXIMUM DESIGN SAG CONDITIONS DIMENSION "Y" (SEE NOTES 1, 2, 4 & 5)
0-600V AND NEUTRAL	100cm	250cm
4.16/2.4 TO 44kV	300cm	480cm

- NOTES UNDER NO CIRCUMSTANCES SHALL A CONDUCTOR BE PERMITTED TO PENETRATE THE ENVELOPE SHOWN BY THE DOTTED LINE. 1.
- THE VERTICAL CLEARANCES ARE UNDER CONDITIONS OF MAXIMUM DESIGN SAG. 2.
- THE HORIZONTAL CLEARANCES ARE UNDER CONDITIONS OF MAXIMUM SWING. WHERE THE CONDUCTOR SWING IS NOT KNOWN A HORIZONTAL CLEARANCE OF 480CM SHALL BE USED. 3.
- BUILDINGS THAT EXCEED 3 STOREYS OR 15M IN HEIGHT, THE MINIMUM HORIZONTAL CLEARANCE OF THE SECONDARY CONDUCTORS SHOULD BE INCREASED TO 300cm WHERE IT IS NECESSARY TO ALLOW FOR THE RAISING OF LADDERS BY LOCAL FIRE DEPARTMENTS. 4.
- IN SITUATIONS SUCH AS MULTI-LEVEL GARAGES, WHERE ROOFS ARE NORMALLY USED BY PERSONS AND VEHICLES, THE VERTICAL CLEARANCES OF POWERSTREAM STANDARD 03-1 5. SHALL APPLY.
- DISTRIBUTION LINES CONSTRUCTED NEAR BUILDINGS SHALL BE BUILT TO AVOID OVERHANG WHEREVER POSSIBLE. WHERE LINES MUST BE CONSTRUCTED OVER OR ADJACENT TO BUILDINGS THE APPLICABLE HORIZONTAL AND VERTICAL CLEARANCES SHALL BE AT CONDITIONS OF MAXIMUM CONDUCTOR SWING AND MAXIMUM SAG. THE ABOVE CLEARANCES ARE DESIGNED TO PREVENT PERSONS ON OR IN BUILDINGS AS WELL AS EXTERNAL MACHINERY USED IN CONJUCTION WITH A BUILDING TO COME IN CONTACT WITH CONDUCTORS. EFFORTS SHOULD BE MADE TO INCREASE THESE CLEARANCES WHERE POSSIBLE 6. POSSIBLE.

7. ALL CLEARANCES ARE IN ACCORDANCE TO CSA C22.3 NO.1-06 (TABLE-9).

MINIMUM VERTICAL & HORIZONTAL CLEARANCES OF CONDUCTORS FROM BUILDINGS OR OTHER PERMANENT STRUCTURES (CONDUCTORS NOT ATTACHED TO BUILDINGS)

IMPERIAL (APPROX) METRIC 480cm 16'-0" 10'-0" 300cm 8'-4" 250cm 3'-4" 100cm

CONVERSION TABLE

ORIGINAL ISSUE DATE: 2010-MAY-05 REVISION NO: REVISION DATE: #System Planting and Standards/Standard Design/PowerStream Standards/PowerStream Standards working region/Sterilon 3/S-4/0/WG 03-4 R0 May 5, 2010;4


Certificate of Approval This construction Standard meets the safety requirements of Section 4 of Regulation 22/04 2010-MAY-05 Date Debbie Dadwani, P.Eng. Name P.Eng. Approval By: D. Dadwani

V5/2010 8:22502 AM.



### Construction Standard



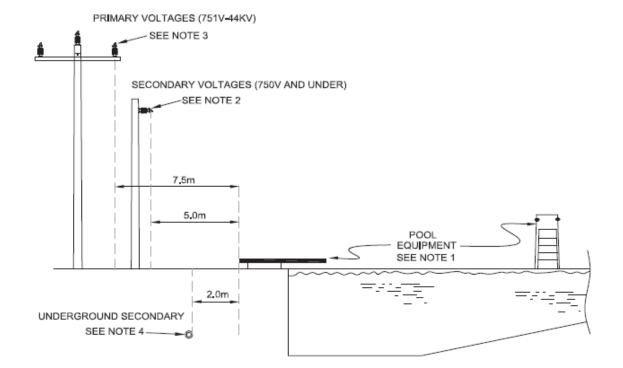

#### NOTES:

- 1. ANY STRUCTURE WITHIN 5.0 METRES OF POOL EDGE SHALL BE CONSIDERED PART OF THE POOL.
- THERE SHALL NOT BE ANY OVERHEAD SECONDARY OR COMMUNICATION WIRING (750V OR LESS) ABOVE THE POOL, AND ABOVE OTHER ELEVATED SURFACES ASSOCIATED WITH THE POOL, INCLUDING BUT NOT RESTRICTED TO A DIVING STRUCTURE, SLIDE, SWINGS, OBSERVATION STAND, TOWER OR PLATFORM, OR ABOVE THE ADJACENT AREA EXTENDING 5.0M HORIZONTALLY FROM THE POOL EDGE.
- 3. THERE SHALL NOT BE ANY OVERHEAD PRIMARY WIRING (751V 44KV) ABOVE THE POOL AND OTHER ELEVATED SURFACES ASSOCIATED WITH THE POOL, OR ABOVE THE ADJACENT AREA EXTENDING 7.5M HORIZONTALLY FROM THE POOL EDGE.
- ANY UNDERGROUND CONDUCTORS SHALL BE 2.0M AWAY FROM POOL EDGE IN DUCT WITH NON-CONDUCTING JACKET. FOR DEPTH AND DUCT DETAILS REFER TO FIGURE 3 IN 25-100 FOR 200A SERVICE AND 25-101 FOR 400A SERVICE RESPECTIVELY, AS PER POWERSTREAM SERVICE DESIGN SPECIFICATIONS.
- 5. THESE DIMENSIONS APPLY TO ALL SIDES OF THE POOL.

#### MINIMUM CLEARANCES FOR CONDUCTORS ADJACENT TO SWIMMING POOLS

ORIGINAL ISSUE DATE: 2013-JUNE-12

REVISION NO: R0 REVISION DATE:

CONVERSION TABLE	
METRIC	IMPERIAL (APPROX.)
7.5m	24'-6"
5.0m	16'-3"
2.0m	6'-6"

REFERENCES		
FIGURE 3, 25-100	SECTION 25	
FIGURE 3, 25-101	SECTION 25	

Certificate of Approval This construction Standard meets the safety requirements of Section 4 of Regulation 22/04	
Joe Crozier, P.Eng. Name	2013-JUN-12 Date
P.Eng. Approval By:	Joe Crozier



То:	Committee of Adjustment
From:	Catherine Saluri, Building Standards Department
Date:	February 10, 2025
Applicant:	Ori Smith
Location:	104 Sir Modesto Court PLAN 65M4184 Block 48
File No.(s):	A013/25

### Zoning Classification:

The subject lands are zoned R2A Second Density Residential Zone subject to Exception 14.847 and 14.850 under Zoning Bylaw 001-2021.

#	Zaning By Jow 001 2021	Variance requested
<b>#</b> 1	<b>Zoning By-law 001-2021</b> For a lot with a lot frontage greater than 12 m, a maximum driveway width of 9 m is permitted. [6.7.3, Table 6-11]	Variance requested To permit a maximum driveway width of 10.26 m for a lot with a lot frontage greater than 12 m.
2	A minimum setback of 1.13 m is required from the southeasterly lot line to the retaining wall (window well). [4.13]	To permit a retaining wall (2 window well) with a height of 1.13 m to be setback a minimum of 0.62 m from the southeasterly lot line.
3	A maximum height of 3.0 m is permitted for a residential accessory structure. [4.1.4.1]	To permit a residential accessory structure (pool mechanical) with a height of 4.59 m.
4	An uncovered platform (paverstone terrace), with a floor height greater than 1.2 m as measured above grade and including access stairs, is permitted to encroach to a maximum of 2.4 m into the minimum required rear yard of 7.5 m [4.13] A setback of 5.1 m from the rear lot line is required.	To permit an uncovered platform (paverstone terrace) with a height of 2.0 m to encroach to a maximum of 5.28 m into the minimum required rear yard of 7.5 m. A setback of 2.22 m from the rear lot line is proposed.
5	Where the height of an outdoor swimming pool is greater than 1.5 m, the minimum setback from any lot line shall be 3.0 m. [4.21.6]	To permit an outdoor swimming pool with a height of 2.0 m to be setback 2.04 m from the easterly interior side lot line.
6	A minimum setback of 1.1 m is required from the northeasterly lot line to the retaining wall. [4.13]	To permit a retaining wall with a height of 1.1 m to be setback a minimum of 0.82 m from the northeasterly interior side lot line.

### Staff Comments:

### **Other Comments:**

Ge	neral Comments
1	The applicant shall be advised that additional variances may be required upon review of detailed drawing for building permit.
2	The subject lands may be subject to Ontario Regulation 166/06 (TRCA - Toronto and Region Conservation Authority).
3	The subject lands may be located within the Oak Ridges Moraine.
4	The Applicant should consult with the Fire Prevention Department, City of Vaughan, about the wood burning fireplace for bylaw requirements.



### **Conditions of Approval:**

If the committee finds merit in the application, the following conditions of approval are recommended.

None

\* Comments are based on the review of documentation supplied with this application.



То:	Christine Vigneault, Committee of Adjustment Secretary Treasurer		
From:	Nancy Tuckett, Director of Development and Parks Planning		
Date:	March 11, 2025		
Name of Owners:	Benjamin Smith, Ori Smith		
Location:	104 Sir Modesto Court		
File No.(s):	A013/25		

### Proposed Variance(s):

- 1. To permit a maximum driveway width of **10.26 m** for a lot with a lot frontage greater than 12 m.
- 2. To permit a retaining wall (2 window wells) with a height of 1.13 m to be setback a minimum of **0.62 m** from the westerly lot line.
- 3. To permit a residential accessory structure (pool mechanical shed) with a height of **4.59 m**.
- 4. To permit an uncovered platform (raised terrace) with a height of **2.0 m** to encroach to a maximum of **5.28 m** into the minimum required rear yard of 7.5 m. A setback of **2.22 m** from the rear lot line is proposed.
- 5. To permit an outdoor swimming pool with a height of **2.0 m** to be setback **2.04 m** from the westerly interior side lot line.
- 6. To permit a retaining wall with a height of 1.1 m to be setback a minimum of **0.82 m** from the southwesterly interior side lot line.

### By-Law 001-2021 Requirement(s):

- 1. For a lot with a lot frontage greater than 12 m, a maximum driveway width of **9 m** is permitted.
- 2. A minimum setback of **1.13 m** is required from the westerly lot line to the retaining wall (window well).
- 3. A maximum height of **3.0 m** is permitted for a residential accessory structure.
- 4. An uncovered platform (raised terrace), with a floor height greater than **1.2 m** as measured above grade and including access stairs, is permitted to encroach to a maximum of **2.4 m** into the minimum required rear yard of 7.5 m [4.13] A setback of **5.1 m** from the rear lot line is required.
- 5. Where the height of an outdoor swimming pool is greater than 1.5 m, the minimum setback from any lot line shall be **3.0 m**.
- 6. A minimum setback of **1.1 m** is required from the southwesterly lot line to the retaining wall.

### **Official Plan:**

Vaughan Official Plan 2010 ('VOP 2010'): "Low Rise Residential"

#### Comments:

The Owner is seeking relief to permit a new single detached dwelling, as well as a swimming pool, pool equipment shed and raised terrace in the rear yard with the above noted variances.

The Development and Parks Planning Department has no objections to Variance 1 to increase the maximum permitted driveway width from 9 m to 10.26 m. The configuration of the proposed driveway is designed to serve a three (3)-car garage with multiple entry points. The proposed driveway is 10.26 m at its widest point to facilitate vehicular access. The driveway width is approximately 7.27 m when measured at the front lot line, which is smaller than the maximum permitted driveway width. The remainder of the front yard has adequate space for landscaping opportunities, and the proposed driveway width is not anticipated to impact the streetscape.

The Development and Parks Planning Department has no objections to Variance 2 to permit two window wells located within the west interior side yard with 0.62 m setbacks to the west lot line. The proposed window wells are located along the west wall of the proposed dwelling. The window wells are mostly located below grade, and will not create

Development and Parks Planning Department | City of Vaughan | 2141 Major Mackenzie Drive | Vaughan, ON L6A 1T1



any visual impacts on the neighbouring property. The proposed window wells comply with side yard encroachment provisions and are minor in nature.

The Development and Parks Planning Department has no objections to Variance 3 to permit a 4.59 m tall pool equipment shed in the rear yard. The shed abuts the raised terrace and the height is measured from established grade. The shed has a floor area of less than 10 m<sup>2</sup>, complies with setback provisions, and is not anticipated to incur massing concerns on the neighbouring residential properties.

The Development and Parks Planning Department has no objections to Variances 4, 5, and 6 to permit various setbacks to the raised terrace and the integrated swimming pool in the rear yard. The raised terrace is proposed to be located 2 m above the established grade. The raised terrace is surrounded by two (2) raised planters toward the rear lot line, which creates a step-down effect to mitigate massing impacts on the public open space abutting the rear of the property. The proposed setbacks of 2.22 m to the rear yard and 0.82 m to the west interior side yard are sufficient for access. The proposed swimming pool is in line with the raised terrace and is sufficiently setback from the west interior side lot line to accommodate access and maintenance.

Development Engineering staff have reviewed the proposed dwelling and rear yard and do not object to the raised terrace and associated retaining walls. Environmental Planning staff and TRCA staff have reviewed the application and are satisfied that the proposed structures and raised terrace are adequately setback from a nearby Provincially Significant Wetland and other core environmental features.

Accordingly, the Development and Parks Planning Department supports the requested variances and is of the opinion that the proposal is minor in nature, maintains the general intent and purpose of the Official Plan and Zoning By-law, and is desirable for the appropriate development of the land.

#### **Recommendation:**

The Development and Parks Planning Department recommends approval of the application.

#### Conditions of Approval:

If the Committee finds merit in the application, the following conditions of approval are recommended:

None.

#### **Comments Prepared by:**

Harry Zhao, Planner 1 Janany Nagulan, Senior Planner



February 18, 2025

PAR-DPP-2025-00572

### SENT BY E-MAIL: Christine.Vigneault@vaughan.ca

Christine Vigneault Secretary Treasurer Committee of Adjustment City of Vaughan 2141 Major Mackenzie Drive Vaughan, Ontario L6A 1T1

Dear Christine:

Re: Minor Variance Application A013/25 Block 48, Plan 65M4184 104 Sir Modesto Court City of Vaughan, Regional Municipality of York Applicant: Ori Smith

This letter acknowledges receipt of the above-noted application circulated by the City of Vaughan. The materials were received by Toronto and Region Conservation Authority (TRCA) on February 10, 2025. TRCA staff have reviewed the application and offer the following comments for the consideration of the Committee of Adjustment.

### **Purpose of the Application**

It is our understanding that the purpose of the above noted application is to request the following variances under By-Law 001-2021:

- To permit a maximum driveway width of 10.26 metres for a lot with a lot frontage greater than 12.0 metres;
- To permit a retaining wall (2 window well) with a height of 1.13 metres to be setback a minimum of 0.62 metres from the southeasterly lot line;
- To permit a residential accessory structure (pool mechanical) with a height of 4.59 metres;
- To permit an uncovered platform (paverstone terrace) with a height of 2.0 metres to encroach to a maximum of 5.28 metres into the minimum required rear yard of 7.5 metres. A setback of 2.22 m from the rear lot line is proposed;
- To permit an outdoor swimming pool with a height of 2.0 metres to be setback 2.04 metres from the easterly interior side lot line; and,
- To permit a retaining wall with a height of 1.1 metres to be setback a minimum of 0.82 metres from the northeasterly interior side lot line.

### Ontario Regulation 41/24

The subject property is located within TRCA's Regulated Area due to a valley corridor and Regional Storm flood plain associated with a tributary of the Don River Watershed. In accordance with Ontario Regulation 41/24, development, interference or alteration may be permitted in the Regulated Area where it can be demonstrated to TRCA's satisfaction that the control of flooding, erosion, dynamic beaches, unstable soils, or bedrock will not be affected.

### **Application-Specific Comments**

TRCA staff have reviewed and issued a permit for the proposed in-ground pool, retaining wall, hard landscaping, and associated grading (TRCA Permit No. PER-DPP-2024-00012, issued September 12, 2024). The plans submitted with this application are consistent with the plans that were approved as part of TRCA's permit.

Based on the above, TRCA staff have no concerns with the proposed variance.

#### **Fees**

By copy of this letter, the applicant is advised that the TRCA has implemented a fee schedule for our planning application review services. This application is subject to a \$660.00 (Minor Variance – Residential - Minor) review fee. The applicant is responsible for fee payment and should forward the application fee to this office as soon as possible.

#### **Recommendations**

Based on the comments noted above, TRCA has **no objection** to the approval of Minor Variance Application A013/25 subject to the following conditions:

1. That the applicant provides the required fee amount of \$660.00 payable to the Toronto and Region Conservation Authority.

We trust these comments are of assistance. Should you have any questions, please contact me at 437-880-1925 or at <u>cameron.mcdonald@trca.ca</u>.

Sincerely,

Cameron McDonald

Cameron McDonald Planner I Development Planning and Permits I Development and Engineering Services <u>cameron.mcdonald@trca.ca</u>, 437-880-1925

### SCHEDULE C: PUBLIC & APPLICANT CORRESPONDENCE

Correspondence Type	Name	Address	Date Received (mm/dd/yyyy)	Summary
None				

### SCHEDULE D: BACKGROUND

	Application Description (i.e. Minor Variance Application; Approved by COA / OLT)
N/A	N/A