REPORT SUMMARY MINOR VARIANCE APPLICATION FILE NUMBER A012/25

Report Date: March 14, 2025

THIS REPORT CONTAINS COMMENTS FROM THE FOLLOWING DEPARTMENTS & AGENCIES (SEE SCHEDULE B):

Additional comments from departments and agencies received after the publication of the report will be made available on the City's <u>website</u>.

Internal Departments *Comments Received	Condition	s Required	Nature of Comments
Committee of Adjustment	Yes 🗆	No 🖂	General Comments
Building Standards (Zoning)	Yes 🗆	No 🖂	General Comments
Development Planning	Yes 🗆	No 🖂	Recommend Approval/No Conditions
Development Engineering	Yes 🗆	No 🖂	General Comments
Forestry	Yes 🗆	No 🖂	General Comments
Development Finance	Yes 🗆	No 🖂	General Comments

External Agencies *Comments Received	Conditions I	Required	Nature of Comments *See Schedule B for full comments
Alectra	Yes 🗆	No 🖂	General Comments
Region of York	Yes 🗆	No 🖂	General Comments
TRCA	Yes 🗆	No 🖂	General Comments

PUBLIC & APPLICANT CORRESPONDENCE (SEE SCHEDULE C)

All personal information collected because of this public meeting (including both written and oral submissions) is collected under the authority of the Municipal Act, the Municipal Freedom of Information and Protection of Privacy Act (MFIPPA), the Planning Act and all other relevant legislation, and will be used to assist in deciding on this matter. All personal information (as defined by MFIPPA), including (but not limited to) names, addresses, opinions and comments collected will become property of the City of Vaughan, will be made available for public disclosure (including being posted on the internet) and will be used to assist the Committee of Adjustment and staff to process this application.

Correspondence Type	Name	Address	Date Received (mm/dd/yyyy)	Summary
N/A				

BACKGROUND (SCHEDULE D, IF REQUIRED)		
* Background Information contains historical	development approvals considered to be related to this file.	
This information should	d not be considered comprehensive.	
Application No. (City File)	ication No. (City File) Application Description	
	(i.e. Minor Variance Application; Approved by COA / OLT)	
N/A	N/A	

ADJOUR	NMENT HISTORY
* Previous hearing dates where this application	on was adjourned by the Committee and public notice issued.
Hearing Date	Reason for Adjournment (to be obtained from NOD_ADJ)
N/A	N/A

	SCHEDULES
Schedule A	Drawings & Plans Submitted with the Application
Schedule B	Comments from Agencies, Building Standards & Development Planning
Schedule C (if required)	Public & Applicant Correspondence
Schedule D (if required)	Background



MINOR VARIANCE APPLICATION FILE NUMBER A012/25

CITY WARD #:	1
APPLICANT:	Patrizia Tucci & John Pasquariello
AGENT:	Michael Persechini (Blue Grove Engineering Group)
PROPERTY:	50 Sierra Court, Maple ON
ZONING DESIGNATION:	See below.
VAUGHAN OFFICIAL PLAN (2010) DESIGNATION:	Vaughan Official Plan 2010 ('VOP 2010'): "Low Rise Residential"
RELATED DEVELOPMENT	N/A
APPLICATIONS:	
PURPOSE OF APPLICATION:	Relief from the Zoning By-law is being requested to permit a residential
	accessory structure (pool house) in the rear yard.

The following variances have been requested from the City's Zoning By-law:

The subject lands are zoned R2A (EN), Second Density Residential, Established Neighbourhoods Zone and subject to the provisions of Exception 14.523 under Zoning By-law 001-2021, as amended.

#	Zoning By-law 001-2021	Variance requested
1	A residential accessory structure with a height	To permit a residential accessory structure with a
	greater than 2.8 m shall not be located closer	height greater than 2.8 m to be located no closer
	than 2.4 m to any lot line. [4.1.2]	than 2.17 m to a lot line (south).
2	The maximum height of a residential	To permit a maximum height of 3.1 m. for a
	accessory structure shall be 3.0 m. [4.1.4]	residential accessory structure.

HEARING INFORMATION

DATE OF MEETING: Thursday, March 20, 2025

TIME: 6:00 p.m.

MEETING LOCATION: Vaughan City Hall, Woodbridge Room (2nd Floor), 2141 Major Mackenzie Drive LIVE STREAM LINK: <u>Vaughan.ca/LiveCouncil</u>

PUBLIC PARTICIPATION

If you would like to speak to the Committee of Adjustment at the meeting, either remotely or in person, please complete the **Request to Speak Form** and submit to **cofa@vaughan.ca**

If you would like to submit written comments, please quote file number above and submit by mail or email to:

Email: <u>cofa@vaughan.ca</u>

Mail: City of Vaughan, Office of the City Clerk, Committee of Adjustment, 2141 Major Mackenzie Drive, Vaughan, ON, L6A 1T1

To speak electronically, pre-registration is required by completing the <u>Request to Speak Form</u> on-line and submitting it to <u>cofa@vaughan.ca</u> no later than NOON on the last business day before the meeting.

THE DEADLINE TO REGISTER TO SPEAK ELECTRONICALLY OR SUBMIT WRITTEN COMMENTS ON THE ABOVE NOTED FILE(S) IS <u>NOON</u> ON THE LAST BUSINESS DAY BEFORE THE MEETING.

INTRODUCTION

Staff and Agencies act as advisory bodies to the Committee of Adjustment. The comments contained in this report are presented as recommendations to the Committee.

INTRODUCTION

Section 45(1) of the Planning Act sets the criteria for authorizing minor variances to the City of Vaughan's Zoning By-law. Accordingly, review of the application may consider the following:

That the general intent and purpose of the by-law will be maintained.

That the general intent and purpose of the official plan will be maintained.

That the requested variance(s) is/are acceptable for the appropriate development of the subject lands. That the requested variance(s) is/are minor in nature.

Public written and oral submissions relating to this application are taken into consideration by the Committee of Adjustment as part of its deliberations and final decision on this matter.

СОММІТІ	EE OF ADJUSTMENT
Date Public Notice Mailed:	March 6, 2025
Date Applicant Confirmed Posting of Sign:	March 2, 2025
Applicant Justification for Variances: *As provided in Application Form	Already built - applying after initial permit wasn't followed
Was a Zoning Review Waiver (ZRW) Form submitted by Applicant: *ZRW Form may be used by applicant in instances where a revised submission is made, and zoning staff do not have an opportunity to review and confirm variances prior to the issuance of public notice.	Yes □ No ⊠
COMMENTS:	
N/A Committee of Adjustment Recommended	None
Conditions of Approval:	
BUILDING	STANDARDS (ZONING)
**See Schedule B for Building Standards (Zo	
Building Standards Recommended Conditions of Approval:	None
	OPMENT PLANNING
**See Schedule B for Development Planning	
Development Planning Recommended Conditions of Approval:	TBD
DEVELO	
	rmit Link to Curb Curt Permit Link Culvert Installation
Development Engineering has already issue	
Development Engineering Recommended Conditions of Approval:	None
· · · · · · · · · · · · · · · · · · ·	RY & HORTICULTURE (PFH)
Forestry has no comment at this time.	N
PFH Recommended Conditions of Approval:	None
DEVEL	
No comment no concerns.	
Development Finance Recommended	None
Conditions of Approval:	
BY-LAW AND COMPLIANC	E, LICENSING AND PERMIT SERVICES
No comments received to date.	,
BCLPS Recommended Conditions of Approval:	None

BUILDING	INSPECTION (SEPTIC)
No comments received to date.	
Building Inspection Recommended	None
Conditions of Approval:	
FIR	E DEPARTMENT
No comments received to date.	
Fire Department Recommended	None
Conditions of Approval:	

RECOMMENDED CONDITIONS OF APPROVAL SUMMARY

Should the Committee find it appropriate to approve this application in accordance with request and the sketch submitted with the application, as required by Ontario Regulation 200/96, the following conditions have been recommended:

#	DEPARTMENT / AGENCY	CONDITION
	None	

All conditions of approval, unless otherwise stated, are considered to be incorporated into the approval "if required". If a condition is no longer required after an approval is final and binding, the condition may be waived by the respective department or agency requesting conditional approval. A condition cannot be waived without written consent from the respective department or agency.

IMPORTANT INFORMATION

CONDITIONS: It is the responsibility of the owner/applicant and/or authorized agent to obtain and provide a clearance letter from respective department and/or agency (see condition chart above for contact). This letter must be provided to the Secretary-Treasurer to be finalized. All conditions must be cleared prior to the issuance of a Building Permit.

APPROVALS: Making any changes to your proposal after a decision has been made may impact the validity of the Committee's decision.

An approval obtained from the Committee of Adjustment, where applicable, is tied to the building envelope shown on the plans and drawings submitted with the application and subject to the variance approval.

A building envelope is defined by the setbacks of the buildings and/or structures shown on the plans and drawings submitted with the application, as required by Ontario Regulation 200/96. Future development outside of an approved building envelope, where a minor variance was obtained, must comply with the provisions of the City's Zoning By-law.

Elevation drawings are provided to reflect the style of roof (i.e. flat, mansard, gable etc.) to which a building height variance has been applied. Where a height variance is approved, building height is applied to the style of roof (as defined in the City's Zoning By-law) shown on the elevation plans submitted with the application.

Architectural design features that are not regulated by the City's Zoning By-law are not to be considered part of an approval unless specified in the Committee's decision.

DEVELOPMENT CHARGES: That the payment of the Regional Development Charge, if required, is payable to the City of Vaughan before issuance of a building permit in accordance with the Development Charges Act and the Regional Development Charges By-law in effect at the time of payment.

That the payment of the City Development Charge, if required, is payable to the City of Vaughan before issuance of a building permit in accordance with the Development Charges Act and the City's Development Charges By-law in effect at the time of payment.


That the payment of the Education Development Charge if required, is payable to the City of Vaughan before issuance of a building permit in accordance with the Development Charges Act and the Boards of Education By-laws in effect at the time of payment

That the payment of Special Area Development charge, if required, is payable to the City of Vaughan before issuance of a building permit in accordance with the Development Charges Act and The City's Development Charge By-law in effect at the time of Building permit issuance to the satisfaction of the Reserves/Capital Department.

NOTICE OF DECISION: If you wish to be notified of the decision in respect to this application or a related Ontario Land Tribunal (OLT) hearing you must complete a Request for Decision form and submit to the Secretary Treasurer (ask staff for details). In the absence of a written request to be notified of the Committee's decision you will not receive notice.

SCHEDULE A: DRAWINGS & PLANS

VAUGHAN Minor Variance Application - A012/25

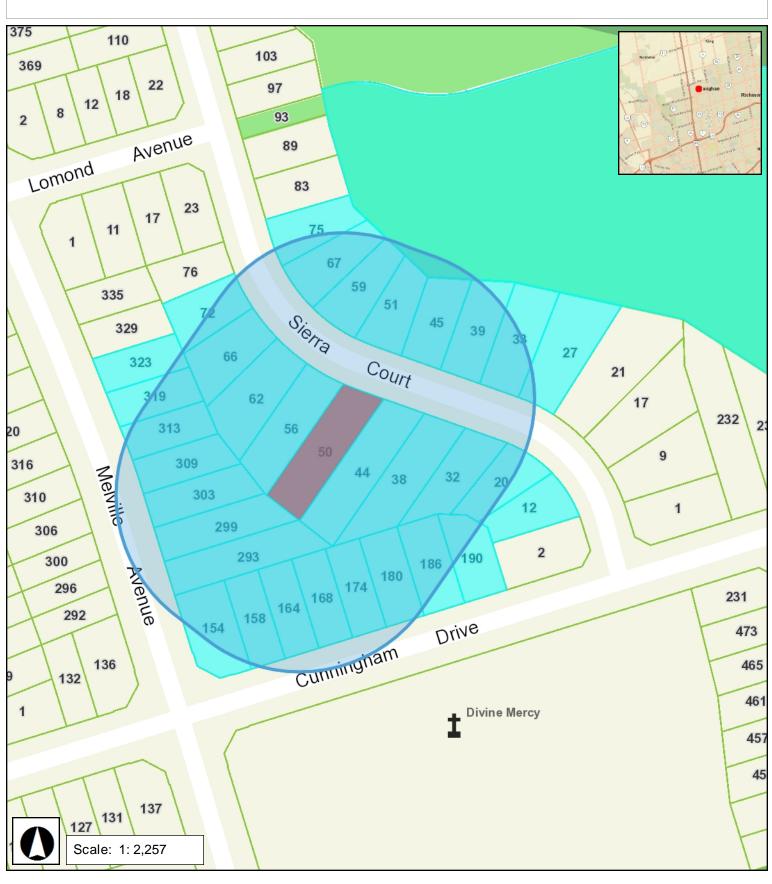



SCALE: 1/8" = 1'-0" The Contractor shall check all dimensions and other data from the job and report any discrepancies to the Architects before proceeding.

ON SQUARIELLO

JOHN PA

PREPARED FOR:

www.bluegroveengineering.com

info@bluegroveeng.com

E-Mail: int Web Site:

> Toronto, Ontario. M6M 3E5

Tel: (416) 540-0756

 \vdash

SHEFFIELD STREE

SHEET TITLE: SITE PLAN

SHEET NO.


50 SIERRA COURT MAPLE, ON

PROJECT TITLE:

ERING GROUP INC.


ENGINE

GROVE

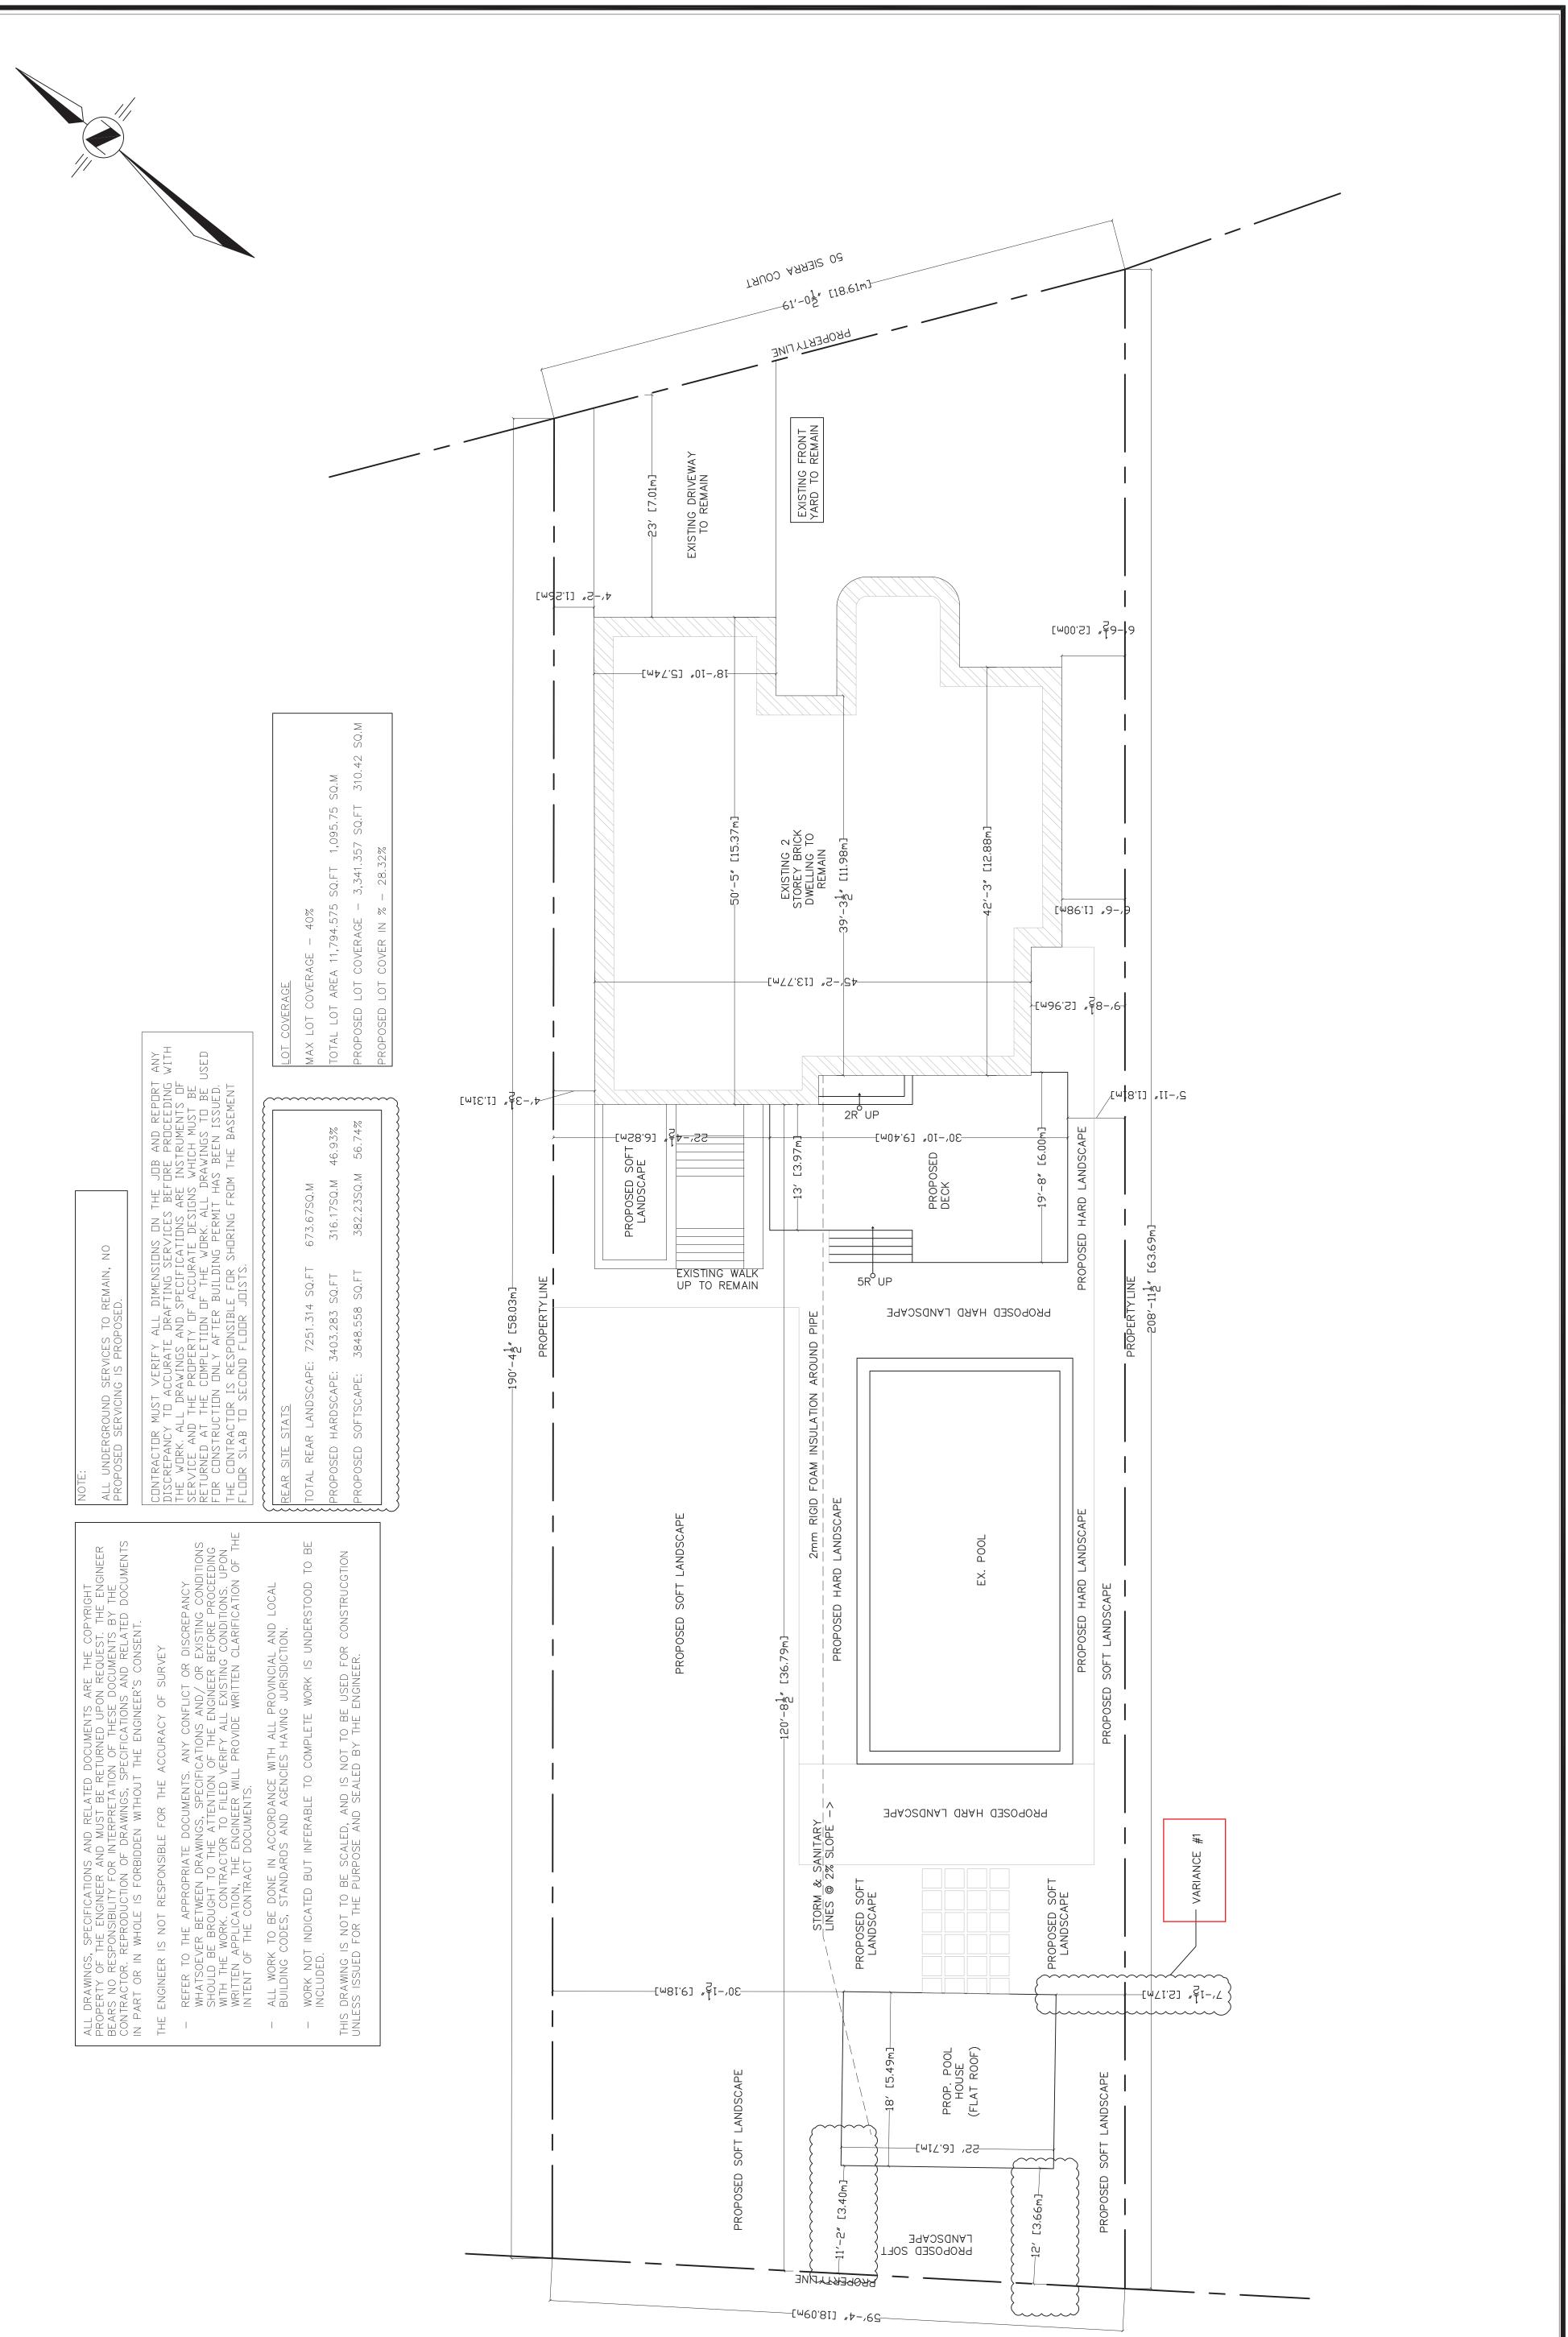


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	JAN 29–25 IS: JAN 29–25 IS: JAN 8–25 IS: NOV 26–24 RE SEP 11–24 RE SEP 5–24 IS DATE

SURVEYOR'S REAL PROPERTY REPORT PART 1) PLAN SHOWING PART OF LOT 49 REGISTERED PLAN 65M-3106 CITY OF VAUGHAN REGIONAL MUNICIPALITY OF YORK SCALE 1:400 3m4m5m10m 20m OPHIR N. DZALDOV SURVEYORS LTD.

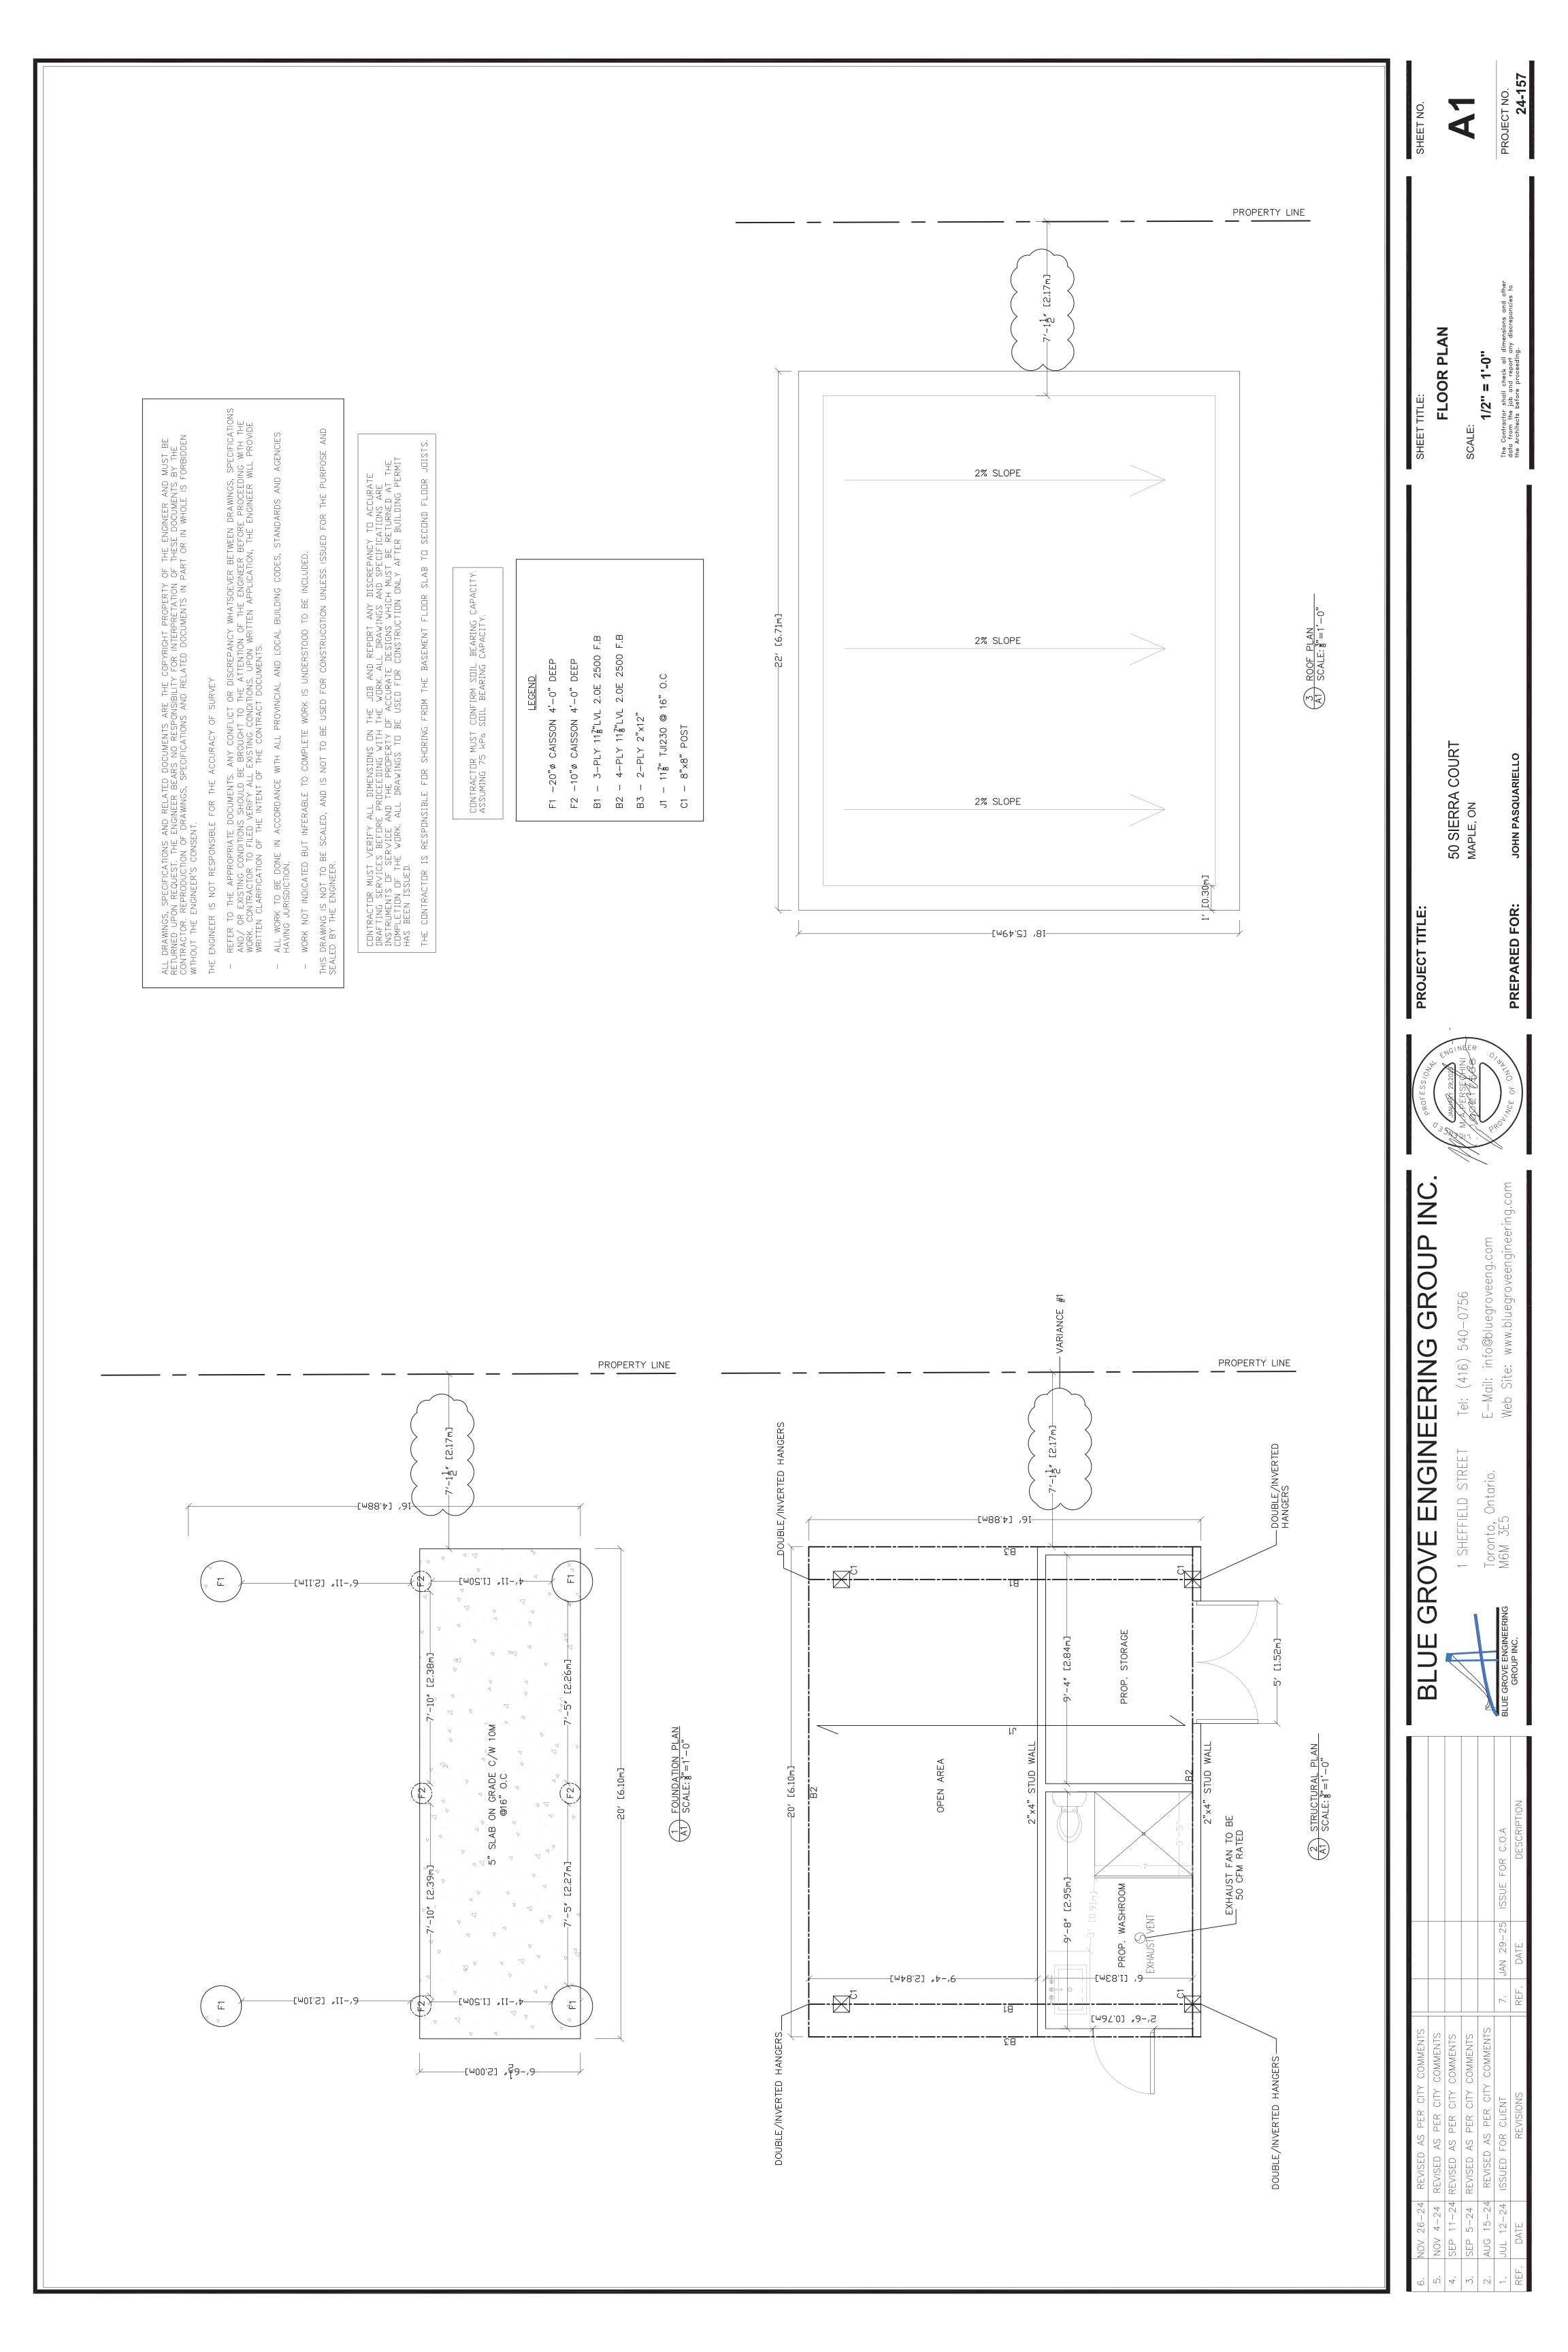

A2 SHEET NO. GRADE GRADF JDISTS, CONTRACTOR MUST VERIFY ALL DIMENSIONS ON THE JOB AND REPORT ANY DISCREPANCY TO ACCURATE DRAFTING SERVICES BEFORE PROCEEDING WITH THE WORK, ALL DRAWINGS AND SPECIFICATIONS ARE INSTRUMENTS OF SERVICE AND THE PROPERTY OF ACCURATE DESIGNS WHICH MUST BE RETURNED AT THE COMPLETION OF THE WORK, ALL DRAWINGS TO BE USED FOR CONSTRUCTION ONLY AFTER BUILDING PERMIT HAS BEEN ISSUED. ESTABLISHED SHFD SECOND FLOOR ELEVATION AVERAGE AVERAGE PROPOSED = 1'-0" SLAB 3/8" SHEET TITLE: BASEMENT FLOOR SCALE: ЦНЕ SHORING FROM BEARING CAPACITY CAPACITY. 2_% [0']3^w]-SOUTH ELEVATION SCALE $\frac{1}{2}$ = 1'-0" $\begin{array}{c|c} 4 \\ \hline A2 \\ \hline SCALE \\ \frac{1}{2} \\ m = 1' - 0'' \\ \end{array}$ N 9 8 M 4 -4, []'SSw]-L L L RESPONSIBLE 4. 6 4 CONFIRM SOIL SOIL BEARING P A2 -4, []'SSW]-50 SIERRA COURT MAPLE, ON I CONTRACTOR MUST ASSUMING 75 kPa THE CONTRACTOR

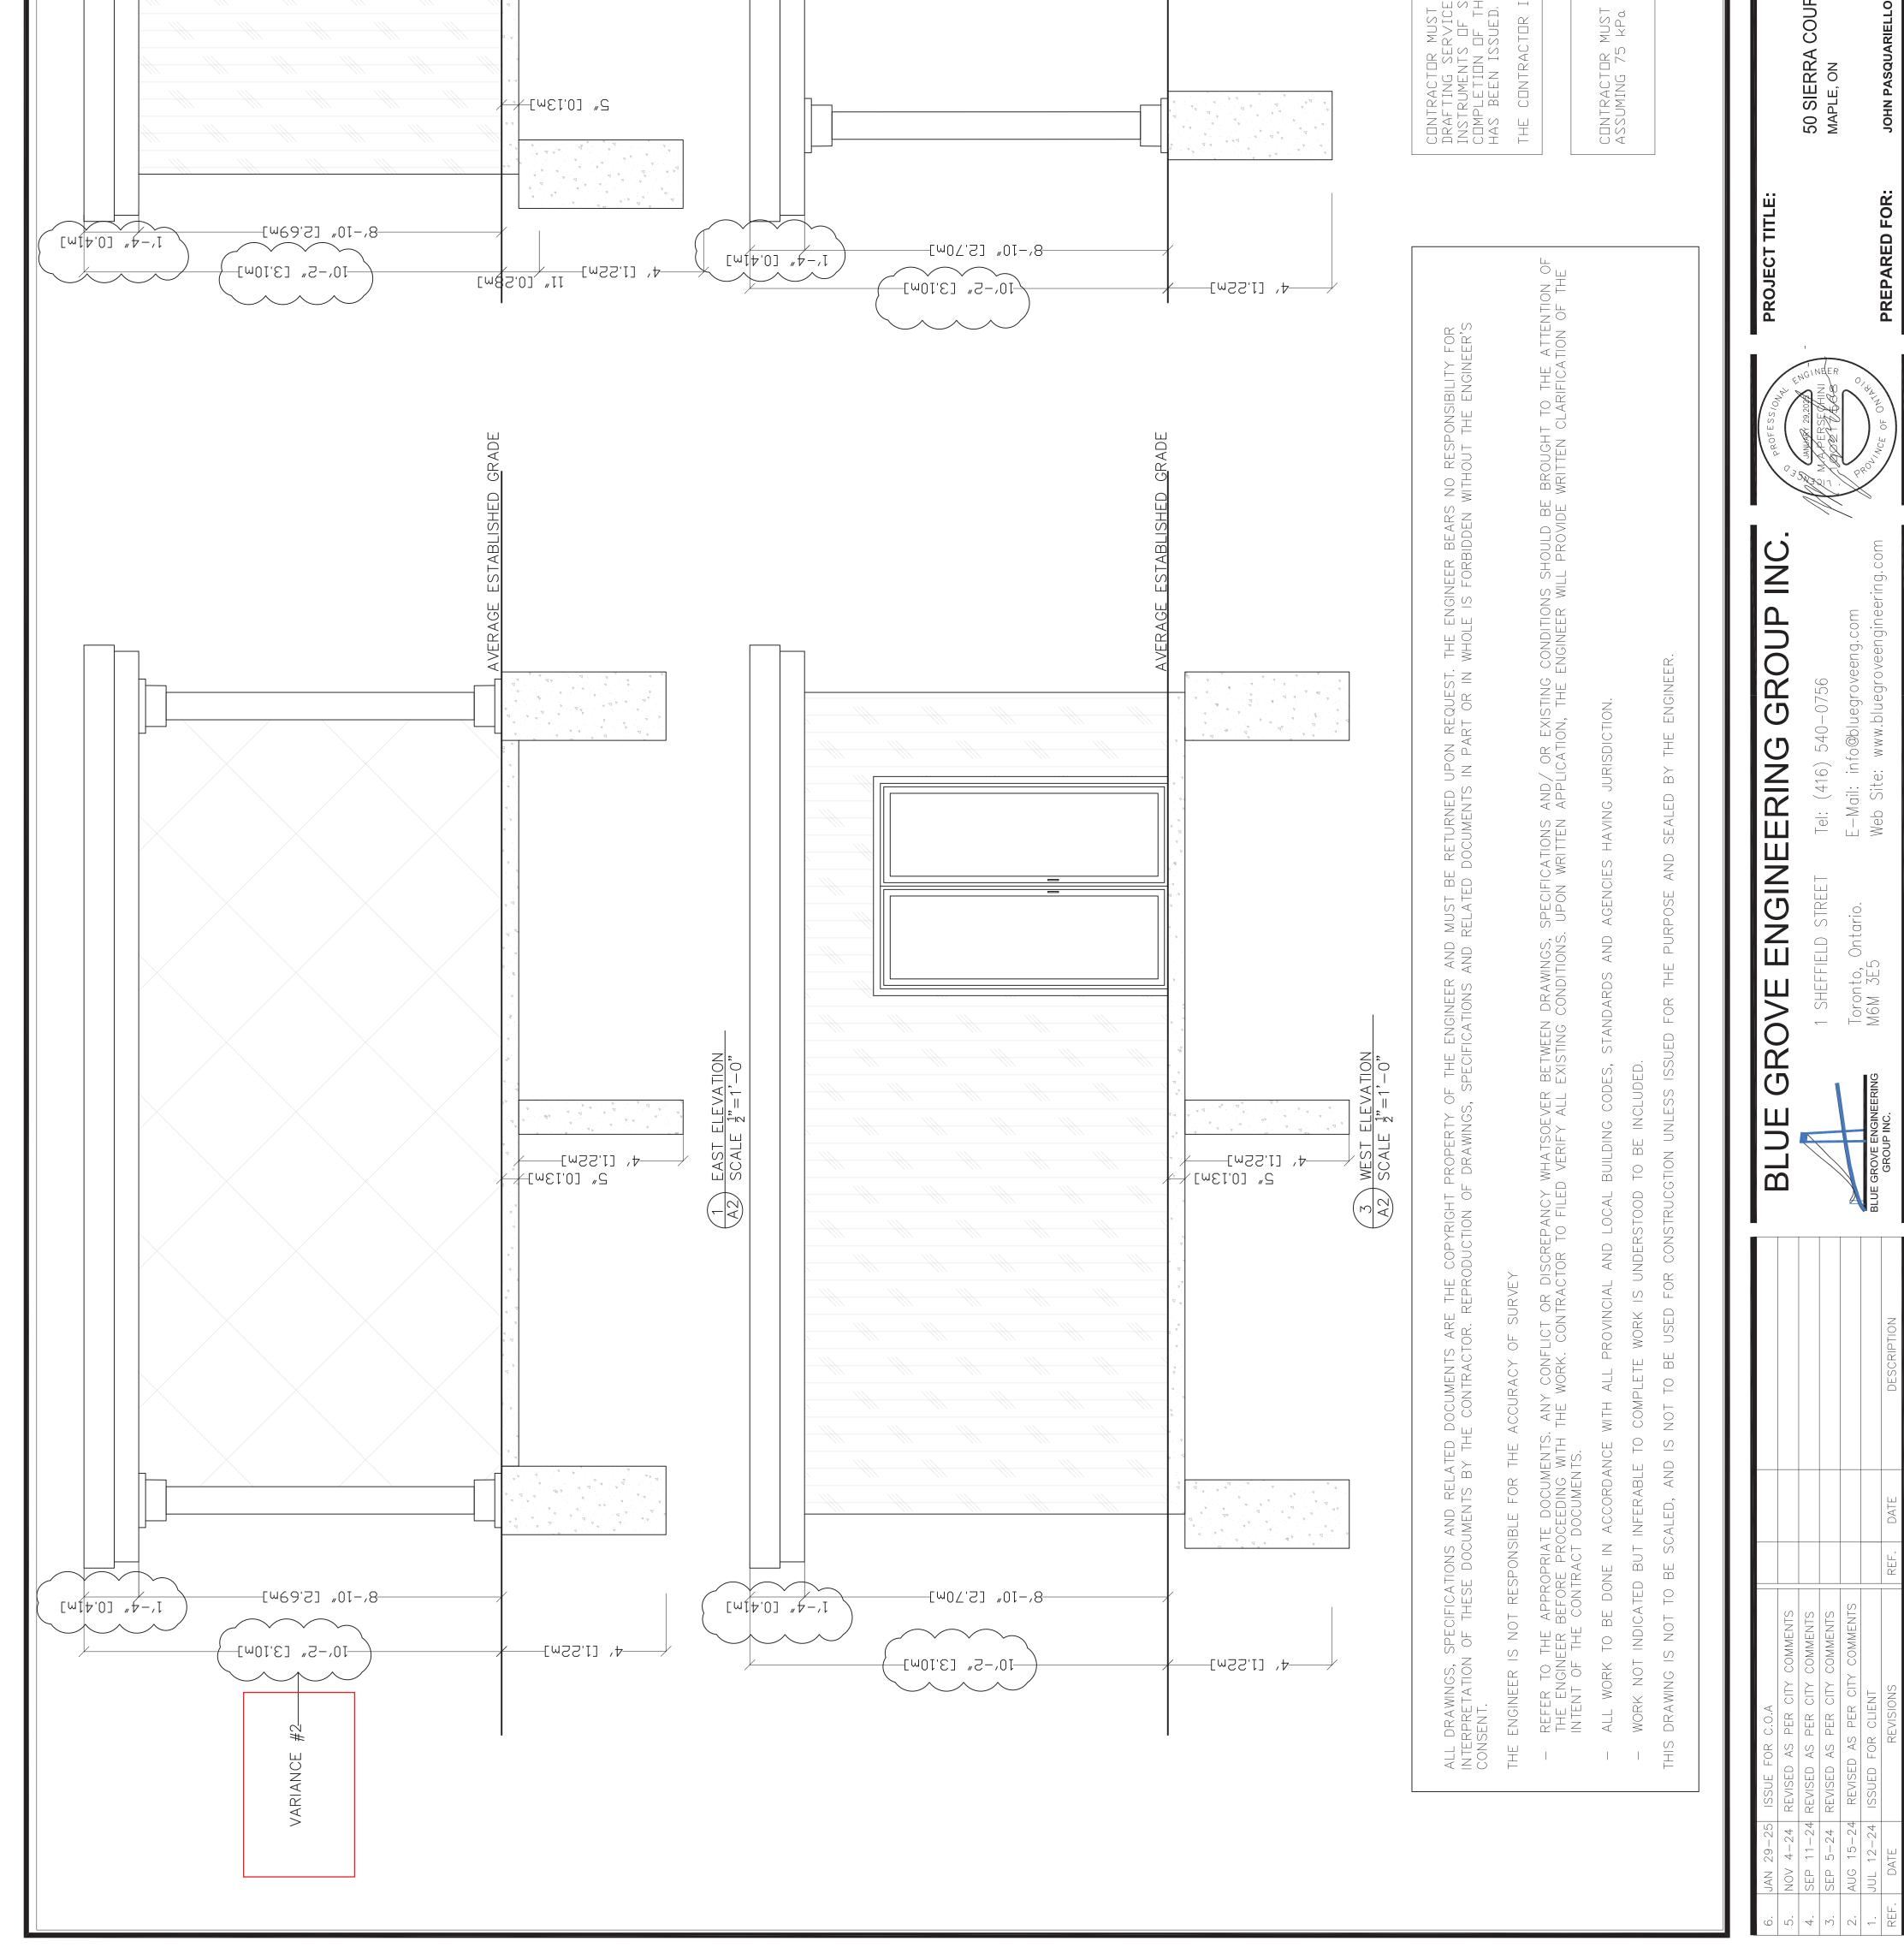

PROJECT NO. 24-157

The Contractor shall check all data from the job and report the Architects before proceedir

PROJECT NO.	24-157

GN1 SHEET NO.

> and other ancies to dimensions any discrepo ng. The Contractor shall check all data from the job and report the Architects before proceedin N.T.S SCALE:

> > SQUARIELLO

RRA COURT NO

GENERAL NOTES SHEET TITLE:

32 23" (550mm x 584mm) ACCESS THER STRIPPING

MECHANICALLY VENTED TO LEAST 2 AIR CHANGES PER M TAPE

XTERIOR Ш

) DEEP

S FIREPLACE INSTALLED AS PER CIFICATIONS. DIRECT VENT MIN GRADE. DIRECT VENT TO MEET HAVING JURISDICTION

10.19. PROVIDE 1 PER FLOOR M CONNECTING FLOOR LEVELS OM. ALARMS TO BE CONNECTED ONNECTED SO ALL ARMS SOUND

ARM (CMA)).33.4. WHERE THERE IS FUEL A CMA SHALL BE PROVIDED EEPING AREA. CMA TO BE WIRED HE SMOKE ALARM WILL SOUND

W/ SELF CLOSER, WEATHER AND DEADBOLT

DR WOOD STEP TTED TO BE LAID ON GROUND. SED TO WEATHER. m), MIN.TREAD: 9 1/4" (235mm)

ERIOR)

7 " (180mm) 10" (255mm) 11" (285mm) 11" (285mm) 6'-5" (1950mm) 6'-5" (1950mm) 2'-10" (860mm)

5 7/8" (150mm) 7 7/8" (200mm)

10" (250mm) 8" (200mm)

JIRED FOR 3 OR MORE RISERS. (1220mm)

RAILINGS / GUARDS AS PER OBC 9.8.7 & 9.8.8: MAX SPACING B/W WOOD PICKETS: INTERIOR LANDING: INTERIOR STAIR: EXTERIOR LANDING: (GREATER THAN 2'-0" (610mm) ABOVE GRADE

4" (100mm) 2'-11" (900mm) 2'-7" (800mm)

2'-11" (1070mm)

3'-6" (1070mm) EXTERIOR LANDING; (GREATER THAN 5'-11" (1800mm) ABOVE GRADE

2'-11" (900mm)

EXTERIOR STAIR:

BEAM POCKETS PILASTERS PILASTERS 8"x8" (200mm x 200mm) POURED CONCRETE PIER 33

BEAM POCKETS 4" (100mm) RECESSED INTO FOUNDATION WALL. WIDTH TO MATCH BEAM SIZE W/ 1/2" (12.7mm) SPACE AROUND WOOD BEAMS

WOOD STRAPPING (STEEL BEAM) 1"x4" (19mm x 38mm) WOOD STRAPPING ON BOTH SIDES OF STEEL BEAM 34

35

2 STOREY - DOUBLE VOLUME FOR A MAXIMUM OF 18-0" (5490mm) HEIGHT, PROVIDE 2-2"x6" (2-38mm x 140mm) CONTINUOUS STUDS @ 12" (300mm) O.C. FOR MASONRY, 16" (400mm) O.C. FOR SIDING. PROVIDE SOLID WOOD BLOCKING BETWEEN STUDS @ 4'-0" (1220mm) O.C.

JURISDICTION AUTHORITIES HAVE AND ALL NTARIO BUILDING CODE

GARAGE SLAB 4" (100mm) 4650psi (32mpa) CONCRETE SLAB ON 4" (100mm) COURSE GRANULAR FILL W/ 5-8% AIR ENTERTAINMENT. 6"x6" (W2.9 X 2.9) WIRE MESH LOCATED NEAR MID DEPTH OF SLAB

STEEL PIPE COLUMNS TO CONFORM WITH OBC 9.17.3. 3 1/2" (89mm) DIA. X 0.188 (4.76mm) NON-ADJUSTABLE STEEL COLUMN W/ 6"x6"x 3/8" (150mm x 150mm x 9.5mm) STEEL TOP PLATE AND 4 1/2"x10"x1/2" (120mm x 250mm x 12.5mm) STEEL BOTTOM PLATE. WELD COLUMN TO BASE PLATES

EXTERIOR GARAGE WALL AS PER NOTE 11, 12 OR 13 EXCEPT W/O THERMAL INSULATION, AIR / VAPOUR BARRIER AT EXTERIOR WALLS AND W/ MOISTURE RESISTANT GYPSUM WALL BOARD THROUGHOUT

EXTERIOR SIDING WALL SIDING (HORIZONTAL, VERTICAL, HARDIE BOARD, SHAKE, BOARD & BATTEN OR SCALLOP) AS PER ELEVATION. MIN. 6" (150mm) ABOVE GRADE. 6" (150mm) BASE FLASHING UP BEHIND WALL SHEATHING. CONT. AIR BARRIER ON 1/2" EXTERIOR PLYWOOD OR EQUIVALENT, 2"x6" (38mm x 140mm) WOOD STUDS @ 16" O.C. W/ MIN. R24 (4.23RSI) INSULATION, 6 MIL VAPOUR BARRIER, 1/2" (12.7mm) GYPSUM WALL BOARD

EXTERIOR STUCCO WALL EIFS (EXTERIOR INSULATION AND FINISH SYSTEMS) CONFORMING TO OBC 9.28 AND MANUFACTURER SPECIFICATIONS. RIGID INSULATION ON 1/2" (12.7mm) EXTERIOR TYPE SHEATHING, 2"x6" (38mm x 140mm) WOOD STUDS @ 16" O.C. W/ MIN. R24 (4.23RSI) INSULATION, 6 MIL VAPOUR BARRIER, 1/2" (12.7mm) GYPSUM WALL BOARD

EXTERIOR BRICK / STONE VENEER WALL 3 1/2" (90mm) FACE BRICK OR 4" (100mm) STONE W/ 1"x7"x22 ga. CORROSION RESISTANT METAL TIES @ 16" 0.C. HORIZONTAL AND 24" VERTICAL W/ 1" AIR SPACE. PROVIDE WEEP HOLES @ 30" O.C. AND PROVIDE BASE FLASHING MIN. 6" (150mm) UP BEHIND BUILDING PAPER. TYVEK HOUSE WRAP ON 1/2" (12.7mm) EXTERIOR TYPE SHEATHING, 2"x6" (38mm x 140mm) WOOD STUDS @ 16" O.C. W/ MIN. R24 (4.23RSI) INSULATION, 6 MIL VAPOUR / AIR BARRIER CONTINUOUSLY OVER INSIDE OF EXTERIOR WALL STUDS, UNDER SILL PLATES, OVER TOP PLATES, OVER FACE OR JOIST HEADERS FOR FULL HEIGHT OF EXTERIOR WALLS AND ACROSS UNDERSIDE OF ROOF TIE JOISTS. 1/2" (12.7mm) GYPSUM WALL BOARD

0.C. 1/2" 16" (V mm) @ 1 PLATE INTERIOR STUD PARTITION 2"x4" (38mm x 89mm) OR 2"x6" (38mm x 140r DOUBLE TOP PLATE & SINGLE BOTTOM GYPSUM WALL BOARD ON EACH SIDE

INTERIOR LOAD BEARING STUD PARTITION 2"x4" (38mm x 89mm) OR 2"x6" (38mm x 140mm) @ 16" O.C. DOUBLE TOP PLATE & SINGLE BOTTOM PLATE ON DAMP PROOFING MATERIAL W/ 1/2" ANCHOR BOLTS, 8" LONG, EMBEDDED 4" (89mm) @ 8'-0" (2400mm) O.C. PROVIDE MID-BLOCKING IF UNFINISHED. FOOTINGS AS PER CONSTRUCTION NOTE 1 "STRIP FOOTINGS" W/ 4" CONCRETE CURB

16

INTERIOR GARAGE WALL 1/2" (12.7mm) GYPSUM BOARD ON BOTH SIDES OF WALL & U/S OF CEILING BETWEEN HOUSE AND GARAGE. ALL JOINTS TO BE TAPED AND SEALED AND MADE GAS PROOF. 2"x6" (38mm × 140mm) WOOD STUDS @ 16" O.C. W/R22 (RSI 3.87) BATT INSULATION, 6 MIL CONTINUOUS VAPOUR BARRIER IN CONFORMANCE W/ OBC 9.25.3 AND 9.24.4 FOR FLOOR ABOVE

17

GARAGE CEILING R31 (RSI 5.46) BATT INSULATION OR SPRAY FOAM INSULATION , IN GARAGE CEILING W/ FLOOR ABOVE. AND W/ 1/2" (12.7mm) GYPSUM WALL BOARD. ENTIRE ASSEMBLY MUST BE SEALED, TAPED AND GAS TIGHT PROOFED

18

TYPICAL FLOOR ASSEMBLY FLOOR FINISH ON 5/8" TONGUE AND GROOVE PLYWOOD SHEATHING SUB FLOOR, GLUED AND SCREWED W/ SANDED JOINTS. FLOOR JOISTS OR ENGINEERING JOISTS AS PER MANUFACTURERS SPECIFICATIONS, 1/2" GYPSUM WALL BOARD (FOR CEILING TYPE) EXCEPT OVER UNFINISHED BASEMENT

CROSS BRIDGING AND STRAPPING CROSS BRIDGING: 1"x3" (19mm x 64mm) CROSS BRIDGING @ MAX 6'-11" (2100mm) O.C. STRAPPING: 1"x3" (19mm x 64mm) NAILED TO U/S OF JOISTS MAX 6'-11" (2100mm) O.C.FASTED TO SILL OR HEADER ENDS

19

TYPICAL ROOF CONSTRUCTION FOR ROOFS MORE THAN 4 IN 12 SLOPE. NO. 210 SELF SEALED ASPHALT SHINGLES (PROVIDE REVERSE SHINGLES AS STARTING TIP). NO. 15 ASPHALT BUILDING PAPER @ PERIMETER 6" UP FROM EDGE (OVERLAP LAYERS TO SHED WATER) ON 1/2" (12.7mm) PLYWOOD SHEATHING WITH "H' CLIPS ON WOOD RAFTERS @ 16" O.C. OR APPROVED WOOD TRUSSES @ 24". TRUSS BRACING AS PER TRUSS MANUFACTURER. APPROVED EAVES PROTECTION STARTING AT FASCIA AND TO EXTEND MIN. 36" BEYOND INSIDE FACE OF EXTERIOR WALL. R60 LOOSE FILL INSULATION W/ 6 MIL VAPOUR BARRIER AND 1/2" (12.7mm) GYPSUM WALL BOARD (FOR WALL. R60 LOOSE FILL INSULATION W/ 6 MIL VAPOUR BARRIER AND 1/2" (12.7mm) GYPSUM WALL BOARD (FOR CEILING TYPE). METAL EAVESTROUGH ON ALUMINUM FASCIA AND VENTED SOFFIT ATTIC VENTILATION 1:300 OF THE INSULATED CEILING AREA W/ 50% AT EAVES

CEILING R60 (RSI 10.56) INSULATION W/ 6 MIL POLY AIR / VAPOUR BARRIER AND 5/8" (15.8mm) OR 1/2" (12.7mm) GYPSUM WALL BOARD

20

CONVENTIONAL ROOF FRAMING 2"x4" (38mm x 89mm) OR 2"x6" (38mm x 140mm) RAFTERS @ 16" (400mm) O.C. 2"x4" (38mm x 89mm) COLLAR TIES AT MID SPANS. CEILING JOISTS TO BE 2"x4" (38mm x 89mm) OR 2"x6" (38mm x 140mm) @ 16" (400mm) O.C. HIP & VALLEY RAFTERS TO BE MIN. 2" (50mm) LARGER THAN COMMON RAFTERS AND MIN. 1 1/2" (38mm) THICK

51

VAULTED OR CATHEDRAL CEILING APPROVED SCISSOR TRUSSES OR WOOD RAFTERS @ 16" O.C. W/ R31 (RSI 10.56) INSULATION, 6 MIL POLY AIR / VAPOUR BARRIER AND 1/2" (12.7mm) GYPSUM WALL BOARD

ATTIC ACCESS HATCH INSULATED R60 21 ½" X HATCH COVERED W/ WEA	EXHAUST FAN EXHAUST FAN TO BE EXTERIOR. PROVIDE AT HOUR. SEAL W/ ALUMINUN	CAPPED VENT EXTERIOR CAPPED DRYER VENT TO	LINEN CLOSET 4 SHELVES MIN. 16" (400m	GAS FIREPLACE ZERO CLEARANCE GAS F MANUFACTURERS SPECIF 12" (300mm) ABOVE FIN. G OBC AND AUTHORITIES HA	SMOKE ALARM (SA) TO CONFORM WITH 9.10 NEAR THE STAIRS FROM AND 1 IN EACH BEDROOM IN CIRCUIT AND INTERCON WHEN ONE SOUNDS	CARBON MONOXIDE ALAR TO CONFORM WITH 9.3 BURNING APPLIANCE, A ADJACENT TO EACH SLEE SO WHEN ACTIVATED, THE	GARAGE MAN DOOR TO BE GAS PROOFED STRIPPING, THRESHOLD A	PRECAST CONC. STEP OR 2 RISERS MAX PERMITTE WOOD STEP NOT EXPOSE MAX RISER: 7 7/8" (200mm)	STAIRS (EXTERIOR & INTE AS PER OBC 9.8: MAX RISER: MIN. RUN: MIN. RUN: MIN. TREAD: MIN. HEADROOM: MIN. HEADROOM: MIN WIDTH:	CURVED STAIRS: MIN. RUN: MIN AVG. RUN:	EXTERIOR CONC. STEPS: RISE: RUN:	FOUNDATION WALL REQU FOOTING TO BE MIN. 4'-0" (
22	23	24	25	50	27	28	29	30	31			

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TREE Ontario. Ś Toronto, (M6M 3E5 SHEI RING

www.bluegroveengineering.com info@bluegroveeng.com -0756 540-1 (416)Site: E-Mail: Web Sit€ ... U



TITLE PROJECT 50 SIEF MAPLE, (JOHN PA

PREPARED FOR:

2 ONTAF		6		11		13	46	15			
WITH THE 201	ONTINUOUS KEY. MIN. 28 DAYS SHALL REST K OR COMPACTED i (150kpa) PROVIDE XTEND 4'-0" (1200mm)	" (600mm) 600mm)	OBC 9.14.3. 4" (100mm) DISTURBED OR WELL OR PIPE TO BE BELOW O BE COVERED W/ 6" OR OTHER COURSE L DRAIN TO A SEWER,	POURED CONCRETE CTION LAYER ON PROOFING. FINISHED OR DAMP PROOFING OR DAMP PROOFING OR LEVEL AND SHALL WHERE HYDROSTATIC ON WALL SHALL BE 3.3.3. INSULATE W/ R20 ISIDE OF WALL AND ISIDE OF WALL AND EPTIBLE SOIL. WALL BOVE FIN. GRADE	W/ 1/2" DIA. ANCHOR LETE @ 7'-10" O.C. SILL D ON A FOAM GASKET	00psi (25mpa) CONCRETE SLAB W/ 6 MIL. DN 5" CRUSHED STONE. SLAB TO BE TH 6"x6" MESH LOCATED NEAR MID 3. PERIMETER OF SLAB AND ANY 0F THE SLAB TO BE SEALED AGAINST 6E W/ FLEXIBLE SEALANT CONFORMING 7. WHERE SLAB IS REQUIRED TO BE 1T SHALL BE CONFORM TO OBC. 9.13.7	ete slab W/ 5-8% air X 2.9) wire mesh .ab. any fill placed .se clean granular	R 3. 6" (150mm) 4650psi AIR ENTERTAINMENT O.C. W/ 15M DOWELS 0.C. W/ 15M DOWELS 4" (600mm). EXPOSED EFFECTIVELY SHED R WALL			
CONSTRUCTION NOTE ALL CONSTRUCTION PRACTICES TO COMPLY	STRIP FOOTINGS 20" X 8" CONCRETE FOOTING W/ CONTINUOUS KEY. MIN. 2200psi (15mpa) CONCRETE AFTER 28 DAYS SHALL REST ON UNDISTURBED SOIL, ROCK OR COMPACTED GRANULAR FILL W/ MIN. 21.76psi (150kpa). PROVIDE 2-15M CONTINUOUS AND TO EXTEND 4'-0" (1200mm) BELOW FINISHED GRADE	ED FOOTINGS DNTAL STEP (RUN) TO BE 24" (600mm) CAL STEP (RISE) TO BE 24" (600mm)	WEEPING TILE MATERIALS SHALL CONFORM TO OBC 9.14.3. 4" (100mm) MATERIALS SHALL CONFORM TO OBC 9.14.3. 4" (100mm) DIA. WEEPING TILE LAID ON UNDISTURBED OR WELL COMPACTED SOIL. TOP OF TILE OR PIPE TO BE BELOW BOTTOM OF FLOOR SLAB AND TO BE COVERED W/ 6" (150mm) OF CRUSHED STONE OR OTHER COURSE GRANULAR MATERIAL. TILE SHALL DRAIN TO A SEWER, DRAINAGE DITCH, OR DRY WELL	FOUNDATION WALL 10" (250mm) 3600psi (25mpa) POURED CONCRETE FOUNDATION. APPLY PROTECTION LAYER ON CONTINUOUS BITUMINOUS DAMP PROOFING. FINISHED BASEMENT SHALL HAVE INTERIOR DAMP PROOFING EXTENDING FROM SLAB TO GRADE LEVEL AND SHALL CONFORM TO OBC 9.13.3 (3). WHERE HYDROSTATIC PRESSURE OCCURS, FOUNDATION WALL SHALL BE WATER PROOFED AS PER OBC 9.13.3.3. INSULATE W/ R20 (R3.52) FULL HEIGHT ALONG INSIDE OF WALL AND BACKFILL W/ NON-FROST SUSCEPTIBLE SOIL. WALL SHALL EXTEND A MIN. 6" (150mm) ABOVE FIN. GRADE	SILL PLATE 2"x4" (38mm x 89mm) SILL PLATE W/ 1/2" D BOLTS 12" LONG MIN. 4" IN CONCRETE @ 7'- PLATE TO BE CAULKED OR PLACED ON A FC 1" (25mm) BEFORE COMPRESSION	BASEMENT SLAB 3" (75mm) MIN. 3600psi (25mpa) CON POLYETHYLENE ON 5" CRUSHED REINFORCED WITH 6"x6" MESH DEPTH OF SLAB. PERIMETER PENETRATIONS OF THE SLAB TO SOIL GAS LEAKAGE W/ FLEXIBLE S TO OBC 9.10.13.7. WHERE SLAB WATERPROOFED, IT SHALL BE COI	PORCH SLAB 4" (100mm) 4650psi (32mpa) CONCRETE SLAB W/ 5-8% AIR ENTERTAINMENT. 6"x6" (W2.9 X 2.9) WIRE MESH LOCATED NEAR MID DEPTH OF SLAB. ANY FILL PLACED UNDER SLAB, OTHER THAN COURSE CLEAN GRANULAR MATERIAL SHALL BE COMPACTED	PORCH SLAB ABOVE COLD CELLAR TO CONFORM WITH OBC 9.14.1.3. 6" (150mm) 4650psi (32mpa) CONCRETE SLAB W/ 5-8% AIR ENTERTAINMENT REINFORCED W/ 15M REBAR 12" O.C. W/ 15M DOWELS SPACED AT NOT MORE THAN 24" (600mm). EXPOSED SLABS SHALL BE SLOPED TO EFFECTIVELY SHED WATER AWAY FROM THE EXTERIOR WALL			
	2200ps 2200ps 0N L GRANU 2-15M BELOW	2 STEPPED F HORIZONT/ VERTICAL (3 MATEF DIA. W COMPA COMPA BOTTC GRANU DRAIN	FOUND FOUND FOUND CONFIC BASEN EXTEN CONFC PRESS PRESS RATEF R3.52) BACKF BACKF	5 SILL PI BOLTS PLATE 1" (25m	6 BASEN 3" (75m POLYE REINFG REINFG PENET PENET SOIL G TO OE WATEF	PORCH 4" (100 ENTER LOCAT LOCAT UNDEF MATEF	PORCH TO CC (32mpa REINFO SPACE SLABS SLABS			
										COMMENTS OMMENTS OMMENTS	COMMENTS
										VISED AS PER CITY C SED AS PER CITY CC VISED AS PER CITY C	PER CITY C
										26-24 4-24 11-24	4 2 4

SCHEDULE B: COMMENTS FROM AGENCIES, BUILDING STANDARDS & DEVELOPMENT PLANNING

Internal Departments *Comments Received	Conditions	Required	Nature of Comments
Building Standards (Zoning)	Yes 🗆	No 🖂	General Comments
Development Planning	Yes 🗆 🛛 No 🖂		Recommend Approval/No Conditions
External Agencies	Conditions	Required	Nature of Comments
External Agencies *Comments Received	Conditions	Required	Nature of Comments *See Schedule B for full comments
	Conditions	Required	
*Comments Received		•	*See Schedule B for full comments



Date: February 14th 2025

Attention: Christine Vigneault

RE: Request for Comments

File No.:

- Related Files: A012-25
- Applicant: Blue Grove Engineering Group
- Location 50 Sierra Court



COMMENTS:

х

We have reviewed the proposed Variance Application and have no comments or objections to its approval.

We have reviewed the proposed Variance Application and have no objections to its approval, subject to the following comments (attached below).

We have reviewed the proposed Variance Application and have the following concerns (attached below).

Alectra Utilities (formerly PowerStream) has received and reviewed the proposed Variance Application. This review, however, does not imply any approval of the project or plan.

All proposed billboards, signs, and other structures associated with the project or plan must maintain minimum clearances to the existing overhead or underground electrical distribution system as specified by the applicable standards, codes and acts referenced.

In the event that construction commences, and the clearance between any component of the work/structure and the adjacent existing overhead and underground electrical distribution system violates the Occupational Health and Safety Act, the customer will be responsible for 100% of the costs associated with Alectra making the work area safe. All construction work will be required to stop until the safe limits of approach can be established.

In the event construction is completed, and the clearance between the constructed structure and the adjacent existing overhead and underground electrical distribution system violates the any of applicable standards, acts or codes referenced, the customer will be responsible for 100% of Alectra's cost for any relocation work.

References:

- Ontario Electrical Safety Code, latest edition (Clearance of Conductors from Buildings)
- Ontario Health and Safety Act, latest edition (Construction Protection)
- Ontario Building Code, latest edition (Clearance to Buildings)
- PowerStream (Construction Standard 03-1, 03-4), attached
- Canadian Standards Association, latest edition (Basic Clearances)

If more information is required, please contact either of the following:

Mr. Stephen Cranley, C.E.T Supervisor, Distribution Design, ICI & Layouts (North) *Phone*: 1-877-963-6900 ext. 31297

E-mail: <u>stephen.cranley@alectrautilities.com</u>

Mitchell Penner

Supervisor, Distribution Design-Subdivisions *Phone*: 416-302-6215

Email: Mitchell.Penner@alectrautilities.com




Stream Construction Standard 03-1

TOUR CORRENT CONNECTION						
		SYSTEM	VOLTAGE			
LOCATION OF WIRES, CABLES OR CONDUCTORS	SPAN GUYS AND COMMUNICATIONS WIRES		4.16/2.4kV TO 27.6/16kV (SEE NOTE 1)	44kV		
	мінімим	VERTICAL CLEA	ARANCES (SEE	RANCES (SEE NOTE 2)		
OVER OR ALONGSIDE ROADS, DRIVEWAYS OR LANDS ACCESSIBLE TO <u>VEHICLES</u>	442cm	442cm	480cm	520cm		
OVER GROUND ACCESSIBLE TO <u>PEDESTRIANS</u> AND <u>BICYCLES</u> ONLY	250cm	310cm	340cm	370cm		
ABOVE TOP OF RAIL AT RAILWAY CROSSINGS	730cm	730cm	760cm	810cm		
ATTACHMENT HEIGHT + GRADE DIFF. WINIMUM ATTACHMENT HEIGHT = MAXIMUM SAG + MINIMUM VERTICAL CLEARANCE (FROM ABOVE TABLE) ± GRADE DIFFERENCE + 0.3m (VEHICLE OR RAILWAY LOCATION) + SNOW DEPTH (PEDESTRIAN LOCATION, SEE NOTE 3)						
NOTES: 1. THE MULTIGROUNDED SYSTEM NEUTRAL HAS THE SAME CLEARANCE AS THE 600V SYSTEM. 730cm 2 520cm 1 480cm 1 442cm 1						
2. THE VERTICAL CLEARANCES IN THE ABOVE TABLE ARE UNDER MAXIMUM SAG 370cm 340cm 310cm 310cm						
3. REFER TO CSA STANDARD C22.3 No.1, ANNEX D FOR LOCAL SNOW DEPTH VALUES. 250cm 8'-4"						
4. ALL CLEARANCES ARE IN ACCORD	DARD C22.3.		RENCES SIONS SECTION 02			
MINIMUM VERTICAL CLEAR WIRES, CABLES AND CON ABOVE GROUND OR RAILS	DUCTORS		This construction S	te of Approval standard meets the safety tion 4 of Regulation 22/04 <u>2012-JAN-09</u> Date		

ORIGINAL ISSUE DATE: 2010-DEC-24 REVISION NO: R1 REVISION DATE: 2012-JAN-09

P.Eng. Approval By:

Joe Crozier

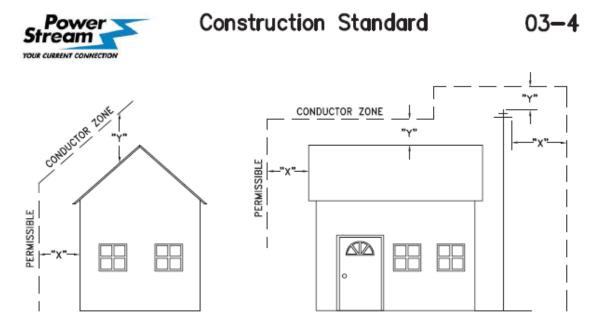

VOLTAGE	MINIMUM HORIZONTAL CLEARNACE UNDER MAXIMUM SWING CONDITIONS DIMENSION "X" (SEE NOTES 1, 3 & 4)	MINIMUM VERTICAL CLEARANCE UNDER MAXIMUM DESIGN SAG CONDITIONS DIMENSION "Y" (SEE NOTES 1, 2, 4 & 5)
0-600V AND NEUTRAL	100cm	250cm
4.16/2.4 TO 44kV	300cm	480cm

- NOTES UNDER NO CIRCUMSTANCES SHALL A CONDUCTOR BE PERMITTED TO PENETRATE THE ENVELOPE SHOWN BY THE DOTTED LINE. 1.
- 2 THE VERTICAL CLEARANCES ARE UNDER CONDITIONS OF MAXIMUM DESIGN SAG.
- THE HORIZONTAL CLEARANCES ARE UNDER CONDITIONS OF MAXIMUM SWING. WHERE THE CONDUCTOR SWING IS NOT KNOWN A HORIZONTAL CLEARANCE OF 480CM SHALL BE USED. 3.
- BUILDINGS THAT EXCEED 3 STOREYS OR 15M IN HEIGHT, THE MINIMUM HORIZONTAL CLEARANCE OF THE SECONDARY CONDUCTORS SHOULD BE INCREASED TO 300cm WHERE IT IS NECESSARY TO ALLOW FOR THE RAISING OF LADDERS BY LOCAL FIRE DEPARTMENTS. 4.
- IN SITUATIONS SUCH AS MULTI-LEVEL GARAGES, WHERE ROOFS ARE NORMALLY USED BY PERSONS AND VEHICLES, THE VERTICAL CLEARANCES OF POWERSTREAM STANDARD 03-1 SHALL APPLY. 5.
- DISTRIBUTION LINES CONSTRUCTED NEAR BUILDINGS SHALL BE BUILT TO AVOID OVERHANG WHEREVER POSSIBLE. WHERE LINES MUST BE CONSTRUCTED OVER OR ADJACENT TO BUILDINGS THE APPLICABLE HORIZONTAL AND VERTICAL CLEARANCES SHALL BE AT CONDITIONS OF MAXIMUM CONDUCTOR SWING AND MAXIMUM SAG. THE ABOVE CLEARANCES ARE DESIGNED TO PREVENT PERSONS ON OR IN BUILDINGS AS WELL AS EXTERNAL MACHINERY USED IN CONJUCTION WITH A BUILDING TO COME IN CONTACT WITH CONDUCTORS. EFFORTS SHOULD BE MADE TO INCREASE THESE CLEARANCES WHERE POSSIBLE 6. POSSIBLE.
- 7. ALL CLEARANCES ARE IN ACCORDANCE TO CSA C22.3 NO.1-06 (TABLE-9).

MINIMUM VERTICAL & HORIZONTAL CLEARANCES OF CONDUCTORS FROM BUILDINGS OR OTHER PERMANENT STRUCTURES (CONDUCTORS NOT ATTACHED TO BUILDINGS)

ORIGINAL ISSUE DATE: 2010-MAY-05 REVISION NO: REVISION DATE: PErspectem Flanding and Standards/Standard Design/FowerStream Standards/PowerStream Standards working folder/Section 2/3-4/0/WG 03-4 RD May 5, 2010 Adde PDF

CONVERS	ON TABLE
METRIC	IMPERIAL (APPROX)
480cm	16'-0"
300cm	10'-0"
250cm	8'-4"
100cm	3'-4"

Certificate of Approval This construction Standard meets the safety requirements of Section 4 of Regulation 22/04 Debbie Dadwani, P.Eng. 2010-MAY-05 Nam Date P.Eng. Approval By: D. Dadwani

/5/2010 8:22502 AM.



То:	Committee of Adjustment
From:	Sean Fitzpatrick, Building Standards Department
Date:	February 14, 2025
Applicant:	Blue Grove Engineering Group
Location:	50 Sierra Court PLAN 65M3106 Lot 49
File No.(s):	A012/25

Zoning Classification:

The subject lands are zoned R2A (EN), Second Density Residential, Established Neighbourhoods Zone and subject to the provisions of Exception 14.523 under Zoning By-law 001-2021, as amended.

#	Zoning By-law 001-2021	Variance requested
1	A residential accessory structure with a height greater than 2.8 m shall not be located closer than 2.4 m to any lot line. [4.1.2]	To permit a residential accessory structure with a height greater than 2.8 m to be located no closer than 2.17 m to a lot line (south).
2	The maximum height of a residential accessory structure shall be 3.0 m. [4.1.4]	To permit a maximum height of 3.1 m. for a residential accessory structure.

Staff Comments:

Stop Work Order(s) and Order(s) to Comply:

There are no outstanding Orders on file

Building Permit(s) Issued:

Building Permit No. 24-133776 for Single Detached Dwelling - Deck, Issue Date: Oct 24, 2024

Building Permit No. 24-123293 for Shed/Gazebo - New, Issue Date: Oct 01, 2024 Building Permit No. 24-123293 for Shed/Gazebo - Alteration, Issue Date: (Not Yet Issued)

Other Comments:

Gei	neral Comments
1	The applicant shall be advised that additional variances may be required upon review of
	detailed drawing for building permit/site plan approval.
2	The submitted elevation drawings provide established grade as defined in section 3.0 of
	zoning by-law 001 – 2021 as amended. The applicant shall confirm that the height is
	based on the existing grades.

Conditions of Approval:

If the committee finds merit in the application, the following conditions of approval are recommended.

* Comments are based on the review of documentation supplied with this application.



То:	Christine Vigneault, Committee of Adjustment Secretary Treasurer
From:	Nancy Tuckett, Director of Development and Parks Planning
Date:	March 12, 2025
Name of Owner:	Patrizia Tucci
Location:	50 Sierra Court, Maple
File No.(s):	A012/25

Proposed Variance(s) (By-law 001-2021):

- 1. To permit a residential accessory structure with a height greater than 2.8 m to be located no closer than 2.17 m to a lot line (south).
- 2. To permit a maximum height of 3.1 m. for a residential accessory structure.

By-Law Requirement(s) (By-law 001-2021):

- 1. A residential accessory structure with a height greater than 2.8 m shall not be located closer than 2.4 m to any lot line.
- 2. The maximum height of a residential accessory structure shall be 3.0 m.

Official Plan:

City of Vaughan Official Plan 2010 ('VOP 2010'): "Low-Rise Residential"

Comments:

The Owner is seeking relief to permit the construction of a pool house, with the above noted variances.

The Development and Parks Planning Department has no objection to Variance 1 to permit the pool house to be located 2.17 m to the south lot line, whereas the Zoning Bylaw permits 2.4 m. The pool house maintains a sufficient separation distance to the abutting property to the south and provides adequate access for maintenance, if required. The Development Engineering Department has also reviewed this proposal and have no objections.

The Development and Parks Planning Department has no objection to Variance 2 to permit the pool house to be 3.1 m in height, whereas the Zoning By-law permits 3.0 m. The proposed 0.1 m increase to the height of the pool house is minimal in nature and is not anticipated to cause any adverse massing impacts to the adjacent properties.

Accordingly, the Development and Parks Planning Department can support the requested variances and is of the opinion that the proposal is minor in nature, maintains the general intent and purpose of the Official Plan and Zoning By-law, and is desirable for the appropriate development of the land.

Recommendation:

The Development and Parks Planning Department recommends approval of the application.

Conditions of Approval:

If the Committee finds merit in the application, the following conditions of approval are recommended:

None.

Comments Prepared by:

Alyssa Pangilinan, Planner 1 Janany Nagulan, Senior Planner

From:	Cameron McDonald
То:	Committee of Adjustment Mailbox
Subject:	[External] RE: A012/25 - 50 SIERRA COURT - REQUEST FOR COMMENTS, CITY OF VAUGHAN
Date:	Tuesday, February 18, 2025 2:49:29 PM

CAUTION! This is an external email. Verify the sender's email address and carefully examine any links or attachments before clicking. If you believe this may be a phishing email, please use the Phish Alert Button.

Hello,

Based on a review of our screening mapping, I can confirm that the subject property is not located within TRCA's Regulated Area. As such, any site alteration or development on the property would not require a permit from the TRCA.

Based on the above, we have no comments/requirements.

Regards,

Cameron McDonald

Planner I Development Planning and Permits | Development and Engineering Services

T: (437) 880-1925

E: <u>cameron.mcdonald@trca.ca</u> A: <u>5 Shoreham Drive, Toronto, ON, M3N 1S4 | trca.ca</u>





From:	Hurst, Gabrielle
То:	Committee of Adjustment Mailbox
Subject:	[External] RE: A012/25 - 50 SIERRA COURT - REQUEST FOR COMMENTS, CITY OF VAUGHAN
Date:	Tuesday, February 18, 2025 8:39:52 AM

CAUTION! This is an external email. Verify the sender's email address and carefully examine any links or attachments before clicking. If you believe this may be a phishing email, please use the Phish Alert Button.

Good morning,

The Regional Municipality of York has completed its review of the above minor variance and has no comment.

Regards,

Gabrielle

Gabrielle Hurst MCIP, RPP | Associate Planner, Development Planning, Economic and Development Services Branch | The Regional Municipality of York | 1-877 464 9675 ext 71538 | gabrielle.hurst@york.ca |www.york.ca

SCHEDULE C: PUBLIC & APPLICANT CORRESPONDENCE

Correspondence Type	Name	Address	Date Received (mm/dd/yyyy)	Summary
N/A				

SCHEDULE D: BACKGROUND

	Application Description (i.e. Minor Variance Application; Approved by COA / OLT)
N/A	N/A