ITEM: 6.2

# REPORT SUMMARY MINOR VARIANCE APPLICATION FILE NUMBER A158/24

Report Date: January 31, 2025

## THIS REPORT CONTAINS COMMENTS FROM THE FOLLOWING DEPARTMENTS & AGENCIES (SEE SCHEDULE B):

Additional comments from departments and agencies received after the publication of the report will be made available on the City's <u>website</u>.

Internal Departments *Comments Received	Conditions Required		Nature of Comments
Committee of Adjustment	Yes □	No ⊠	General Comments
Building Standards (Zoning)	Yes □	No ⊠	General Comments
Development Planning	Yes □	No ⊠	Recommend Approval/No Conditions
Development Engineering	Yes ⊠	No □	General Comments w/Conditions
Forestry	Yes □	No ⊠	General Comments
Development Finance	Yes □	No ⊠	General Comments
By-law & Compliance	Yes □	No ⊠	General Comments

External Agencies *Comments Received	Conditions Required		Nature of Comments *See Schedule B for full comments
Alectra	Yes □	No ⊠	General Comments
Region of York	Yes □	No ⊠	General Comments
TRCA	Yes □	No ⊠	General Comments

### PUBLIC & APPLICANT CORRESPONDENCE (SEE SCHEDULE C)

All personal information collected because of this public meeting (including both written and oral submissions) is collected under the authority of the Municipal Act, the Municipal Freedom of Information and Protection of Privacy Act (MFIPPA), the Planning Act and all other relevant legislation, and will be used to assist in deciding on this matter. All personal information (as defined by MFIPPA), including (but not limited to) names, addresses, opinions and comments collected will become property of the City of Vaughan, will be made available for public disclosure (including being posted on the internet) and will be used to assist the Committee of Adjustment and staff to process this application.

Correspondence Type	Name	Address	Date Received (mm/dd/yyyy)	Summary
None				

BACKGROUND (SCHEDULE D, IF REQUIRED)		
* Background Information contains historical development approvals considered to be related to this file.		
This information should not be considered comprehensive.		
Application No. (City File)  Application Description		
(i.e. Minor Variance Application; Approved by COA / OLT)		
N/A		

ADJOURNMENT HISTORY		
* Previous hearing dates where this application was adjourned by the Committee and public notice issued.		
Hearing Date Reason for Adjournment (to be obtained from NOD_ADJ)		
N/A		N/A

SCHEDULES		
Schedule A	Drawings & Plans Submitted with the Application	
Schedule B	Comments from Agencies, Building Standards & Development Planning	
Schedule C (if required)	Public & Applicant Correspondence	
Schedule D (if required)	Background	



### MINOR VARIANCE APPLICATION FILE NUMBER A158/24

CITY WARD #:	2
APPLICANT:	Anthony Tersigni
AGENT:	Gerardo Gutierrez
PROPERTY:	246 Sylvadene Parkway, Woodbridge
ZONING DESIGNATION:	See below.
VAUGHAN OFFICIAL PLAN (2010) DESIGNATION:	Vaughan Official Plan 2010 ('VOP 2010'): "Low-Rise Residential"
RELATED DEVELOPMENT APPLICATIONS:	N/A
PURPOSE OF APPLICATION:	Relief from the Zoning By-law is being requested to permit an existing gazebo and shed in the rear of the property.

The following variances have been requested from the City's Zoning By-law:

The subject lands are zoned R1C(EN) – First Density Residential Zone (Established Neighbourhood) under Zoning By-law 001-2021, as amended.

#	Zoning By-law 001-2021	Variance requested
1	The maximum height of a residential	To permit a maximum height of 3.2 metres for a
	accessory structure shall be 3.0 m. [4.14]	residential accessory structure (stucco shed).
2	The maximum height of a residential	To permit a maximum height of 4.07 metres for a
	accessory structure shall be 3.0 m. [4.14]	residential accessory structure (gazebo).

### **HEARING INFORMATION**

DATE OF MEETING: Thursday, February 6, 2025

**TIME:** 6:00 p.m.

MEETING LOCATION: Vaughan City Hall, Woodbridge Room (2<sup>nd</sup> Floor), 2141 Major Mackenzie Drive

LIVE STREAM LINK: Vaughan.ca/LiveCouncil

### **PUBLIC PARTICIPATION**

If you would like to speak to the Committee of Adjustment at the meeting, either remotely or in person, please complete the **Request to Speak Form** and submit to **cofa@vaughan.ca** 

If you would like to submit written comments, please quote file number above and submit by mail or email to:

Email: cofa@vaughan.ca

**Mail:** City of Vaughan, Office of the City Clerk, Committee of Adjustment, 2141 Major Mackenzie Drive, Vaughan, ON, L6A 1T1

To speak electronically, pre-registration is required by completing the Request to Speak Form on-line and submitting it to cofa@vaughan.ca no later than NOON on the last business day before the meeting.

THE DEADLINE TO REGISTER TO SPEAK ELECTRONICALLY OR SUBMIT WRITTEN COMMENTS ON THE ABOVE NOTED FILE(S) IS <u>NOON</u> ON THE LAST BUSINESS DAY BEFORE THE MEETING.

### **INTRODUCTION**

Staff and Agencies act as advisory bodies to the Committee of Adjustment. The comments contained in this report are presented as recommendations to the Committee.

Section 45(1) of the Planning Act sets the criteria for authorizing minor variances to the City of Vaughan's Zoning By-law. Accordingly, review of the application may consider the following:

#### INTRODUCTION

That the general intent and purpose of the by-law will be maintained.

That the general intent and purpose of the official plan will be maintained.

That the requested variance(s) is/are acceptable for the appropriate development of the subject lands. That the requested variance(s) is/are minor in nature.

Public written and oral submissions relating to this application are taken into consideration by the Committee of Adjustment as part of its deliberations and final decision on this matter.

<u> </u>		
COMMITTEE OF ADJUSTMENT		
Data Dadalla Matta a Matta da	I	
Date Public Notice Mailed:	January 23, 2025	
Date Applicant Confirmed Posting of	December 23, 2025	
,	December 25, 2025	
Sign:		
Applicant Justification for Variances:	Gazebo height surpass the maximum permit height	
*As provided in Application Form		
Was a Zoning Review Waiver (ZRW) Form	Yes □ No ⊠	
submitted by Applicant:		
*ZRW Form may be used by applicant in instances where a		
revised submission is made, and zoning staff do not have an		
opportunity to review and confirm variances prior to the		
issuance of public notice.		
COMMENTS:		
None		
Committee of Adjustment Recommended	None	
Conditions of Approval:		
Conditions of Approval.		
	•	

BUILDING STANDARDS (ZONING)	
**See Schedule B for Building Standards (Zoning) Comments	
Building Standards Recommended Conditions of Approval:	None

DEVELOPMENT PLANNING	
**See Schedule B for Development Planning Comments.	
Development Planning Recommended Conditions of Approval:  None	

### **DEVELOPMENT ENGINEERING**

<u>Link to Grading Permit</u> <u>Link to Pool Permit</u> <u>Link to Curb Curt Permit</u> <u>Link Culvert Installation</u>

The Owner / Applicant shall ensure that the proposed gazebo does not negatively impact neighbours

due to surface water runoff. The property should be properly graded, ensuring that surface water from the proposed addition does not flow onto adjacent lots. It's important to note that additions more than 10 m² necessitate a Grading Permit. Once the Grading Permit is obtained, please reach out to the Development Engineering Reviewer to clear the Condition imposed on this application. The Development Engineering Department does not object to the Minor Variance application A158/24, subject to the following condition(s):

Development Engineering Recommended Conditions of Approval:

The Owner/Applicant shall submit an application and obtain an approved Grading Permit before initiating any work on the property. The Final Lot Grading and/or Servicing Plan will be required for the Grading Permit Application. Please visit the Permits page of the City of Vaughan's website: <a href="Permits">Permits</a> | City of Vaughan to apply for a Grading Permit. For any inquiries regarding the Grading Permit, please email DEPermits@vaughan.ca

PARKS, FORESTRY & HORTICULTURE (PFH)		
Forestry has no comment at this time.		
PFH Recommended Conditions of Approval:	None	

	DEVELOPMENT FINANCE	
No comment no concerns		

# DEVELOPMENT FINANCE Development Finance Recommended Conditions of Approval: None

BY-LAW AND COMPLIANCE, LICENSING AND PERMIT SERVICES		
no objection or comments		
BCLPS Recommended Conditions of Approval:	None	

BUILDING INSPECTION (SEPTIC)		
None		
Building Inspection Recommended None Conditions of Approval:		

F	FIRE DEPARTMENT	
None		
Fire Department Recommended Conditions of Approval:	None	

### RECOMMENDED CONDITIONS OF APPROVAL SUMMARY

Should the Committee find it appropriate to approve this application in accordance with request and the sketch submitted with the application, as required by Ontario Regulation 200/96, the following conditions have been recommended:

#	DEPARTMENT / AGENCY	CONDITION	
1	Development Engineering	The Owner/Applicant shall submit an	
	Rex.bondad@vaughan.ca	application and obtain an approved Grading	
		Permit before initiating any work on the	
		property. The Final Lot Grading and/or	
		Servicing Plan will be required for the Grading	
		Permit Application. Please visit the Permits	
		page of the City of Vaughan's website: Permits	
		<u>City of Vaughan</u> to apply for a Grading	
		Permit. For any inquiries regarding the Grading	
		Permit, please email DEPermits@vaughan.ca	

All conditions of approval, unless otherwise stated, are considered to be incorporated into the approval "**if** required". If a condition is no longer required after an approval is final and binding, the condition may be waived by the respective department or agency requesting conditional approval. A condition cannot be waived without written consent from the respective department or agency.

### **IMPORTANT INFORMATION**

**CONDITIONS:** It is the responsibility of the owner/applicant and/or authorized agent to obtain and provide a clearance letter from respective department and/or agency (see condition chart above for contact). This letter must be provided to the Secretary-Treasurer to be finalized. All conditions must be cleared prior to the issuance of a Building Permit.

#### IMPORTANT INFORMATION

**APPROVALS:** Making any changes to your proposal after a decision has been made may impact the validity of the Committee's decision.

An approval obtained from the Committee of Adjustment, where applicable, is tied to the building envelope shown on the plans and drawings submitted with the application and subject to the variance approval.

A building envelope is defined by the setbacks of the buildings and/or structures shown on the plans and drawings submitted with the application, as required by Ontario Regulation 200/96. Future development outside of an approved building envelope, where a minor variance was obtained, must comply with the provisions of the City's Zoning By-law.

Elevation drawings are provided to reflect the style of roof (i.e. flat, mansard, gable etc.) to which a building height variance has been applied. Where a height variance is approved, building height is applied to the style of roof (as defined in the City's Zoning By-law) shown on the elevation plans submitted with the application.

Architectural design features that are not regulated by the City's Zoning By-law are not to be considered part of an approval unless specified in the Committee's decision.

**DEVELOPMENT CHARGES:** That the payment of the Regional Development Charge, if required, is payable to the City of Vaughan before issuance of a building permit in accordance with the Development Charges Act and the Regional Development Charges By-law in effect at the time of payment.

That the payment of the City Development Charge, if required, is payable to the City of Vaughan before issuance of a building permit in accordance with the Development Charges Act and the City's Development Charges By-law in effect at the time of payment.

That the payment of the Education Development Charge if required, is payable to the City of Vaughan before issuance of a building permit in accordance with the Development Charges Act and the Boards of Education By-laws in effect at the time of payment


That the payment of Special Area Development charge, if required, is payable to the City of Vaughan before issuance of a building permit in accordance with the Development Charges Act and The City's Development Charge By-law in effect at the time of Building permit issuance to the satisfaction of the Reserves/Capital Department.


**NOTICE OF DECISION:** If you wish to be notified of the decision in respect to this application or a related Ontario Land Tribunal (OLT) hearing you must complete a Request for Decision form and submit to the Secretary Treasurer (ask staff for details). In the absence of a written request to be notified of the Committee's decision you will **not** receive notice.


### **SCHEDULE A: DRAWINGS & PLANS**



## **VAUGHAN** Minor Variance Application A158/24

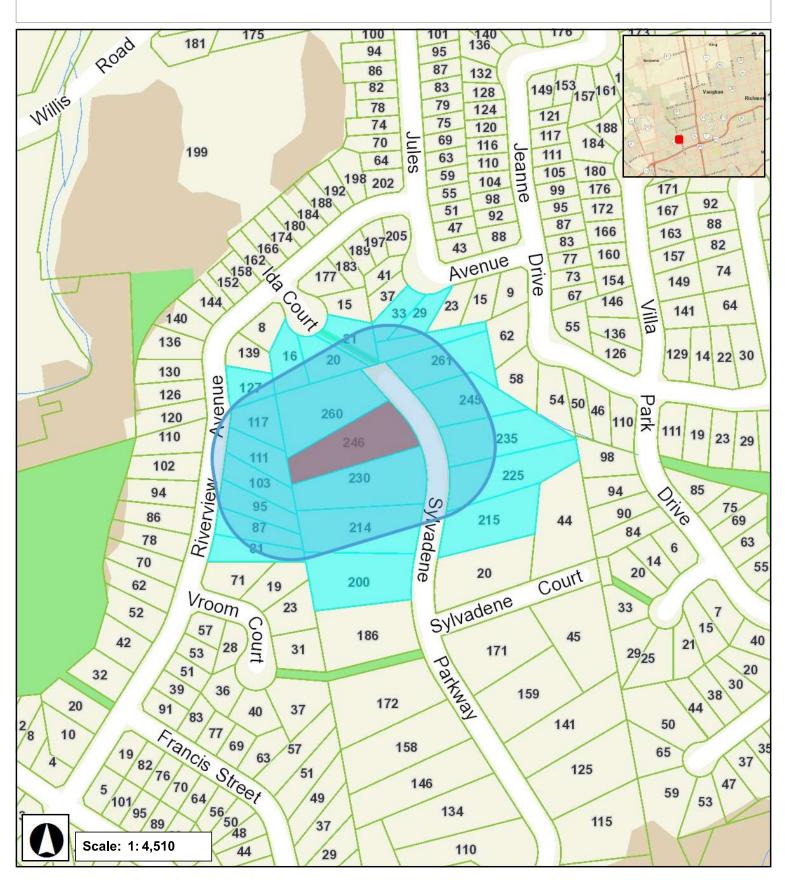

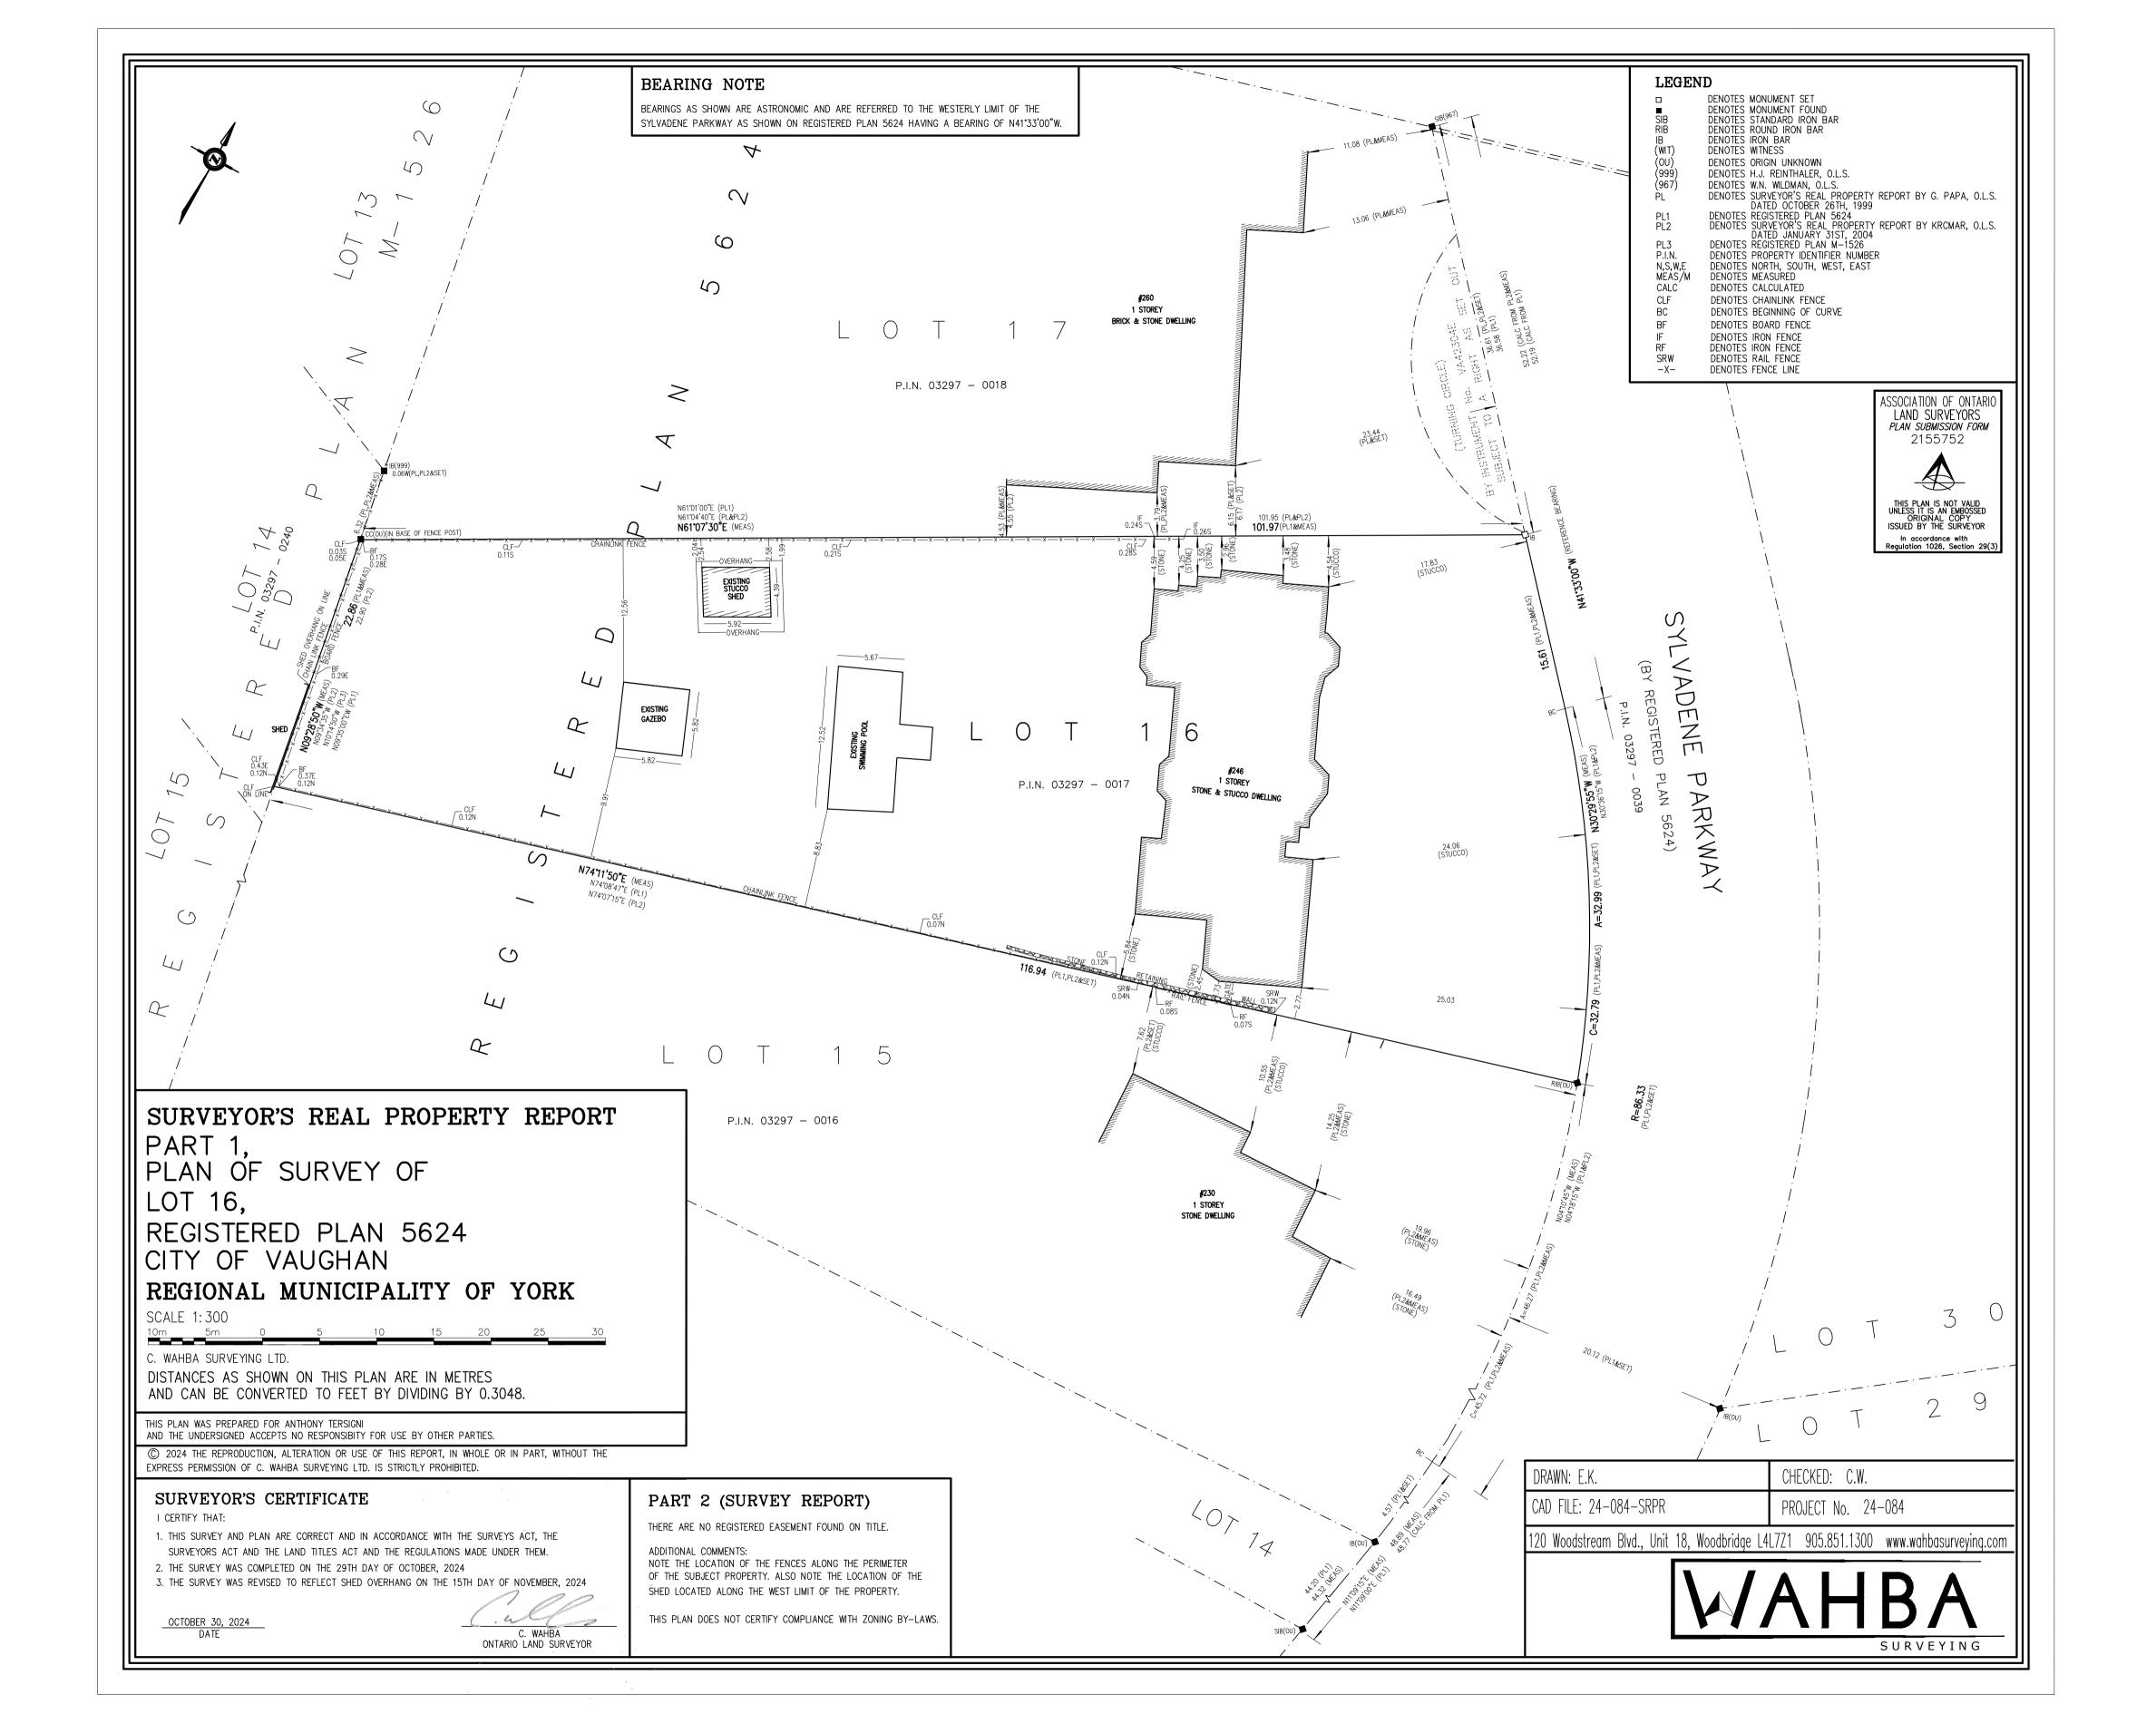

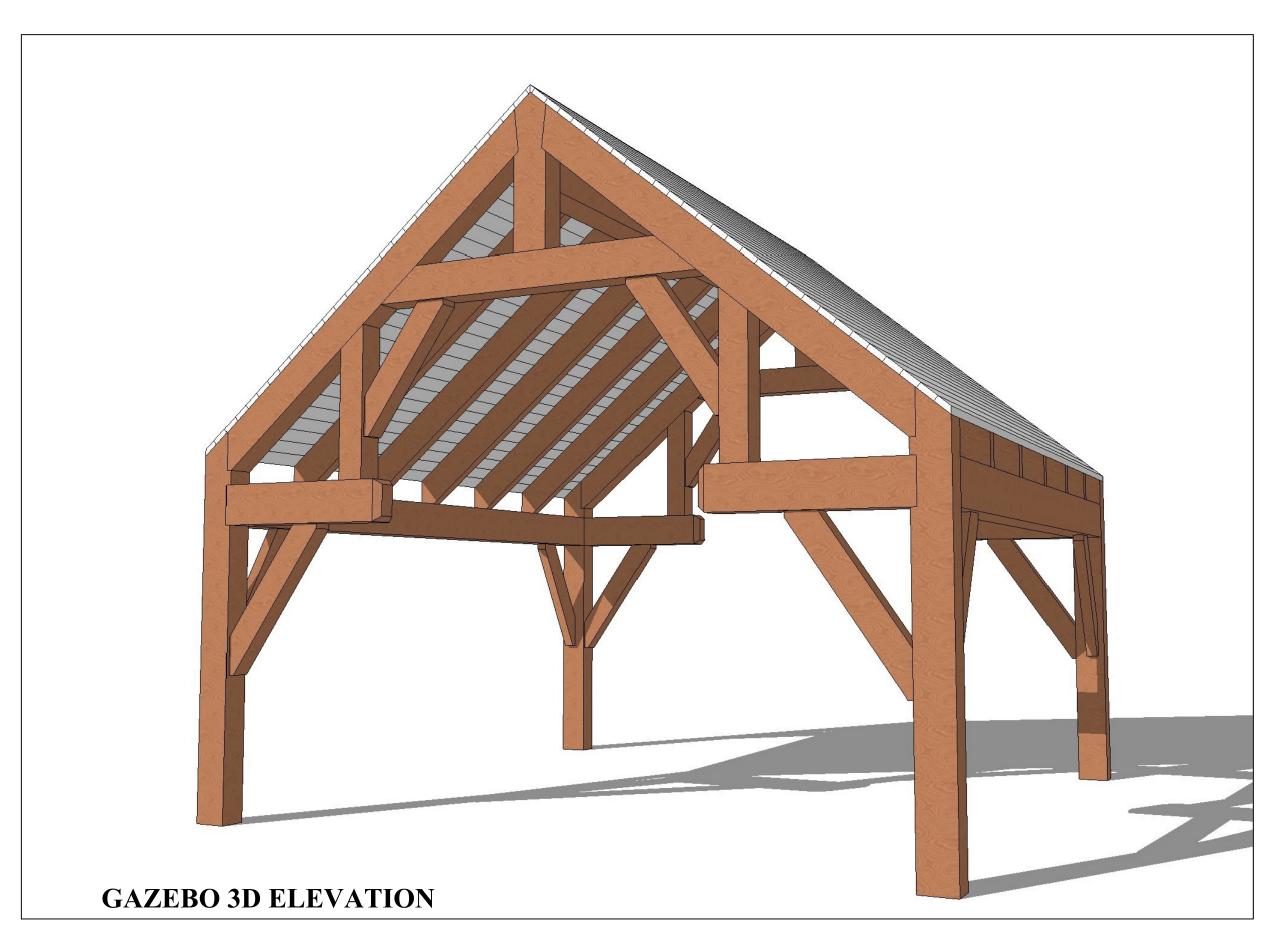



### Structural Engineering

UNIT 5 160 APPLEWOOD CRES. CONCORD. ONTARIO L4K 4E5

THE CONTRACTOR SHALL VERIFY ALL DIMENIONS AND SITE CONDITIONS SHOWN ON THIS DRAWING. ANY DISCREPANCY SHOULD BE REPORTED TO THE ENGINEER FOR CLARIFICATION BEFORE STARTING ANY WORK.

REVISIONS			
NO.	DESCRIPTION	CHECKED BY	DRAWN BY
1.	"AS BUILT"	GG	GG
2.	"AS BUILT"	GG	GG



PERMIT TO PRACTICE **2G ENGINEERING INC.** 

MEMBER NUMBER: 100206112

DATE: NOV. 21, 2024

CLIENT:

ANTHONY TERSIGNI

246 SYLVADENE PARKWAY VAUGHAN. ON.

PROJECT:

CUSTOM "AS BUILT" GAZEB0

DRAWING TITLE:

SCALE:

ELEVATION

PROJECT NO:

N.T.S. DRAWN BY:

### GENERAL NOTES

All construction to comply with requirements of the 2012 Ontario Building Code and Supplementary Standard SB-12 Table 3.1.1.11. (IP) Thermal Performance Requirements for Additions to Existing Buildings

### THICKENED EDGE SLAB (SUPPORTING EXTERIOR WALL)

FOUNDATION FOR SHED (AS SHOWN ON DETAIL D2)

- 16' x 12" thickened edge concrete slab"
- minimum 50 mm (2") ridge insulation on undisturbed soil capable of carrying 75 KPa (1500 lbs. per sq.ft.)
- 6" concrete slab w/ 10M @ 12" o.c. E. W.
- 32 Mpa (4700 P.S.I.) at 28 days

### (1A) THICKENED EDGE SLAB (AROUND GAZEBO)

GAZEBO'S SLAB (AS SHOWN ON DETAIL D1)

- 12' x 20" thickened edge concrete slab"
- minimum 50 mm (2") ridge insulation on undisturbed soil capable of carrying 75 KPa (1500 lbs. per sq.ft.)
- 6" concrete slab w/ 10M @ 12" o.c. E. W.
- 32 Mpa (4700 P.S.Í.) at 28 days

### FRAME WALL CONSTRUCTION

DRAINED STUCCO WALL CONSTRUCTION

- "Durock" insulated stucco system complying with CCMC No. 12969 - R. R5ci min. 2" of PUCCS Insulation, min. R3.75/inch
- 12.7 mm (1/2") Cement board sheathing
- No. 15 (0.7 kg/m sq.) TYVEK "house wrap"
- 12.7 mm (1/2") exterior type sheathing 38 X 140 mm (2" X 6") studs @ 406 mm (16") o.c.
- Double top plate Single bottom plate-

### INTERIOR PARTITIONS

- 38 X 89 mm (2" X 4") studs at 406 mm (16") o.c.
- 38 X 140 mm (2" X 6") studs at 406 mm (16") o.c. as indicated on drawings
- 12.7 mm (1/2") interior drywall on exposed sides
- Single top and bottom plate
- Blocking for grab bars at main bath

### ROOF CONSTRUCTION (FOR THE SHED)

- 10.26 kg/m sq. (No 210) asphalt shingles
- type 'S' roll roofing from edge of roof extending a minimum distance of 900 mm up the roof slope to a line not less than 300 mm (11-3/4") past the inside face of exterior wall
- starter strip No. 85 (2 kg/m sq.) (85 lb) roll roofing or roof shingle of same weight and quality as used on roof laid with tabs facing up
- 10m mm (3/8") plywood sheathing with 'H' clips

#### ROOF STRUCTURE:

- 2-2X10 Ridge beam
- 2x8 Hip Beams
- 2x6 Jack Rafters @ 16" o.c.
- 2x6 Roof Rafters @ 16' o.c.
- approved wood trusses at 600 mm (24") o.c.
- 2"x 4" roof ties between each rafter @ middle
- roof slopes 4:12.
- 4" metal eaves trough on aluminum fascia and aluminum vented soffit.
- 2x6 Ceiling joists @ 16" o.c. W/ 2x4 blocking @ 2'-0" o.c.

### (8A) ROOF CONSTRUCTION (FOR THE GAZEBO)

- 10.26 kg/m sq. (No 210) asphalt shingles
- type 'S' roll roofing from edge of roof extending a minimum distance of 900 mm up the roof slope to a line not less than 300 mm (11-3/4") past the inside face of exterior wall
- starter strip No. 85 (2 kg/m sq.) (85 lb) roll roofing or roof shingle of same weight and quality as used on roof laid with tabs facing up

#### ROOF STRUCTURE:

- 1X6 Male-Female connection roof board
- 2x8 D. Fr. joists @ 32" o.c.
- 12x12 D. Fr. main beams
- 8x12 end beams
- 8x8 D. Fr. ties and braces
- roof slopes 10:12.
- 4" metal eaves trough

#### LINTEL SCHEDULE

WB1	2 - 38 X 184 spf	2 - 2 x 8 spf
WB2	2 - 38 X 235 spf	2 - 2 x 10 spf
WB3	2 - 38 X 286 spf	2 - 2 x 12 spf
L1	89 X 89 X 7.9	L 3-1/2 X 3-1/2 X 5/16
L2	102 X 89 X 7.9	L 4 X 3-1/2 X 5/16
L3	127 X 89 X 7.9	L 4-7/8 X 3-1/2 X 5/16
L4	127 X 89 X 11.0	L 4-7/8 X 3-1/2 X 3/8
L5	152 X 102 X 11.0	L 6 X 4 X 3/8

IMPEDIA

#### DOOR SCHEDULE

- 1- Exterior doors to have a thermal resistance of RSI 0.7 or with storm door.
- 2- Glass in sidelights greater than 500 mm (19 3/4"). in storm doors, in sliding patio doors and in shower doors to be safety glass.
- Doors to be resistant to forced entry in conformance to article .7.5.? 耐7f the O.B.C.
- Performance as per subsection 9.7.3.
- 5- Glazing in windows to conform with O.B.C. 9.6.1.3.
  - $-3'-0" \times 6'-8" \times 1-3/4"$  insulated door  $-2 - 2' - 8" \times 6' - 8" \times 1 - 3/4"$  insulated door
  - $-2'-8" \times 6'-8" \times 1-3/4"$  solid core door  $-1'-8" \times 6'-8" \times 1-3/8"$  slab
  - $-2'-0" \times 6'-8" \times 1-3/8"$  slab
  - $-2'-2" \times 6'-8" \times 1-3/8"$  slab
  - $-2'-4" \times 6'-8" \times 1-3/8"$  slab
  - $-2'-6" \times 6'-8" \times 1-3/8"$  slab
  - $-2'-8" \times 6'-8" \times 1-3/8"$  slab
  - $-2'-10" \times 6'-8" \times 1-3/8"$  slab 10
  - $-3'-0" \times 6'-8" \times 1-3/8"$  slab
  - $-2'-0" \times 6'-8" \times 1-3/8"$  slab, bifold 12
  - $-2'-6" \times 6'-8" \times 1-3/8"$  slab, bifold 13
  - -2 2' 6"  $\times 6' 8$ "  $\times 1 3/8$ " slab, bifold 14
  - 15  $-3'-0" \times 6'-8" \times 1-3/8"$  slab, bifold
  - $-2-3'-0" \times 6'-8" \times 1-3/8"$  slab, bifold 16
- $-4'-0" \times 6'-8" \times 1-3/8"$  slab, bifold 17
- -2 4'-0" X 6'-8" X 1-3/8" slab, bifold

#### **WINDOWS**

- 1- Every floor level containing bedrooms shall be provided with one window to have minimum opening area of 0.35 m sq. (3.8 sq.ft.) with no dimension less than
- 380 mm (1'-3"), Sill @ 1m above finished floor max (0.B.C. 9.9.10.) 2— At least 5% of floor area of bedrooms and at least 10% of living and dining rooms to equal transparent openings in window. (O.B.C. 9.7.2.3.)
- Natural ventilation 0.28 m sq. (3 sq.ft.) minimum. per room 3- Windows double glazed or with storm window, and to conform to O.B.C 9.6.1..
- 4- All dimensions shown are rough stud opening.
- 5- Windows located within 2m (6'-7") of adjacent around level, shall conform to the requirements for resistance to forced entry O.B.C. 9.7.5.3. and Clause 5.3.5. of AAMA/WDMA/CSA 101/I.S.2/A440.
- 6- As per Article 9.9.9.1 (2) (3) of O.B.C where there is no dwelling unit above or below another dwelling unit the third floor shall be equipped with an egress window, providing unobstructed opening of not less than 1000mm (3'3") in height & 550mm (21 5/8") in width, sill located not more than 1000mm (3'3") above floor & 7000mm (23'0") above adjacent ground level or a direct access to a balcony
- 7- Protection of Windows @ stairs, ramps and landings as per article 9.8.8.1.(7) & (8)
- 8— Manufactured Windows, Doors and Skylights and their installation shall conform to 0.B.C. 9.7.4.2. which includes the standard AAMA/WDMA/CSA 101/I.S.2/A440, "NAFS - North American Fenestration Standard/Specification for Windows, Doors, and Skyliahts"
- 9- Glazing in windows to conform with O.B.C. 9.6.1.3.

#### As per Supplementary Standard SB-12

- 1- Windows and skylights to comply with supplementary standard SB-12 Table 3.1.1.2.A. (SI) or (IP) compliance package 'A1'
- 2- Max. U-value for windows & sliding glass doors is 1.6 (0.28) with energy rating of 25 where the ratio of the gross area of windows, sidelights, skylights, glazing in doors and sliding glass doors to the gross area of peripheral walls is not more than 17%
- 3— If the ratio of the gross area of windows, sidelights, skylights, glazing in doors and sliding glass doors to the gross area of peripheral walls is more than 17% but less than 22%, the max. U-value for windows & sliding glass doors is 1.4 (0.25) unless the requirements of article 3.1.1.4. are met.
- 4- If the ratio is more than 22% the building shall comply with subsection 3.1.2. Performance Compliance of SB-12
- 5- Max. U-value of skylights is 2.8 (0.49)

#### WORK PROCEDURES

THESE DRAWINGS HAS BEEN PREPARE BASED ON A VISUAL SITE INSPECTION WITH LIMITED ACCESS AND FROM INFORMATION AND PICTURES PROVIDED TO OUR OFFICE BY THE OWNER. IF ANY DISCREPANCIES IS FOUND COMMUNICATE TO OUR OFFICE IMMEDIATELY.



### Structural Engineering

UNIT 5 160 APPLEWOOD CRES. CONCORD. ONTARIO L4K 4E5

THE CONTRACTOR SHALL VERIFY ALL DIMENIONS AND SITE CONDITIONS SHOWN ON THIS DRAWING. ANY DISCREPANCY SHOULD BE REPORTED TO THE ENGINEER FOR CLARIFICATION BEFORE STARTING ANY WORK.

REVISIONS			
NO.	DESCRIPTION	CHECKED BY	DRAWN BY
1.	"AS BUILT"	GG	GG



### PERMIT TO PRACTICE 2G ENGINEERING INC.

MEMBER NUMBER: 100206112

NOV. 21, 2024 DATF:

CLIENT:

ANTHONY TERSIGNI

LOCATION:

246 SYLVADENE PARKWAY VAUGHAN. ON.

PROJECT:

CUSTOM "AS BUILT" GAZEBO AND SHED

DRAWING TITLE:


SCALE:


GENERAL NOTES

PROJECT NO:

N.T.S.

DRAWN BY:

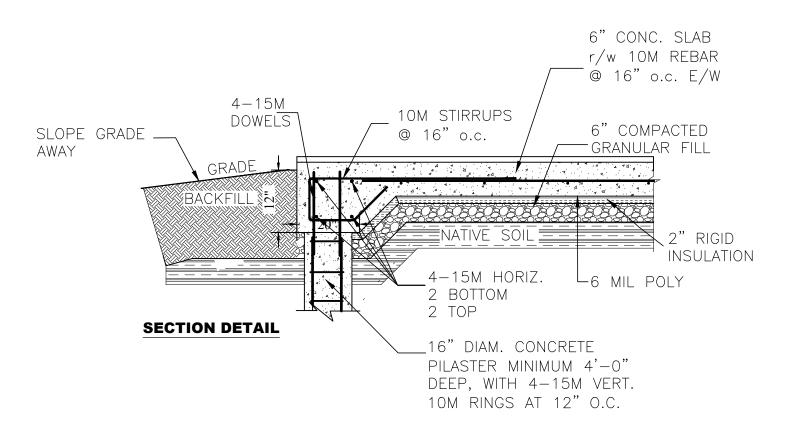

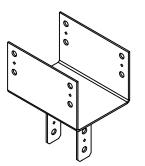

COLUMN CONNECTOR CC128 BY SIMPSON STRONG TIE.

### **DESIGN NOTES:**

- 1. Designed by 2G ENGINEERING
- Design based on:
   2012 Ontario Building Code.
   CAN/CSA A23.3—04 Design of Concrete Structures
- 3. Standard Construction Practices.
- 4. Contractor to confirm all dimensions prior to start project.
- 5. Contractor to confirm required property set backs as per City Regulation.
- 6. Site inspection is required prior to pouring concrete.
- 7. Please contact Engineer a minimum 2 days in advance.

### FOR CONTINUITY OF REINFORCEMENT (CSA A23.3-04)

BAR SIZE	MIN. LAP SPLICE	CORNER BAR LENGTH
10M	1'4" (400 mm)	3' (900 mm)
15M	2'0" (600 mm)	4' (1200 mm)
20M	2'6"(750 mm)	5' (1500 mm)

#### SPECIFICATIONS:

- 1. All material and construction procedures shall conform with: Local Building Code CSA A23.1, A23.2, A23.3, A5, G30.18.
- 2. Concrete Compressive strength (28 days) 32 MPa minimum.
- 3. Corner bars shall be cold bent at mid point.
- 4. Bars according to G30.18 Grade 400 MPa.
- 5. All bending details, dimensions, anchorage, cut-off lengths, bar supports, spacers and location of reinforcing splices shall be in accordance with CSA A23.3 latest edition, unless noted otherwise.
- 6. All reinfrocing splices shall be located at point of minimum stress.
- 7. All fill material shall be placed in horizontal layers not exceeding 6" (150mm) and shall be compacted to 98% standard proctor density.
- 8. Slope grade away from the wall so that no water accumulation in the wall structure
- 9. Min. concrete cover for reinforcement shall be as follows:
  - A. Concrete deposited against soil: 3" (75 mm)
  - B. Conc. exposed to weather after removal of form work: 2" (50 mm)
  - C. Slab and walls, except as noted in A and B: 3/4" (20 mm).




### Structural Engineering

UNIT 5 160 APPLEWOOD CRES. CONCORD. ONTARIO L4K 4E5

THE CONTRACTOR SHALL VERIFY ALL DIMENIONS AND SITE CONDITIONS SHOWN ON THIS DRAWING. ANY DISCREPANCY SHOULD BE REPORTED TO THE ENGINEER FOR CLARIFICATION BEFORE STARTING ANY WORK.

REVISIONS			
NO.	DESCRIPTION	CHECKED BY	DRAWN BY
1.	"AS BUILT"	GG	GG

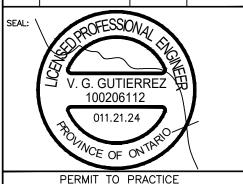

2G ENGINEERING INC.

MEMBER NUMBER: 100206112

DATE: NOV. 21, 2024

CLIENT:

ANTHONY TERSIGNI

LOCATION:

246 SYLVADENE PARKWAY VAUGHAN. ON.

PROJECT:

CUSTOM "AS BUILT" GAZEBO

DRAWING TITLE:


THICKENED SLAB DETAIL

PROJECT NO:

SCALE: N.T.S.

DRAWN BY: C.C.

DRAWING NO:

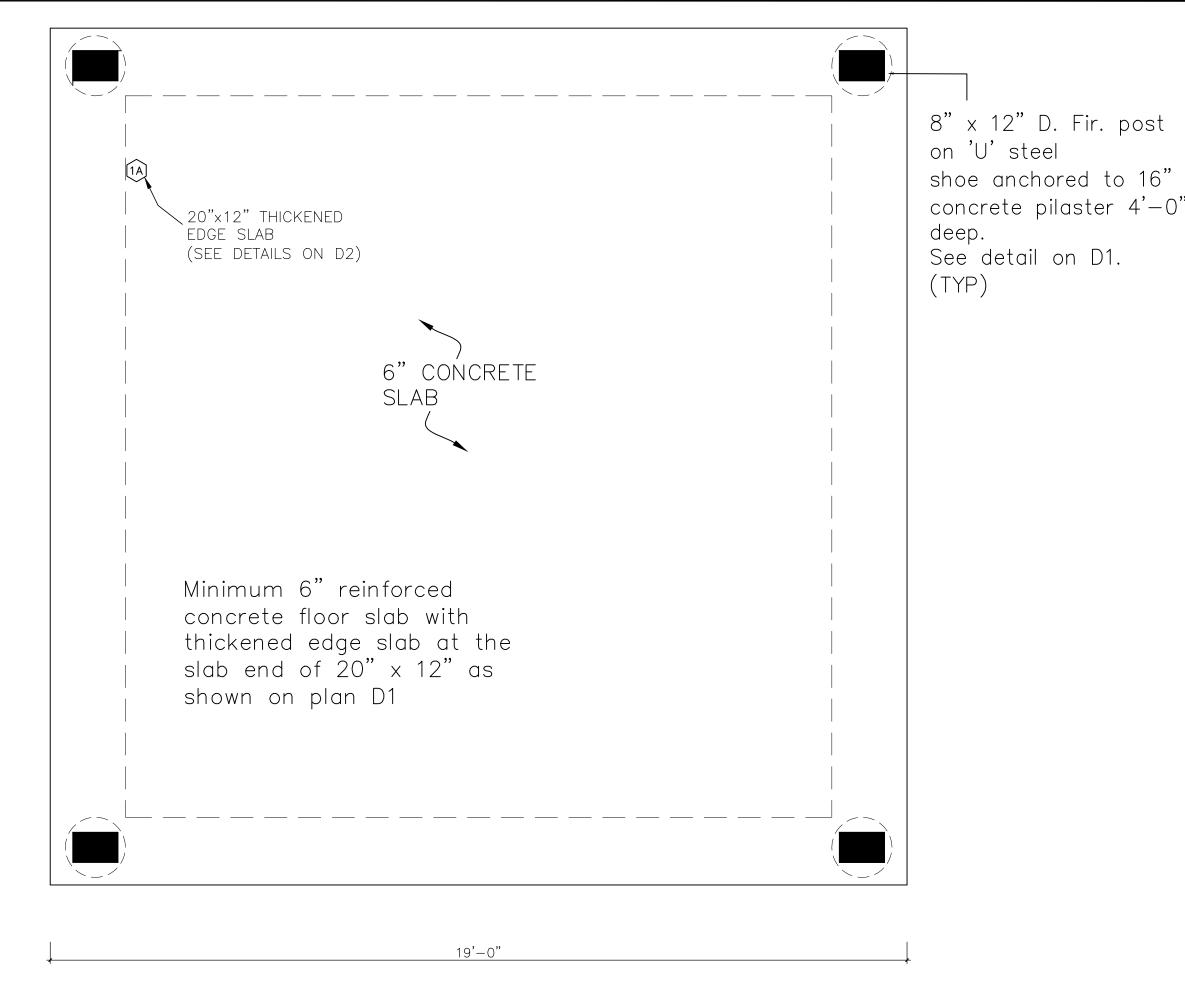


2G Engineering

### Structural Engineering

UNIT 5 160 APPLEWOOD CRES CONCORD. ONTARIO L4K 4E5

THE CONTRACTOR SHALL VERIFY ALL DIMENION AND SITE CONDITIONS SHOWN ON THIS DRAWN ANY DISCREPANCY SHOULD BE REPORTED TO ENGINEER FOR CLARIFICATION BEFORE STARTIN ANY WORK.

REVISIONS			
NO.	DESCRIPTION	CHECKED BY	DRAW
1.	"AS BUILT"	GG	GG
2.	"AS BUILT"	GG	GG

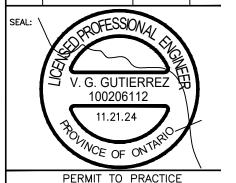

**2G ENGINEERING INC.** 

MEMBER NUMBER: 100206112

DATE: NOV. 21, 2024

CLIENT:

ANTHONY TERSIGNI

LOCATION:

246 SYLVADENE PARKWAY VAUGHAN. ON.

PROJECT:

CUSTOM "AS BUILT" **GAZEBO** 

DRAWING TITLE:


FOUNDATION PLAN

PROJECT NO: SCALE:

DRAWING NO:

**FOUNDATION PLAN** 

N.T.S. DRAWN BY:

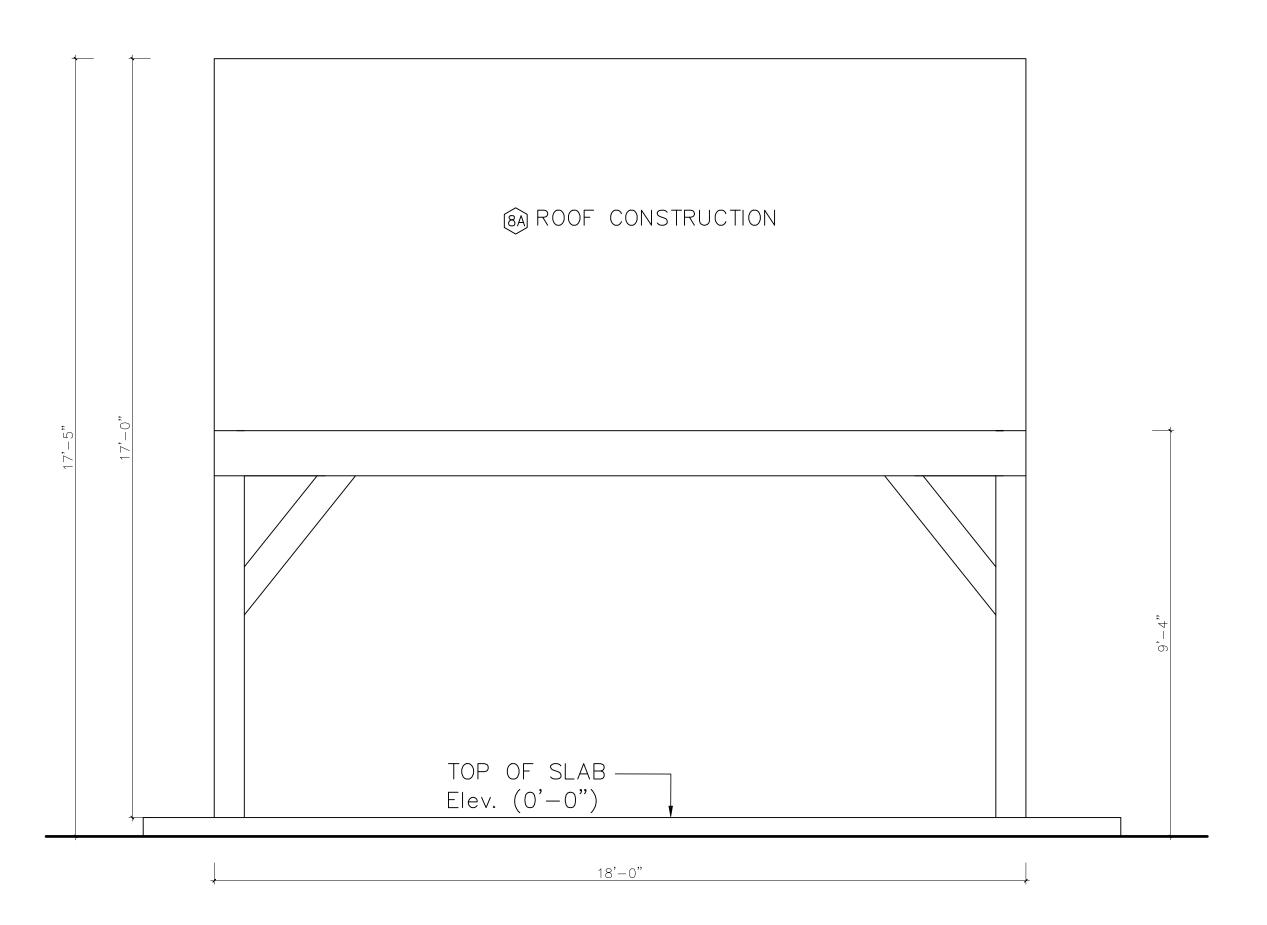

### **LEFT AND RIGHT ELEVATION**




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PROJECT:

CUSTOM "AS BUILT" GAZEBO

DRAWING TITLE:


SECTION

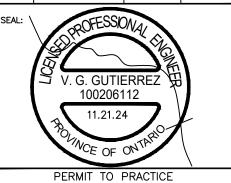PROJECT NO: DRAWING NO:

SCALE: N.T.S.

DRAWN BY: G.G.

A.T.S. A.D.

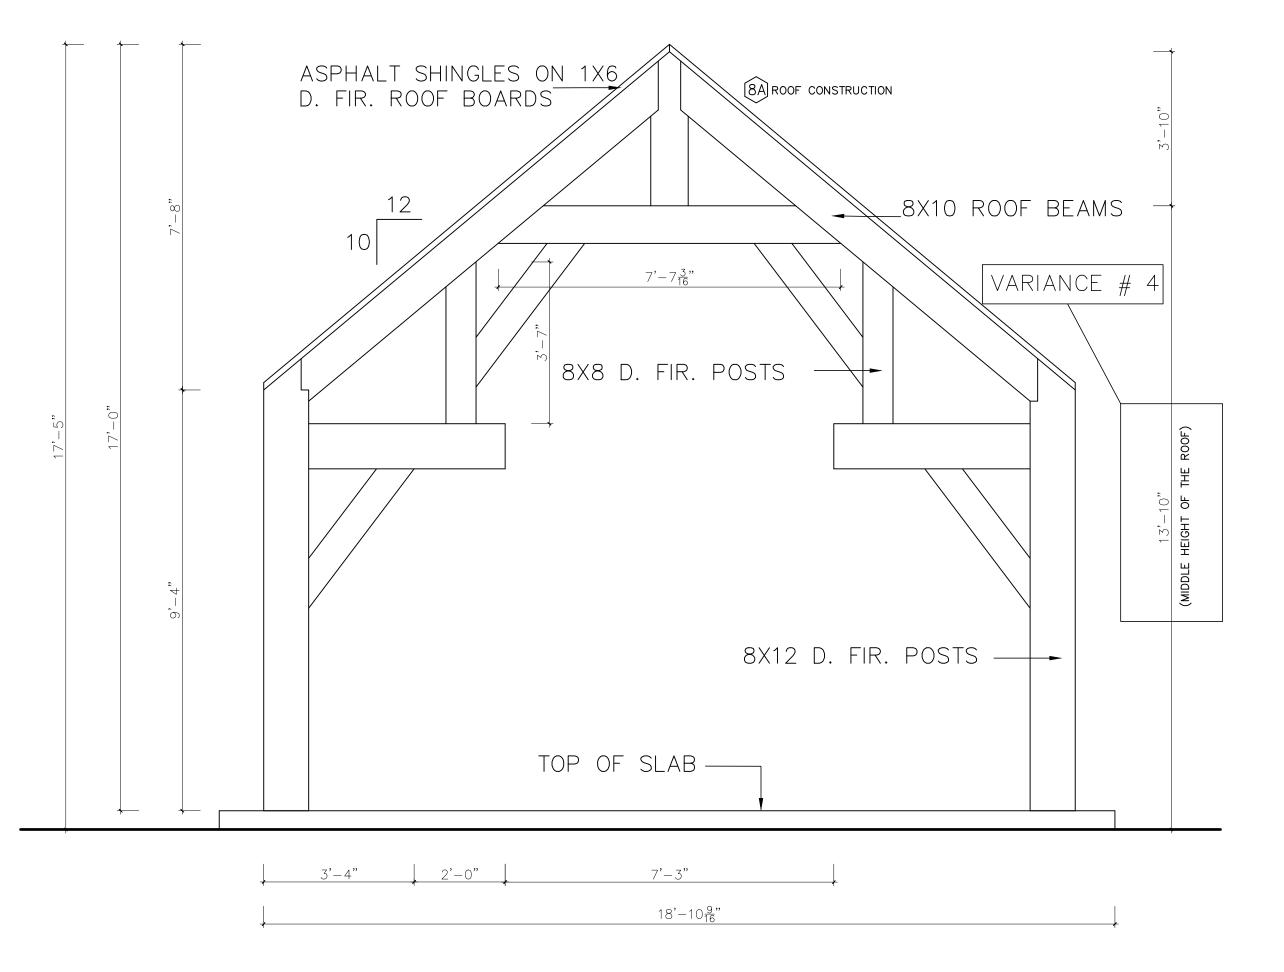

### **GAZEBO SECTION**



### Structural Engineering

UNIT 5 160 APPLEWOOD CRES. CONCORD. ONTARIO L4K 4E5

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REVISIONS						
NO.	DESCRIPTION	CHECKED BY	DRAWN BY			
1.	"AS BUILT"	GG	GG			
2.	"AS BUILT"	GG	GG			
			·			



PERMIT TO PRACTICE 2G ENGINEERING INC.

MEMBER NUMBER: 100206112

DATE: NOV. 21, 2024

CLIENT:

ANTHONY TERSIGNI

LOCATION:

246 SYLVADENE PARKWAY VAUGHAN. ON.

PROJECT:

CUSTOM "AS BUILT" **GAZEBO** 


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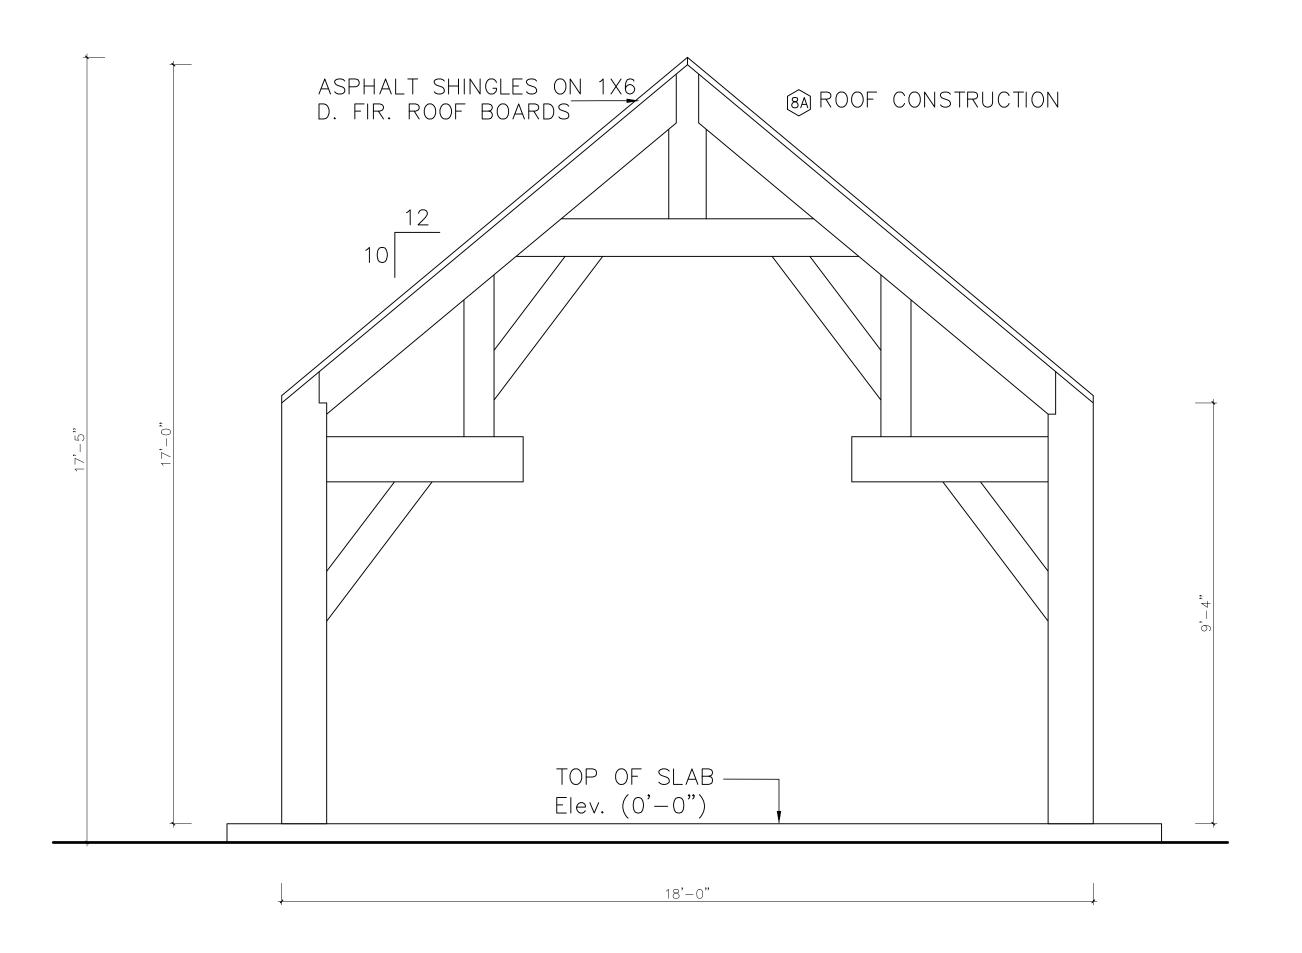
SECTION

PROJECT NO: SCALE:

DRAWN BY:

N.T.S.



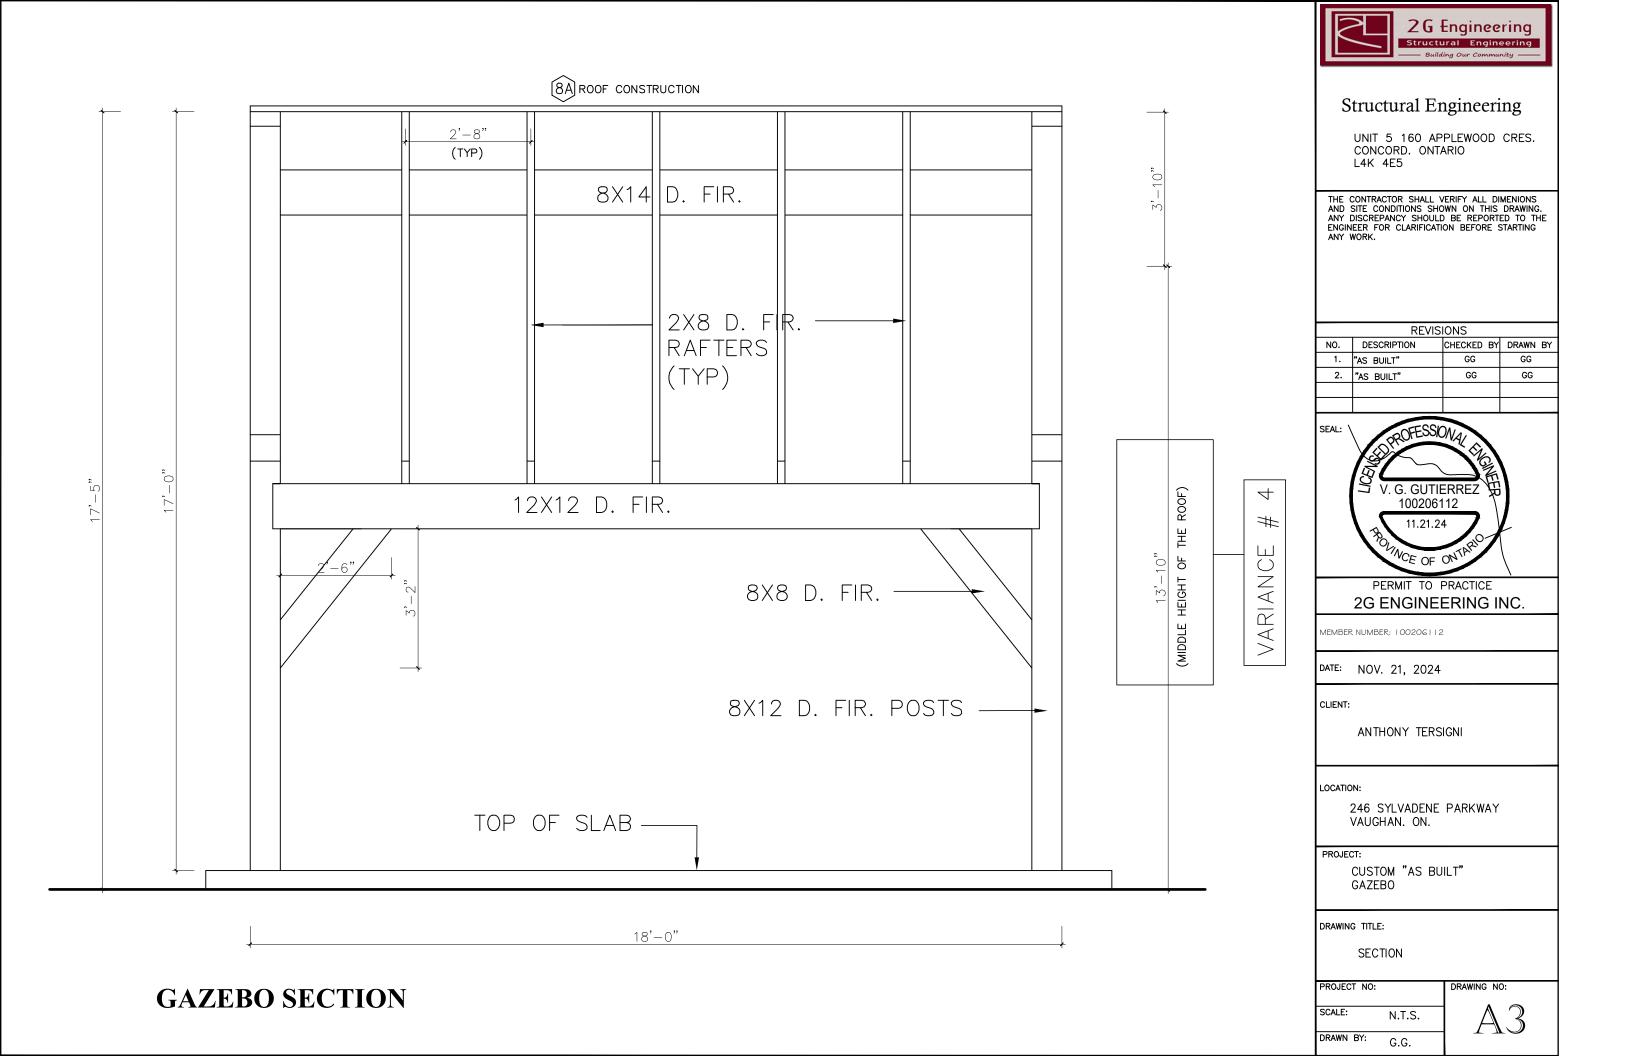

### FRONT AND REAR ELEVATION




### Structural Engineering

UNIT 5 160 APPLEWOOD CRES. CONCORD. ONTARIO L4K 4E5

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	REVISIONS					
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	1.	"AS BUILT"	GG	GG		
ı	2.	"AS BUILT"	GG	GG		
ı						

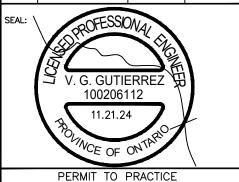

2G ENGINEERING INC.

MEMBER NUMBER: 100206112

DATE: NOV. 21, 2024

CLIENT:

ANTHONY TERSIGNI

LOCATION:

246 SYLVADENE PARKWAY VAUGHAN. ON.

PROJECT:

CUSTOM "AS BUILT" GAZEBO

N.T.S.

DRAWING TITLE:


SECTION

PROJECT NO: DRAWING NO:

DRAWN BY: C.C.

SCALE:

A9

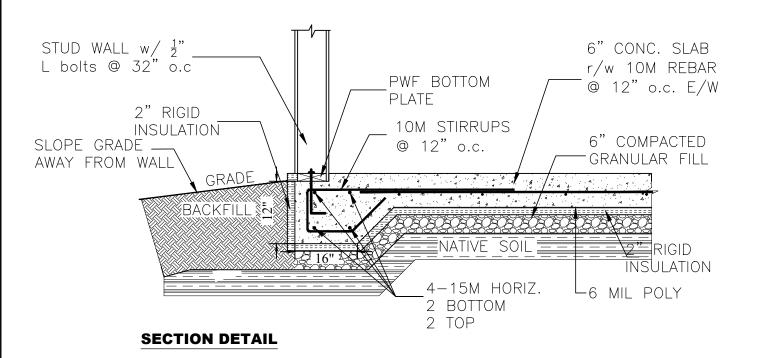

#### WORK PROCEDURES

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IF ANY DISCREPANCIES IS FOUND COMMUNICATE O OUR OFFICE IMMEDIATELY.

#### DESIGN NOTES:

- 1. Designed by 2G ENGINEERING
- Design based on: National Building Code.

CAN/CSA A23.3-04 Design of Concrete Structures

- 3. Standard Construction Practices.
- 4. Contractor to confirm all dimensions prior to start project.
- 5. Contractor to confirm required property set backs as per City Regulation.
- 6. Site inspection is required prior to pouring concrete.
- 7. Please contact Engineer a minimum 2 days in advance.

#### FOR CONTINUITY OF REINFORCEMENT (CSA A23.3-04)

BAR SIZE	MIN. LAP SPLICE	CORNER BAR LENGTH
10M	1' 4" (400 mm)	3' (900 mm)
15M	2'0" (600 mm)	4' (1200 mm)
20M	2' 6" (750 mm)	5' (1500 mm)

### SPECIFICATIONS:

- 1. All material and construction procedures shall conform with: Local Building Code CSA A23.1, A23.2, A23.3, A5, G30.18.
- 2. Concrete Compressive strength (28 days) 32 MPa minimum.
- 3. Corner bars shall be cold bent at mid point.
- 4. Bars according to G30.18 Grade 400 MPa.
- 5. All bending details, dimensions, anchorage, cut—off lengths, bar supports, spacers and location of reinforcing splices shall be in accordance with CSA A23.3 latest edition, unless noted otherwise.
- 6. All reinfrocing splices shall be located at point of minimum stress.
- 7. All fill material shall be placed in horizontal layers not exceeding 6" (150mm) and shall be compacted to 98% standard proctor density.
- 8. Slope grade away from the wall so that no water accumulation in the wall structure
- 9. Min. concrete cover for reinforcement shall be as follows:
  - A. Concrete deposited against soil: 3" (75 mm)
  - B. Conc. exposed to weather after removal of form work: 2" (50 mm)
  - C. Slab and walls, except as noted in A and B: 3/4" (20 mm).




### Structural Engineering

UNIT 5 160 APPLEWOOD CRES. CONCORD. ONTARIO L4K 4E5

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NO.	DESCRIPTION	CHECKED BY	DRAWN BY			
1.	"AS BUILT"	GG	GG			
2.	"AS BUILT"	GG	GG			

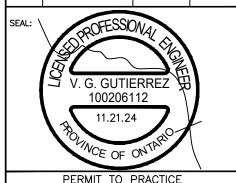

2G ENGINEERING INC.

MEMBER NUMBER: 100206112

DATE: NOV. 21, 2024

CLIENT:

ANTHONY TERSIGNI

LOCATION:

246 SYLVADENE PARKWAY VAUGHAN. ON.

PROJECT:

CUSTOM "AS BUILT" SHED

DRAWING TITLE:

FOUNDATION DETAIL

PROJECT NO:


SCALE:

N.T.S.

DRAWING NO:

DRAWN BY: G.G.

D2

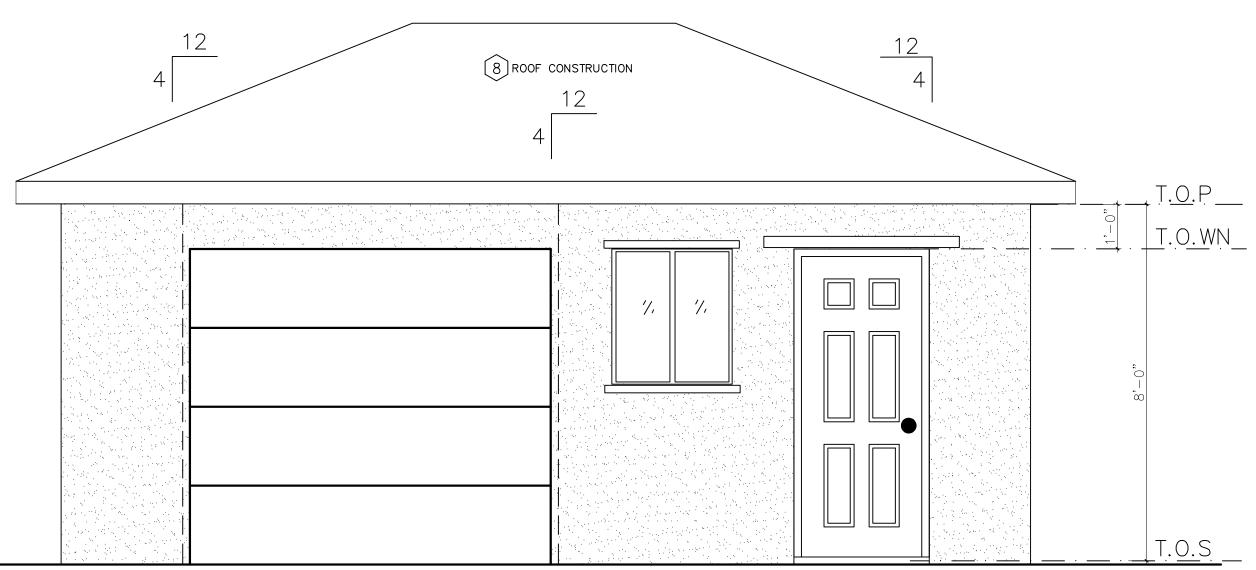

FRONT ELEVATION



### Structural Engineering

UNIT 5 160 APPLEWOOD CRES. CONCORD. ONTARIO L4K 4E5

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PROJECT:

CUSTOM "AS BUILT" SHED


DRAWING TITLE:

**ELEVATIONS** 

PROJECT NO:

SCALE: N.T.S.

DRAWN BY:

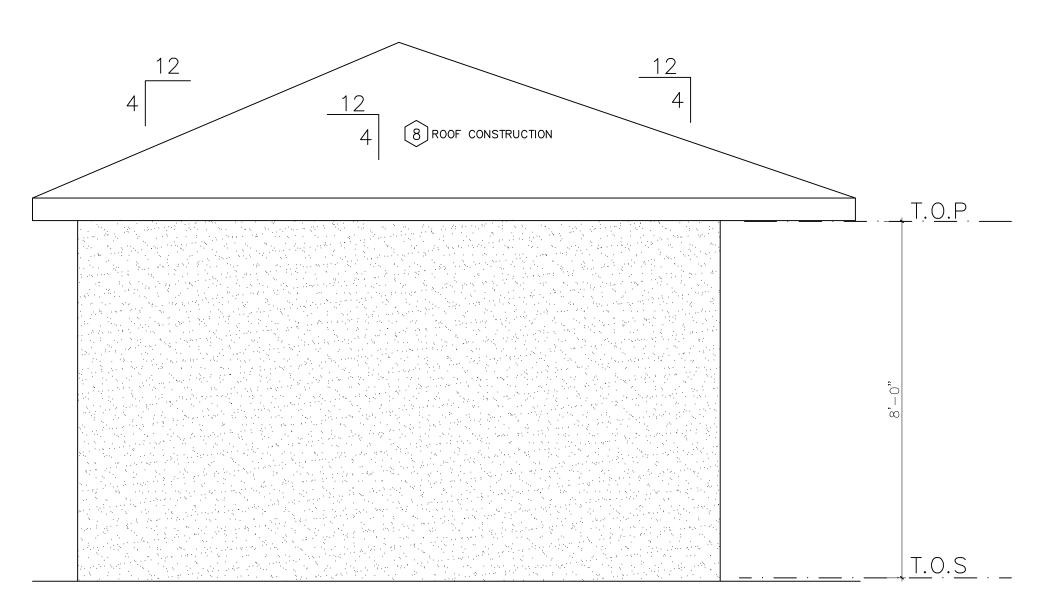

### **LEFT AND RIGHT ELEVATION**




### Structural Engineering

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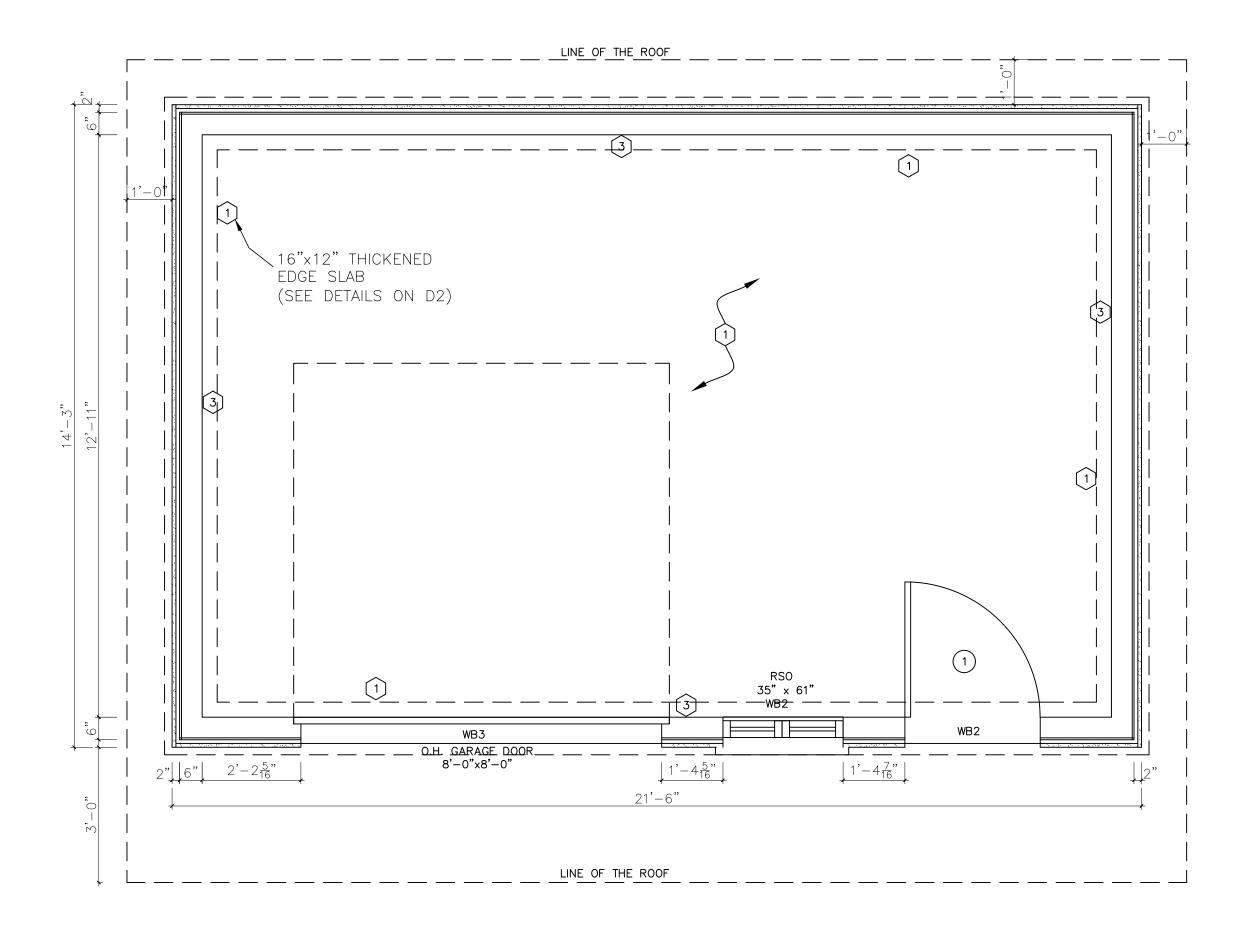
DRAWING TITLE:

**ELEVATIONS** 

PROJECT NO: SCALE:

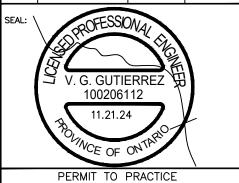DRAWN BY:

N.T.S.



### **PLAN VIEW**




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PROJECT:

CUSTOM "AS BUILT" SHED


DRAWING TITLE:

FLOOR PLAN

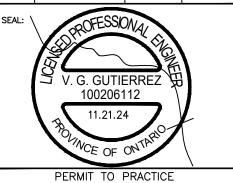PROJECT NO: DRAWING NO:

SCALE: N.T.S.

DRAWN BY:

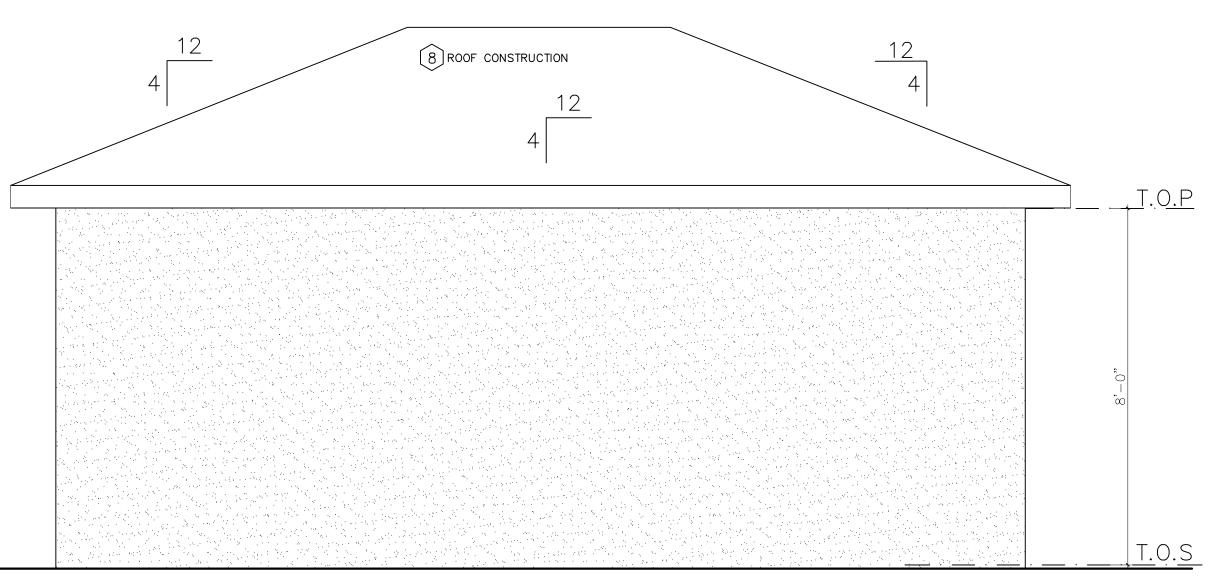

### **REAR ELEVATION**




### Structural Engineering

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LOCATION:

246 SYLVADENE PARKWAY VAUGHAN. ON.

PROJECT:

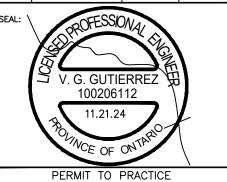
CUSTOM "AS BUILT" SHED

DRAWING TITLE:

ROOF PLAN

PROJECT NO:

SCALE: N.T.S. DRAWN BY:

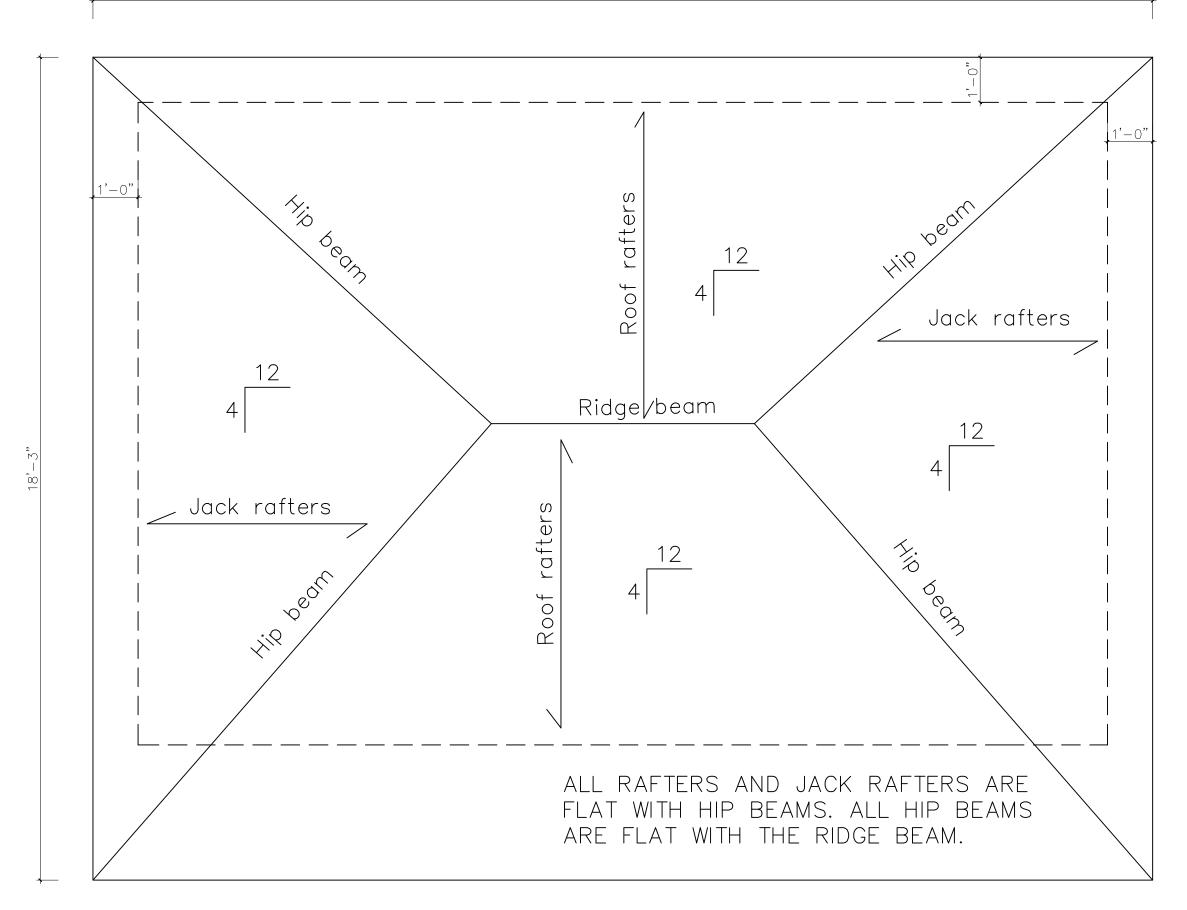






### Structural Engineering

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246 SYLVADENE PARKWAY VAUGHAN. ON.

PROJECT:

CUSTOM "AS BUILT" SHED

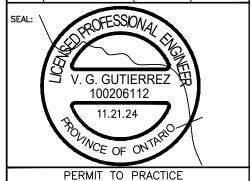DRAWING TITLE:

SCALE:


ROOF PLAN

N.T.S.

PROJECT NO: DRAWING NO:

DRAWN BY: C.C.

A5

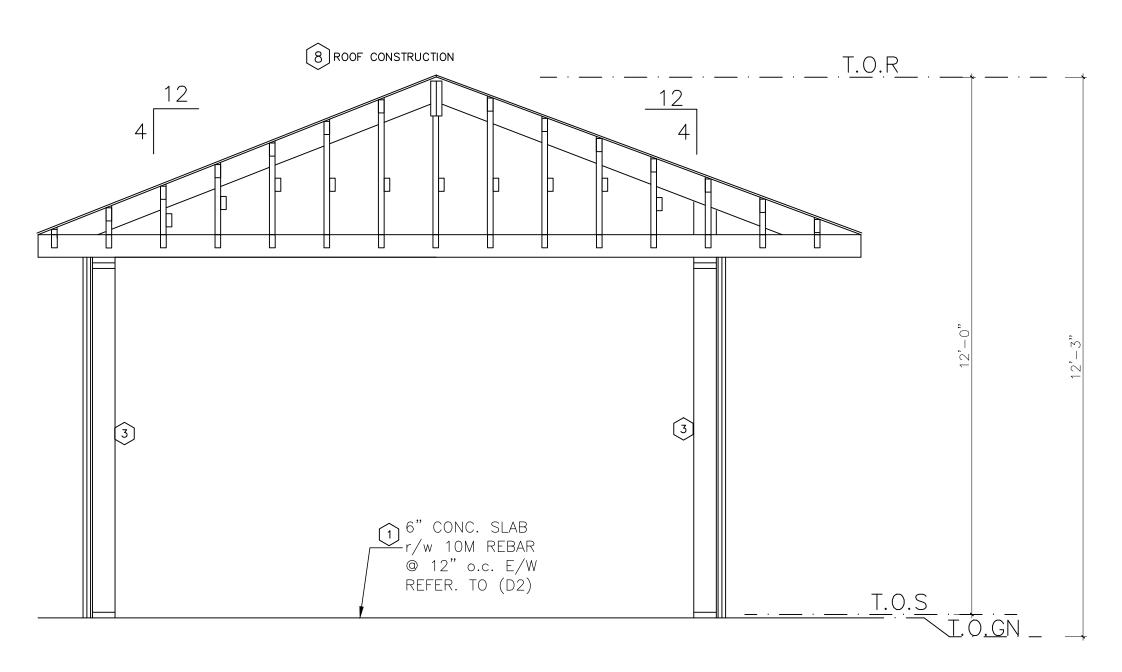

### **BUILDING SECTION**

ALL RAFTERS AND JACK RAFTERS ARE FLAT WITH HIP BEAMS. ALL HIP BEAMS ARE FLAT WITH THE RIDGE BEAM.

#### WORK PROCEDURES

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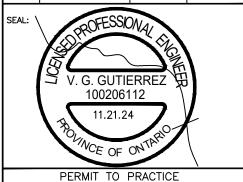


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DRAWING TITLE:

SCALE:


SECTIONS

PROJECT NO: DRAWING N

N.T.S.

DRAWN BY: G.G.

 $\mathcal{A}_{\mathcal{A}}$ 

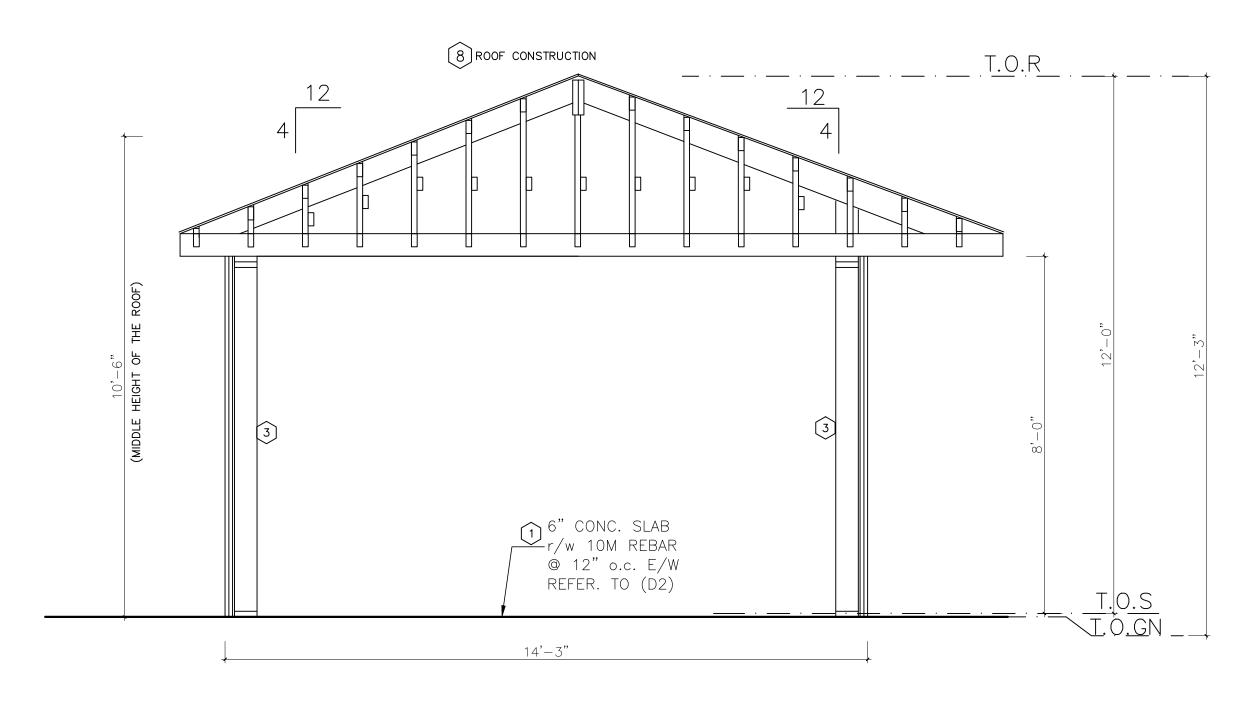

### **BUILDING SECTION**

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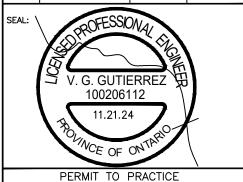


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PROJECT:

CUSTOM "AS BUILT" SHED

DRAWING TITLE:

SCALE:

SECTIONS

PROJECT NO: DRAWING N

N.T.S.

DRAWN BY: G.G.

AI

# SCHEDULE B: COMMENTS FROM AGENCIES, BUILDING STANDARDS & DEVELOPMENT PLANNING

Internal Departments *Comments Received	Conditions Required		Nature of Comments	
Building Standards (Zoning)	Yes □	No ⊠	General Comments	
Development Planning	Yes □	No ⊠	Recommend Approval/No Conditions	

External Agencies *Comments Received	Conditions Required		Nature of Comments *See Schedule B for full comments	
Alectra	Yes □	No ⊠	General Comments	
Region of York	Yes □	No ⊠	General Comments	
TRCA	Yes □	No ⊠	General Comments	



Date: December 23<sup>rd</sup> 2024

Attention: Christine Vigneault

**RE:** Request for Comments

File No.:

Related Files: A158-24

**Applicant:** 2G Engineering

**Location** 246 Sylvadene Parkway



#### **COMMENTS:**

	We have reviewed the proposed Variance Application and have no comments or objections to its approval.
X	We have reviewed the proposed Variance Application and have no objections to its approval, subject to the following comments (attached below).
	We have reviewed the proposed Variance Application and have the following concerns (attached below).

Alectra Utilities (formerly PowerStream) has received and reviewed the proposed Variance Application. This review, however, does not imply any approval of the project or plan.

All proposed billboards, signs, and other structures associated with the project or plan must maintain minimum clearances to the existing overhead or underground electrical distribution system as specified by the applicable standards, codes and acts referenced.

In the event that construction commences, and the clearance between any component of the work/structure and the adjacent existing overhead and underground electrical distribution system violates the Occupational Health and Safety Act, the customer will be responsible for 100% of the costs associated with Alectra making the work area safe. All construction work will be required to stop until the safe limits of approach can be established.

In the event construction is completed, and the clearance between the constructed structure and the adjacent existing overhead and underground electrical distribution system violates the any of applicable standards, acts or codes referenced, the customer will be responsible for 100% of Alectra's cost for any relocation work.

#### References:

- Ontario Electrical Safety Code, latest edition (Clearance of Conductors from Buildings)
- Ontario Health and Safety Act, latest edition (Construction Protection)
- Ontario Building Code, latest edition (Clearance to Buildings)
- PowerStream (Construction Standard 03-1, 03-4), attached
- Canadian Standards Association, latest edition (Basic Clearances)

If more information is required, please contact either of the following:

Mr. Stephen Cranley, C.E.T

Supervisor, Distribution Design, ICI & Layouts (North)

**Phone**: 1-877-963-6900 ext. 31297

**E-mail**: stephen.cranley@alectrautilities.com

Mitchell Penner

Supervisor, Distribution Design-Subdivisions

**Phone**: 416-302-6215

Email: Mitchell.Penner@alectrautilities.com




Power Stream 1

### Construction Standard

03-1

	SYSTEM VOLTAGE				
LOCATION OF WIRES, CABLES OR CONDUCTORS	SPAN GUYS AND COMMUNICATIONS WIRES		4.16/2.4kV TO 27.6/16kV (SEE NOTE 1)	44kV	
	MINIMUM VERTICAL CLEARANCES (SEE NOTE 2)				
OVER OR ALONGSIDE ROADS, DRIVEWAYS OR LANDS ACCESSIBLE TO <u>VEHICLES</u>	442cm	442cm	480cm	520cm	
OVER GROUND ACCESSIBLE TO PEDESTRIANS AND BICYCLES ONLY	250cm	310cm	340cm	370cm	
ABOVE TOP OF RAIL AT RAILWAY CROSSINGS	730cm	730cm	760cm	810cm	

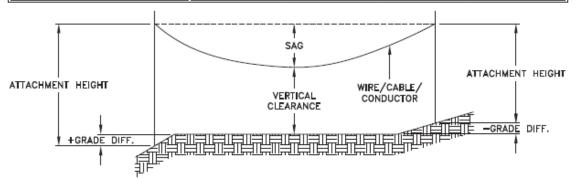

MINIMUM ATTACHMENT HEIGHT = MAXIMUM SAG

- + MINIMUM VERTICAL CLEARANCE (FROM ABOVE TABLE)
  ± GRADE DIFFERENCE

- + 0.3m (VEHICLE OR RAILWAY LOCATION) + SNOW DEPTH (PEDESTRIAN LOCATION, SEE NOTE 3)

### NOTES:

- THE MULTIGROUNDED SYSTEM NEUTRAL HAS THE SAME CLEARANCE AS THE 600V SYSTEM.
- 2. THE VERTICAL CLEARANCES IN THE ABOVE TABLE ARE UNDER  $\underline{\text{MAXIMUM SAG}}$  CONDITIONS.
- 3. REFER TO CSA STANDARD C22.3 No.1, ANNEX D FOR LOCAL SNOW DEPTH
- 4. ALL CLEARANCES ARE IN ACCORDANCE TO CSA STANDARD C22.3.

<u>\G</u>	340cm	11'-4"			
	310cm	10'-4"			
VALUES.	250cm	8'-4"			
VALUES.					
REFERENCES					
SAGS AND TENSIONS SECTION OF					

METRIC

810cm

760cm 730cm

520cm 480cm

442cm 370cm

CONVERSION TABLE

IMPERIAL (APPROX)

27'-0" 25'-4"

24'-4" 17'-4"

15'-5" 12'-4"

### MINIMUM VERTICAL CLEARANCES OF WIRES, CABLES AND CONDUCTORS ABOVE GROUND OR RAILS


ORIGINAL ISSUE DATE: 2010-DEC-24 REVISION NO: R1 REVISION DATE: 2012-JAN-09


Certificate of Approval This construction Standard meets the safety requirements of Section 4 of Regulation 22/04		
Joe Crozier, P.Eng. 2012-JAN-09 Name Date		
P Fng. Approval By:	Ine Crozier	



### Construction Standard

03 - 4

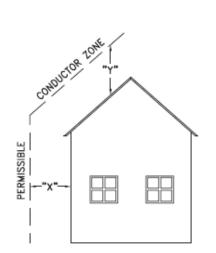

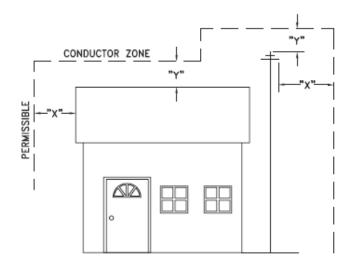

VOLTAGE	MINIMUM HORIZONTAL CLEARNACE UNDER MAXIMUM SWING CONDITIONS DIMENSION "X" (SEE NOTES 1, 3 & 4)	MINIMUM VERTICAL CLEARANCE UNDER MAXIMUM DESIGN SAG CONDITIONS DIMENSION "Y" (SEE NOTES 1, 2, 4 & 5)
0-600V AND NEUTRAL	100cm	250cm
4.16/2.4 TO 44kV	300cm	480cm

#### NOTES

- UNDER NO CIRCUMSTANCES SHALL A CONDUCTOR BE PERMITTED TO PENETRATE THE ENVELOPE SHOWN BY THE DOTTED LINE.
- 2. THE VERTICAL CLEARANCES ARE UNDER CONDITIONS OF MAXIMUM DESIGN SAG.
- THE HORIZONTAL CLEARANCES ARE UNDER CONDITIONS OF MAXIMUM SWING. WHERE THE CONDUCTOR SWING IS NOT KNOWN A HORIZONTAL CLEARANCE OF 480CM SHALL BE USED.
- 4. BUILDINGS THAT EXCEED 3 STOREYS OR 15M IN HEIGHT, THE MINIMUM HORIZONTAL CLEARANCE OF THE SECONDARY CONDUCTORS SHOULD BE INCREASED TO 300cm WHERE IT IS NECESSARY TO ALLOW FOR THE RAISING OF LADDERS BY LOCAL FIRE DEPARTMENTS.
- IN SITUATIONS SUCH AS MULTI-LEVEL GARAGES, WHERE ROOFS ARE NORMALLY USED BY PERSONS AND VEHICLES, THE VERTICAL CLEARANCES OF POWERSTREAM STANDARD 03-1 SHALL APPLY.
- 6. DISTRIBUTION LINES CONSTRUCTED NEAR BUILDINGS SHALL BE BUILT TO AVOID OVERHANG WHEREVER POSSIBLE. WHERE LINES MUST BE CONSTRUCTED OVER OR ADJACENT TO BUILDINGS THE APPLICABLE HORIZONTAL AND VERTICAL CLEARANCES SHALL BE AT CONDITIONS OF MAXIMUM CONDUCTOR SWING AND MAXIMUM SAG. THE ABOVE CLEARANCES ARE DESIGNED TO PREVENT PERSONS ON OR IN BUILDINGS AS WELL AS EXTERNAL MACHINERY USED IN CONJUCTION WITH A BUILDING TO COME IN CONTACT WITH CONDUCTORS. EFFORTS SHOULD BE MADE TO INCREASE THESE CLEARANCES WHERE POSSIBLE.
- 7. ALL CLEARANCES ARE IN ACCORDANCE TO CSA C22.3 NO.1-06 (TABLE-9).

CONVERSION TABLE			
IMPERIAL			
(APPROX)			
16'-0"			
10'-0"			
8'-4"			
3'-4"			

### MINIMUM VERTICAL & HORIZONTAL CLEARANCES OF CONDUCTORS FROM BUILDINGS OR OTHER PERMANENT STRUCTURES (CONDUCTORS NOT ATTACHED TO BUILDINGS)

ORIGINAL ISSUE DATE: 2010—MAY—05 REVISION NO: REVISION DATE:
PEgystem Planning and Standards/Standard Design/PowerStream Standards/working (abbr/Scellan 3/3-4/c/wg d3-4 Ro May 5, 2010, s/wg, 3/3/2010 8/2022 AM, Adobe POF



To: Committee of Adjustment

From: Sean Fitzpatrick, Building Standards Department

Date: December 20, 2024

**Applicant:** 2G Engineering

**Location:** 246 Sylvadene Parkway

PLAN RP5624 Lot 16

**File No.(s):** A158/24

#### **Zoning Classification:**

The subject lands are zoned R1C(EN) – First Density Residential Zone (Established Neighbourhood) under Zoning By-law 001-2021, as amended.

#	Zoning By-law 001-2021	Variance requested
1	The maximum height of a residential accessory structure shall be 3.0 m. [4.14]	To permit a maximum height of 3.2 metres for a residential accessory structure (stucco shed).
2	The maximum height of a residential accessory structure shall be 3.0 m. [4.14]	To permit a maximum height of 4.07 metres for a residential accessory structure (gazebo).

#### **Staff Comments:**

#### Stop Work Order(s) and Order(s) to Comply:

Order No. 24-118053, Order to Comply for , Issue Date: Jun 05, 2024

### **Building Permit(s) Issued:**

Building Permit No. 04-000947 for Single Detached Dwelling - New, Issue Date: Sep 09, 2004 Building Permit No. 24-123196 for Shed/Gazebo - New, Issue Date: (Not Yet Issued)

### **Other Comments:**

## General Comments The applicant shall be advised that additional variances may be required upon review of detailed drawing for building permit/site plan approval.

### **Conditions of Approval:**

If the committee finds merit in the application, the following conditions of approval are recommended.

<sup>\*</sup> Comments are based on the review of documentation supplied with this application.

From: Brett Rutledge

To: <u>Committee of Adjustment Mailbox</u>

**Subject:** A158/24 Vaughan - Parks - Complete No Conditions (Matthew Ka)

**Date:** Thursday, January 2, 2025 1:59:19 PM

Please note that Vaughan - Parks process is now complete for a COA folder with the following details:

File No: A158/24

Type: Minor Variance - Minor Type 1

Address: 246 Sylvadene Pkwy

Comments:

Conditions:





To: Christine Vigneault, Committee of Adjustment Secretary Treasurer

From: Nancy Tuckett, Director of Development and Parks Planning

Date: January 21, 2025

Name of Owner: Anthony Tersigni

**Location:** 246 Sylvadene Parkway

File No.(s): A158/24

#### **Proposed Variance(s):**

1. To permit a maximum height of 3.2 m for a residential accessory structure (shed).

2. To permit a maximum height of **4.07 m** for a residential accessory structure (gazebo).

#### By-Law 001-2021 Requirement(s):

- 1. The maximum height of a residential accessory structure shall be 3.0 m.
- 2. The maximum height of a residential accessory structure shall be **3.0 m**.

#### Official Plan:

Vaughan Official Plan 2010 ('VOP 2010'): "Low-Rise Residential"

#### Comments:

The Owner is seeking relief to permit two residential accessory structures in the rear yard with the above-noted variances.

The Development and Parks Planning Department has no objections to Variance 1 to increase the maximum permitted height of the existing shed from 3.0 m to 3.2 m. The proposed shed has a hipped roof and is compliant with setback and lot coverage requirements. The requested variance is minor in nature and is not anticipated to incur negative massing impacts on the neighbouring properties.

The Development and Parks Planning Department has no objections to Variance 2 to increase the maximum permitted height of the proposed gazebo from 3.0 m to 4.07 m. The proposed gazebo has a sloped roof and is unenclosed. The proposed gazebo has a modest footprint and is appropriately set back from the north and south side lot lines. The proposed gazebo is therefore not anticipated to negatively impact neighbouring properties.

Accordingly, the Development and Parks Planning Department supports the requested variances and is of the opinion that the proposal is minor in nature, maintains the general intent and purpose of the Official Plan and Zoning By-law, and is desirable for the appropriate development of the land.

#### Recommendation:

The Development and Parks Planning Department recommends approval of the application.

#### **Conditions of Approval:**

If the Committee finds merit in the application, the following conditions of approval are recommended:

None

### Comments Prepared by:

Harry Zhao, Planner 1 Janany Nagulan, Senior Planner From: <u>Cameron McDonald</u>

To: <u>Committee of Adjustment Mailbox</u>

**Subject:** [External] RE: A158/24 - REQUEST FOR COMMENTS, CITY OF VAUGHAN

**Date:** Monday, January 6, 2025 11:28:37 AM

Attachments: <u>image001.png</u>

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Hello,

Based on a review of our screening mapping, I can confirm that the subject property is not located within TRCA's Regulated Area. As such, any site alteration or development on the property would not require a permit from the TRCA.

Based on the above, we have no comments/requirements.

Regards,

#### **Cameron McDonald**

Planner I

Development Planning and Permits | Development and Engineering Services

T: (437) 880-1925

E: cameron.mcdonald@trca.ca

A: 101 Exchange Avenue, Vaughan, ON, L4K 5R6 | trca.ca



From: <u>Development Services</u>

To: <u>Committee of Adjustment Mailbox</u>

**Subject:** [External] RE: A158/24 - REQUEST FOR COMMENTS, CITY OF VAUGHAN

**Date:** Monday, January 6, 2025 8:48:24 AM

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#### Good morning,

The Regional Municipality of York has completed its review of the above minor variance application and has no comment.

Regards,

#### Gabrielle

**Gabrielle Hurst MCIP, RPP**| Associate Planner, Development Planning, Economic and Development Services Branch | The Regional Municipality of York | 1-877 464 9675 ext 71538 | gabrielle.hurst@york.ca | www.york.ca

### SCHEDULE C: PUBLIC & APPLICANT CORRESPONDENCE

(	Correspondence Type	Name	Address	Date Received (mm/dd/yyyy)	Summary
No	one				

### **SCHEDULE D: BACKGROUND**

••	Application Description (i.e. Minor Variance Application; Approved by COA / OLT)
N/A	N/A