ITEM: 6.9

REPORT SUMMARY MINOR VARIANCE APPLICATION FILE NUMBER A111/24

Report Date: August 16, 2024

THIS REPORT CONTAINS COMMENTS FROM THE FOLLOWING DEPARTMENTS & AGENCIES (SEE SCHEDULE B):

Additional comments from departments and agencies received after the publication of the report will be made available on the City's <u>website</u>.

Internal Departments *Comments Received	Conditions Required		Nature of Comments
Building Standards (Zoning) *See Schedule B	Yes □	No ⊠	General Comments
Committee of Adjustment	Yes □	No ⊠	General Comments
Development Planning	Yes ⊠	No □	General Comments w/Conditions
Development Engineering	Yes □	No ⊠	Recommend Approval/No Conditions
Development Finance	Yes □	No ⊠	General Comments
By-law & Compliance	Yes □	No ⊠	General Comments
Forestry	Yes ⊠	No □	General Comments w/Conditions

External Agencies *Comments Received	Conditions Required		Nature of Comments *See Schedule B for full comments
Alectra	Yes □	No ⊠	General Comments
Region of York	Yes □	No ⊠	General Comments
TRCA	Yes □	No ⊠	General Comments

PUBLIC & APPLICANT CORRESPONDENCE (SEE SCHEDULE C)

All personal information collected because of this public meeting (including both written and oral submissions) is collected under the authority of the Municipal Act, the Municipal Freedom of Information and Protection of Privacy Act (MFIPPA), the Planning Act and all other relevant legislation, and will be used to assist in deciding on this matter. All personal information (as defined by MFIPPA), including (but not limited to) names, addresses, opinions and comments collected will become property of the City of Vaughan, will be made available for public disclosure (including being posted on the internet) and will be used to assist the Committee of Adjustment and staff to process this application.

Correspondence Type	Name	Address	Date Received (mm/dd/yyyy)	Summary
Applicant			07/30/2024	Application Cover Letter

BACKGROUND (SCHEDULE D, IF REQUIRED)	
* Background Information contains historical development approvals considered to be related to this file.	
This information should not be considered comprehensive.	
Application No. (City File) Application Description	
	(i.e. Minor Variance Application; Approved by COA / OLT)
N/A	N/A

ADJOURNMENT HISTORY		
* Previous hearing dates where this application was adjourned by the Committee and public notice issued.		
Hearing Date		Reason for Adjournment (to be obtained from NOD_ADJ)
N/A N/A		

SCHEDULES		
Schedule A	Drawings & Plans Submitted with the Application	
Schedule B	Comments from Agencies, Building Standards & Development Planning	
Schedule C (if required)	Public & Applicant Correspondence	
Schedule D (if required)	Background	



MINOR VARIANCE APPLICATION FILE NUMBER A111/24

CITY WARD #:	2
APPLICANT:	Ncap Nicola (Hwy 27) Ltd.
AGENT:	Weston Consulting
PROPERTY:	7242 Hwy 27, Vaughan
ZONING DESIGNATION:	See below.
VAUGHAN OFFICIAL PLAN	Vaughan Official Plan 2010 ('VOP 2010'): "Prestige Employment" by
(2010) DESIGNATION:	Schedule 13 – Land Use and subject to Site-Specific Policy 13.3.
RELATED DEVELOPMENT	DA.24.020.
APPLICATIONS:	
PROPOSAL:	Relief from the Zoning By-law is being requested to permit a proposed
	retaining wall and to facilitate related Site Plan Application DA.24.020.

The following variances are being requested from the City's Zoning By-law to accommodate the above proposal:

The subject lands are zoned EM1(H) Prestige Employment Zone and subject to the provisions of Exception 14.1162 under Zoning By-law 001-2021, as amended.

#	Zoning By-law 001-2021	Variance requested
1	The minimum setback of any building or structure	
	to an Open Space Zone shall be 11.0m.	from the OS lands to the retaining wall.
	Exception 14.1162	
2	A retaining wall shall be setback an equal distance	To permit a retaining wall with a maximum
	to the height of the highest portion of the retaining	height of 1.6m to be setback a minimum of
	wall. The minimum setback is 1.60m.	0.30 metres from the rear lot line.
	Section 4.13	

HEARING INFORMATION

DATE OF MEETING: Thursday, August 22, 2024

TIME: 6:00 p.m.

MEETING LOCATION: Vaughan City Hall, Woodbridge Room (2nd Floor), 2141 Major Mackenzie Drive

LIVE STREAM LINK: Vaughan.ca/LiveCouncil

PUBLIC PARTICIPATION

If you would like to speak to the Committee of Adjustment at the meeting, either remotely or in person, please complete the **Request to Speak Form** and submit to **cofa@vaughan.ca**

If you would like to submit written comments, please quote file number above and submit by mail or email to:

Email: cofa@vaughan.ca

Mail: City of Vaughan, Office of the City Clerk, Committee of Adjustment, 2141 Major Mackenzie Drive, Vaughan, ON, L6A 1T1

To speak electronically, pre-registration is required by completing the Request to Speak Form on-line and submitting it to cofa@vaughan.ca no later than NOON on the last business day before the meeting.

THE DEADLINE TO REGISTER TO SPEAK ELECTRONICALLY OR SUBMIT WRITTEN COMMENTS ON THE ABOVE NOTED FILE(S) IS <u>NOON</u> ON THE LAST BUSINESS DAY BEFORE THE MEETING.

memorandum



along the southern property line) due to the property's varying topography. The retaining wall along the western property line is proposed to have acoustic paneling on top. The retaining wall along the south lot line is proposed to have a guardrail on top. The 0.30 m minimum setback for the proposed retaining wall is measured along the entirety of the proposed retaining wall at both the western and southern property lines and provides sufficient space for safe access and maintenance if required. The Urban Design Department and Development Engineering Department have also reviewed the proposal and have no concerns with the retaining wall. As such, the retaining wall is not anticipated to have any adverse impacts to the neighbouring property and land use is desirable for the appropriate development of the land.

In support of the application, the Owner has submitted an Arborist Report & Tree Protection and Removal Plan prepared by P & A Urban Forestry Consulting Ltd., dated November 30, 2021, and updated on October 13, 2023. The report inventoried a total of four (4) trees, two (2) of which are proposed to be removed and two (2) to be preserved through construction. A total of two (2) replacement trees are proposed. Urban Design staff have reviewed the report and concur with its recommendations.

Accordingly, the Development Planning Department can support the requested variance and is of the opinion that the proposal is minor in nature, maintains the general intent and purpose of the Official Plan and Zoning By-law, and is desirable for the appropriate development of the land.

Recommendation:

The Development Planning Department recommends approval of the application with the following condition of approval:

Condition of Approval:

If the Committee finds merit in the application, the following condition of approval is recommended:

1. That all comments on Site Development Application File DA.23.035 be addressed to the satisfaction of the Development Planning Department.

Comments Prepared by:

Nicholas Del Prete, Planner David Harding, Senior Planner

INTRODUCTION

Staff and Agencies act as advisory bodies to the Committee of Adjustment. The comments contained in this report are presented as recommendations to the Committee.

Section 45(1) of the Planning Act sets the criteria for authorizing minor variances to the City of Vaughan's Zoning By-law. Accordingly, review of the application may consider the following:

That the general intent and purpose of the by-law will be maintained.

That the general intent and purpose of the official plan will be maintained.

That the requested variance(s) is/are acceptable for the appropriate development of the subject lands. That the requested variance(s) is/are minor in nature.

Public written and oral submissions relating to this application are taken into consideration by the Committee of Adjustment as part of its deliberations and final decision on this matter.

COMMITTEE OF ADJUSTMENT		
Date Public Notice Mailed:	August 8, 2024	
Date Applicant Confirmed Posting of Sign:	August 1, 2024	
Applicant Justification for Variances: *As provided in Application Form	The height of the proposed retaining wall for development is higher than the required setback to a lot line.	
Was a Zoning Review Waiver (ZRW) Form submitted by Applicant: *ZRW Form may be used by applicant in instances where a revised submission is made, and zoning staff do not have an opportunity to review and confirm variances prior to the issuance of public notice.	Yes □ No ⊠	
COMMENTS:		
None		
Committee of Adjustment Recommended Conditions of Approval:	None	

BUILDING STANDARDS (ZONING)	
**See Schedule B for Building Standards (Zoning) Comments	
Building Standards Recommended Conditions of Approval: None	

DEVELOPMENT PLANNING	
**See Schedule B for Development Planning Comments.	
Development Planning Recommended That all comments on Site Development Application File	
Conditions of Approval:	DA.23.035 be addressed to the satisfaction of the
	Development Planning Department.

DEVELOPMENT ENGINEERING Link to Grading Permit Link to Pool Permit Link to Curb Curt Permit Link Culvert Installation This Minor Variance application has a concurrent Site Plan Application (DA.24.020). Development Engineering Department has reviewed Minor Variance application A111/24 and has no concerns with the proposed retaining wall. Development Engineering Recommended Conditions of Approval:

PARKS, FORESTRY & HORTICULTURE (PFH)		
Recommended condition of approval:		
PFH Recommended Conditions of Approval:	Applicant/owner shall obtain a "Private Property Tree Removal & Protection" permit through the forestry division prior to any construction works on the subject property.	

	DEVELOPMENT FINANCE
No comment no concerns.	

DEVELOPMENT FINANCE Development Finance Recommended Conditions of Approval: None

BY-LAW AND COMPLIANCE, LICENSING AND PERMIT SERVICES				
No comments.				
BCLPS Recommended Conditions of Approval:	None			

BUILDING INSPECTION (SEPTIC)					
No comments received to date.					
Building Inspection Recommended Conditions of Approval:	None				

FIRE DEPARTMENT					
No comments received to date.					
Fire Department Recommended Conditions of Approval:	None				

RECOMMENDED CONDITIONS OF APPROVAL SUMMARY

Should the Committee find it appropriate to approve this application in accordance with request and the sketch submitted with the application, as required by Ontario Regulation 200/96, the following conditions have been recommended:

#	DEPARTMENT / AGENCY	CONDITION
1	Development Planning	That all comments on Site Development
	Nicholas.delprete@vaughan.ca	Application File DA.23.035 be
		addressed to the satisfaction of the
		Development Planning Department.
2	Parks, Forestry and Horticulture Operations	Applicant/owner shall obtain a "Private
	zachary.guizzetti@vaughan.ca	Property Tree Removal & Protection" permit
		through the forestry division prior to any
		construction works on the subject property.

All conditions of approval, unless otherwise stated, are considered to be incorporated into the approval "**if** required". If a condition is no longer required after an approval is final and binding, the condition may be waived by the respective department or agency requesting conditional approval. A condition cannot be waived without written consent from the respective department or agency.

IMPORTANT INFORMATION

CONDITIONS: It is the responsibility of the owner/applicant and/or authorized agent to obtain and provide a clearance letter from respective department and/or agency (see condition chart above for contact). This letter must be provided to the Secretary-Treasurer to be finalized. All conditions must be cleared prior to the issuance of a Building Permit.

APPROVALS: Making any changes to your proposal after a decision has been made may impact the validity of the Committee's decision.

An approval obtained from the Committee of Adjustment, where applicable, is tied to the building envelope shown on the plans and drawings submitted with the application and subject to the variance approval.

A building envelope is defined by the setbacks of the buildings and/or structures shown on the plans and drawings submitted with the application, as required by Ontario Regulation 200/96. Future development outside of an approved building envelope, where a minor variance was obtained, must comply with the provisions of the City's Zoning By-law.

Elevation drawings are provided to reflect the style of roof (i.e. flat, mansard, gable etc.) to which a building height variance has been applied. Where a height variance is approved, building height is applied to the style of roof (as defined in the City's Zoning By-law) shown on the elevation plans submitted with the application.

Architectural design features that are not regulated by the City's Zoning By-law are not to be considered part of an approval unless specified in the Committee's decision.

IMPORTANT INFORMATION

DEVELOPMENT CHARGES: That the payment of the Regional Development Charge, if required, is payable to the City of Vaughan before issuance of a building permit in accordance with the Development Charges Act and the Regional Development Charges By-law in effect at the time of payment.

That the payment of the City Development Charge, if required, is payable to the City of Vaughan before issuance of a building permit in accordance with the Development Charges Act and the City's Development Charges By-law in effect at the time of payment.

That the payment of the Education Development Charge if required, is payable to the City of Vaughan before issuance of a building permit in accordance with the Development Charges Act and the Boards of Education By-laws in effect at the time of payment


That the payment of Special Area Development charge, if required, is payable to the City of Vaughan before issuance of a building permit in accordance with the Development Charges Act and The City's Development Charge By-law in effect at the time of Building permit issuance to the satisfaction of the Reserves/Capital Department.


NOTICE OF DECISION: If you wish to be notified of the decision in respect to this application or a related Ontario Land Tribunal (OLT) hearing you must complete a Request for Decision form and submit to the Secretary Treasurer (ask staff for details). In the absence of a written request to be notified of the Committee's decision you will **not** receive notice.


SCHEDULE A: DRAWINGS & PLANS




VAUGHAN Minor Variance Application A111/24

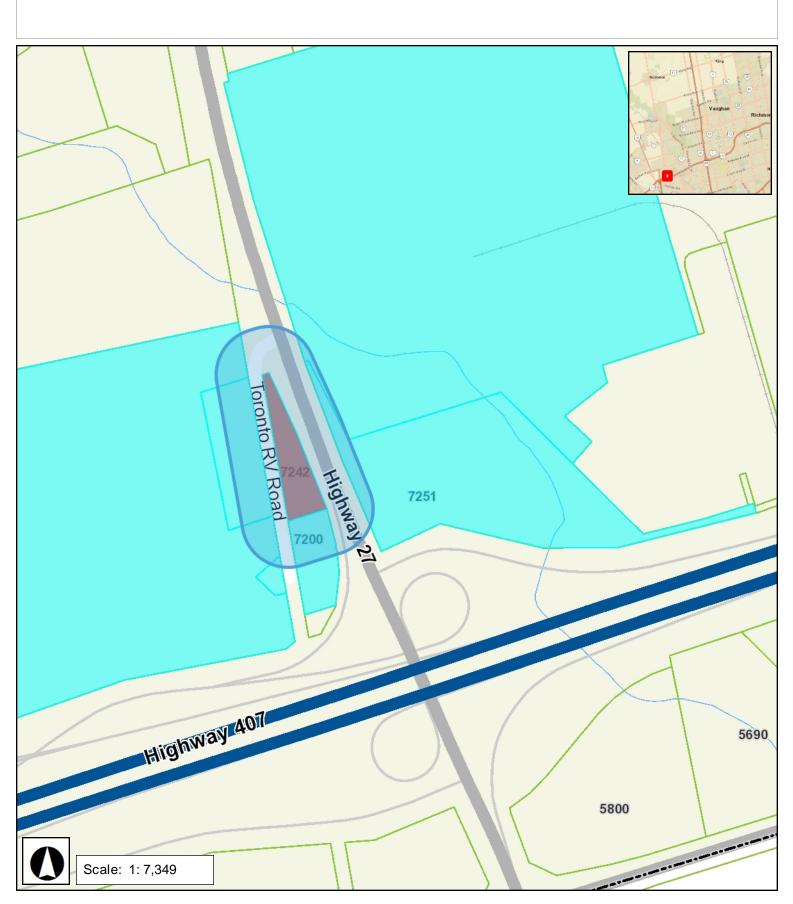

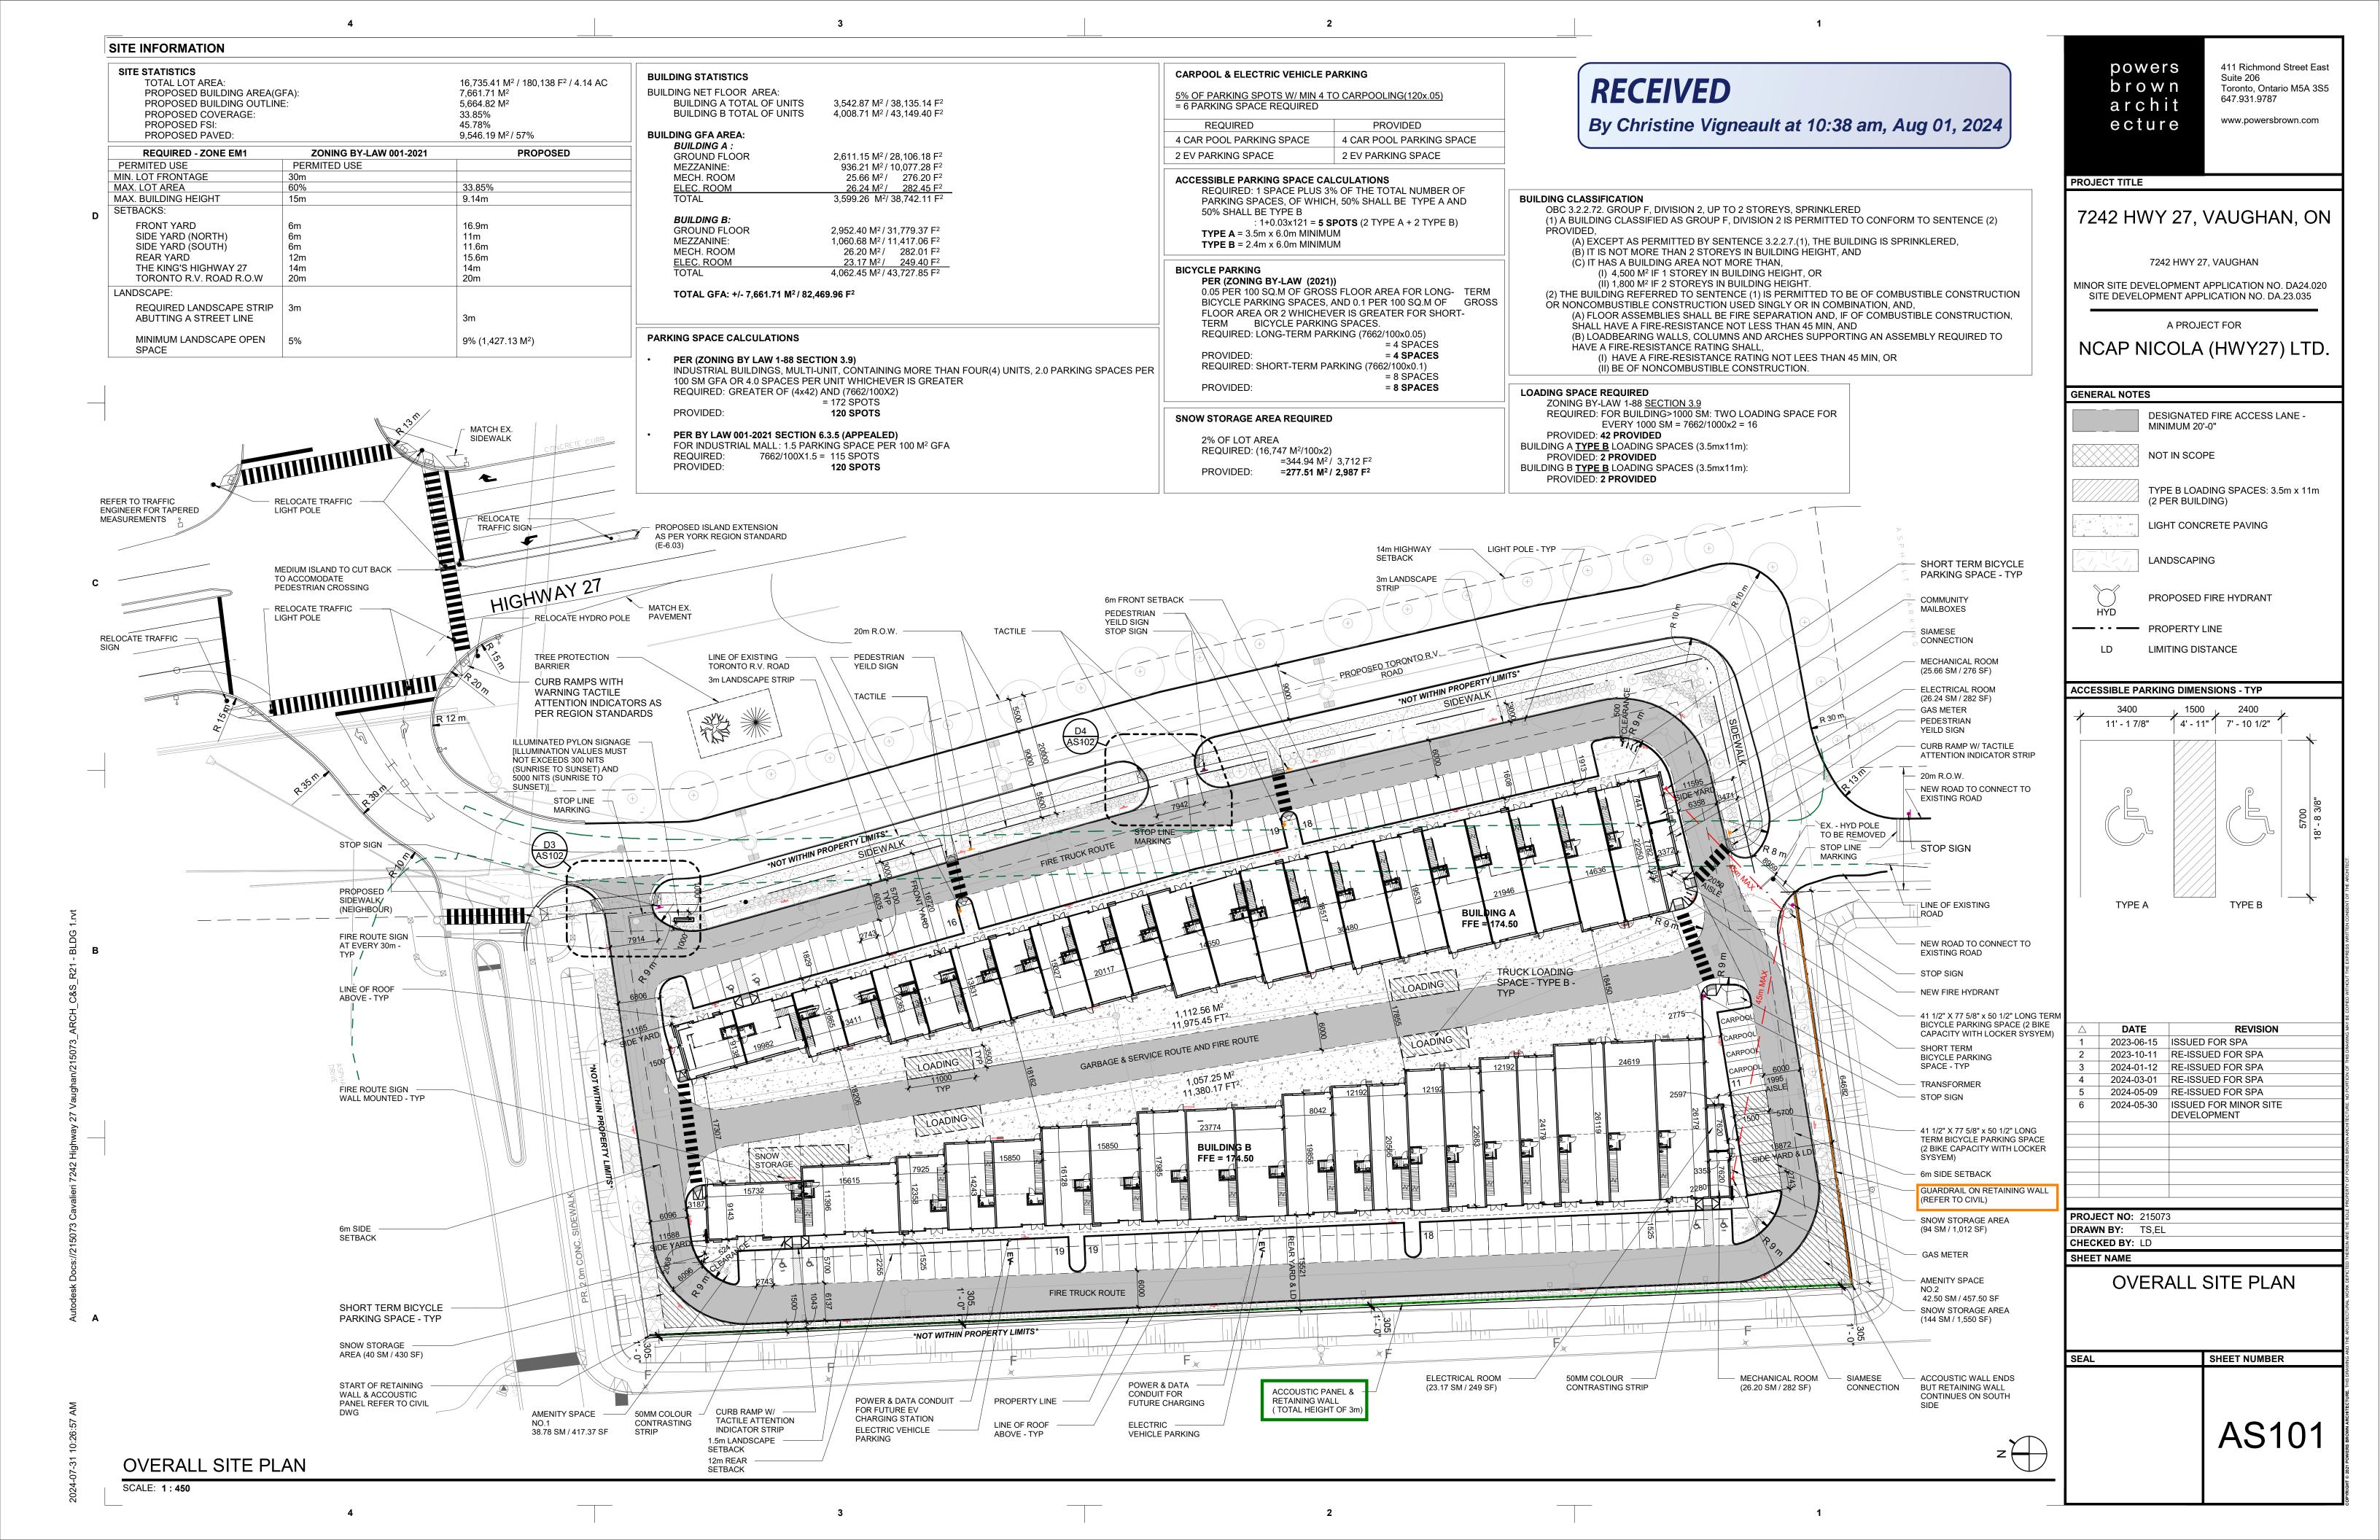

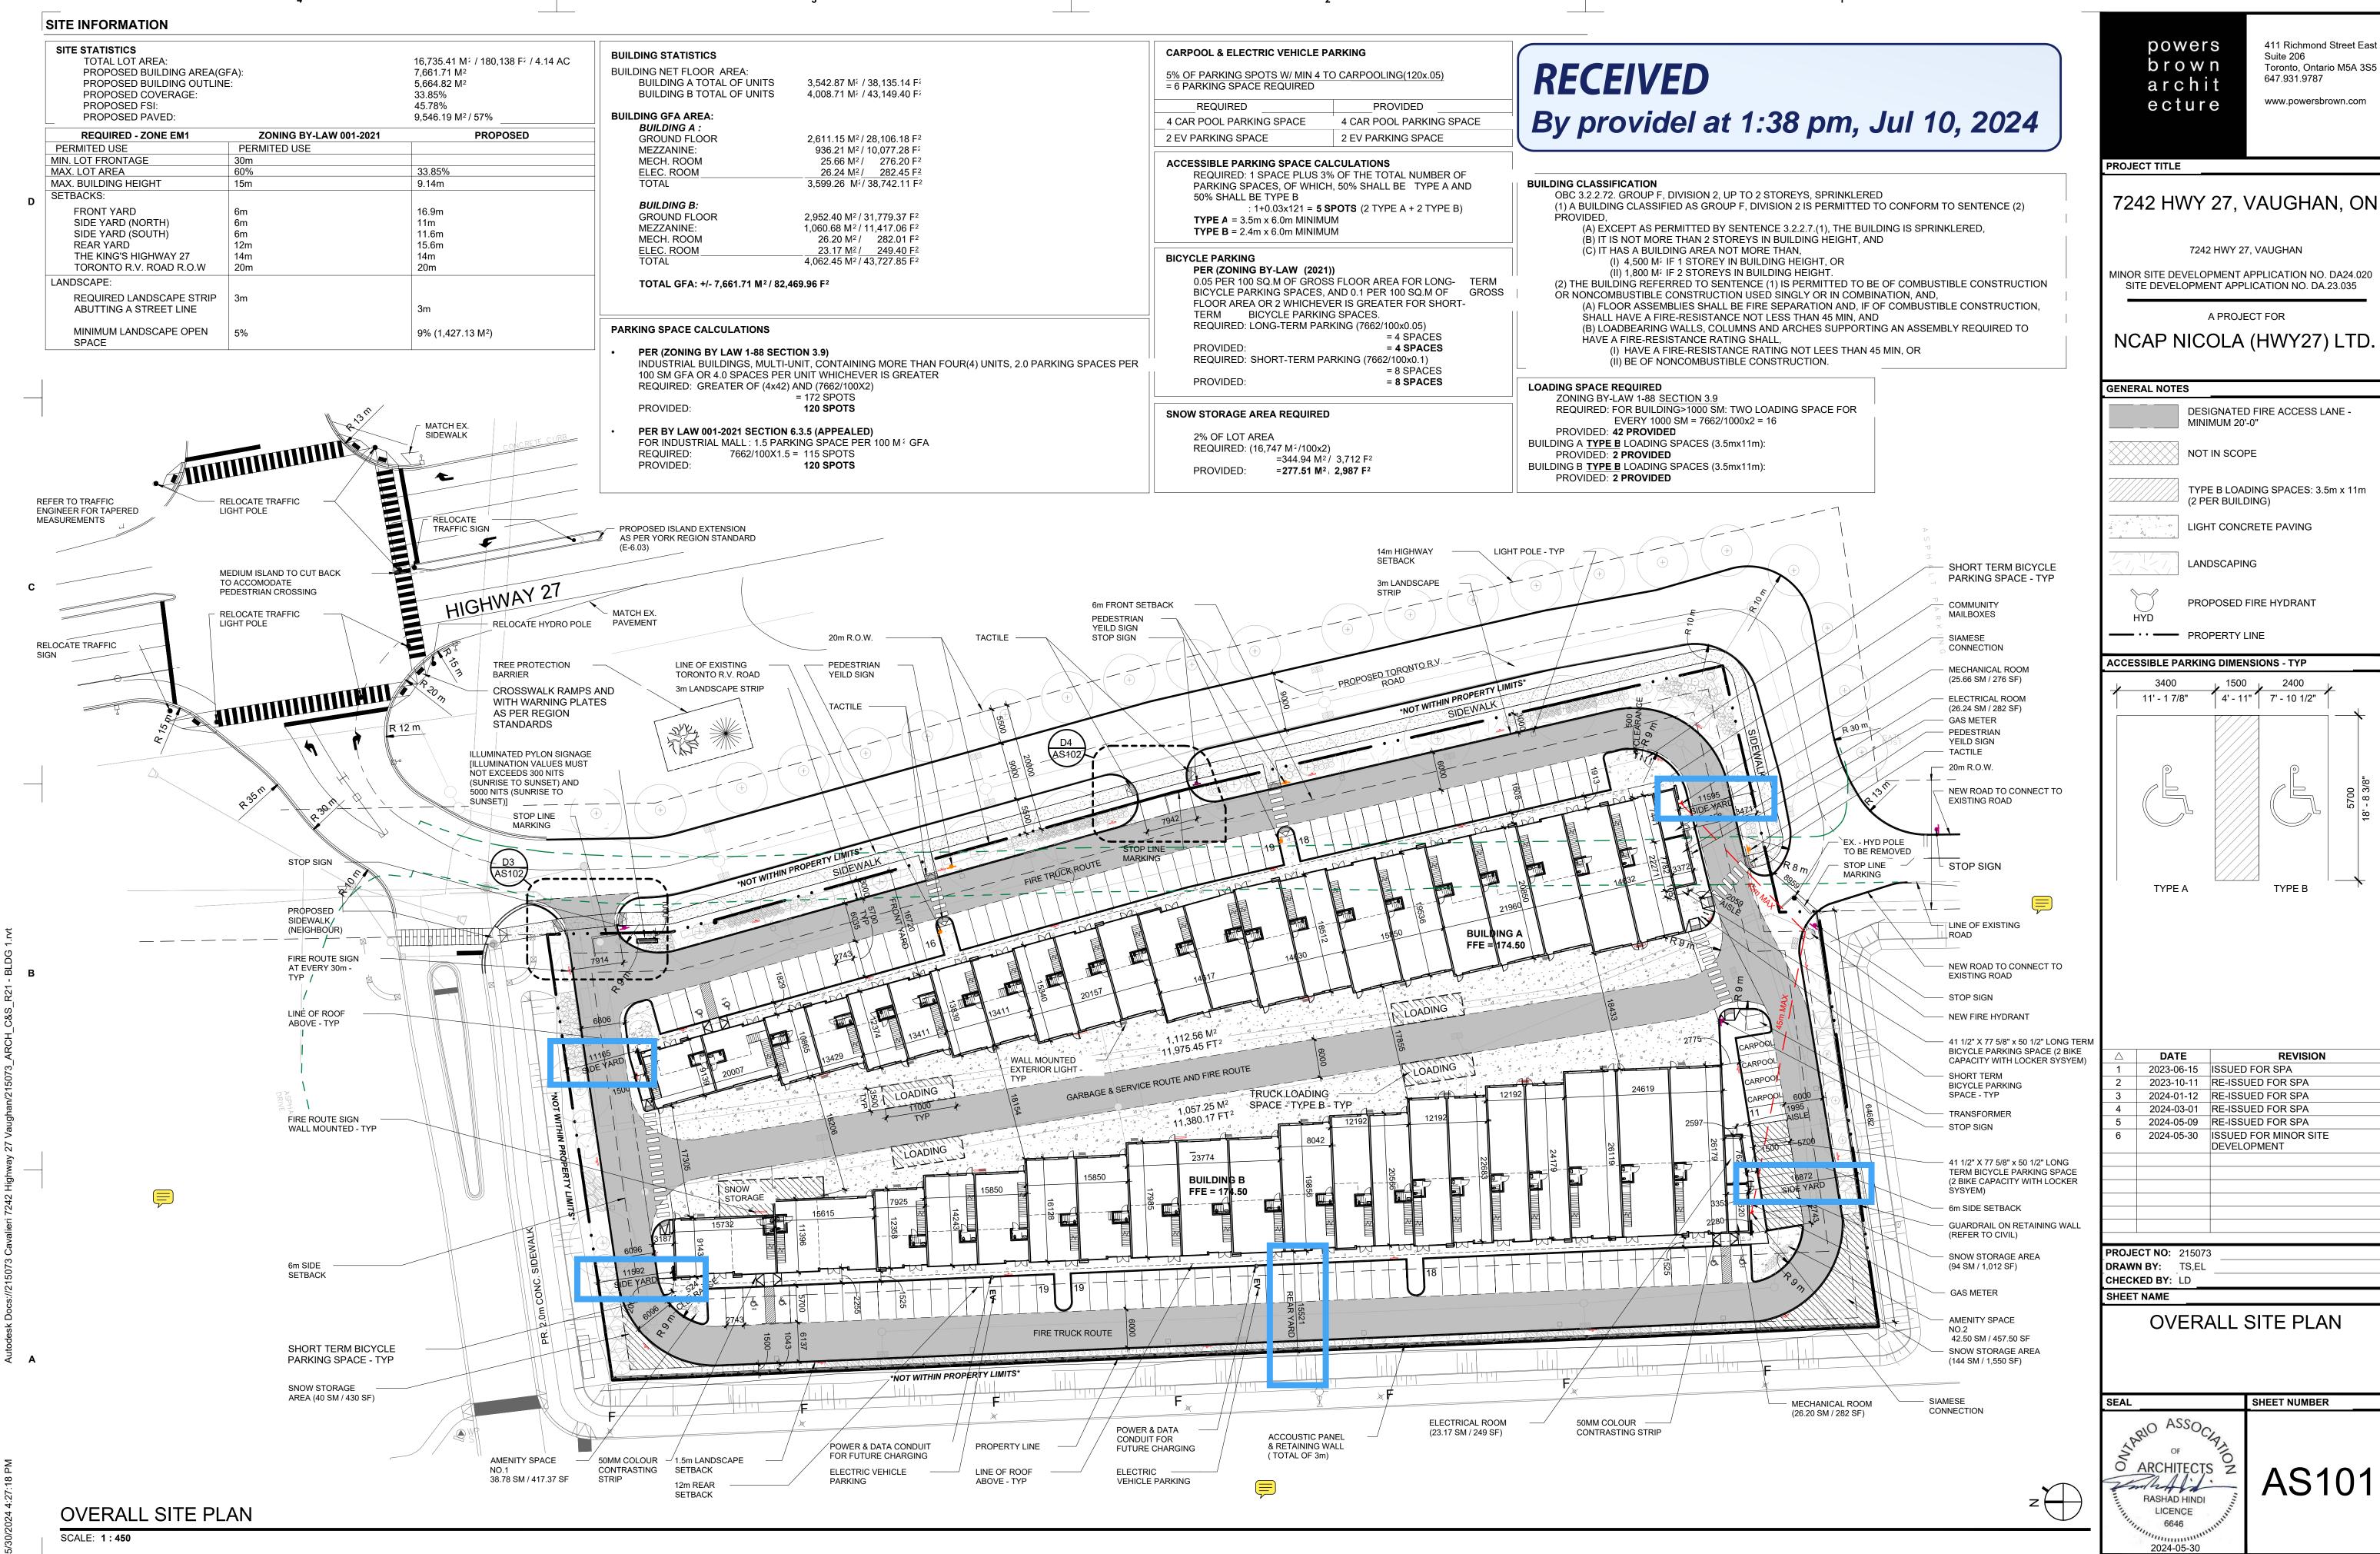

411 Richmond Street East Toronto, Ontario M5A 3S5

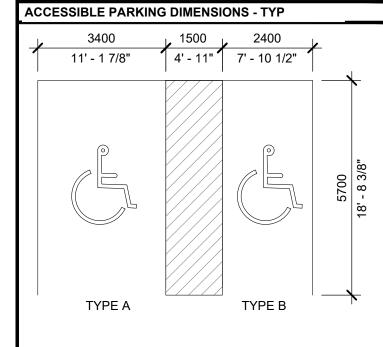

Δ	DATE	REVISION
1	2023-06-15	ISSUED FOR SPA
2	2023-10-11	RE-ISSUED FOR SPA
3	2024-01-12	RE-ISSUED FOR SPA
4	2024-03-01	RE-ISSUED FOR SPA
5	2024-05-09	RE-ISSUED FOR SPA
6	2024-05-30	ISSUED FOR MINOR SITE DEVELOPMENT



7242 HWY 27 - RETAINING WALL VAUGHAN, ONTARIO, CANADA

STRUCTURAL DRAWINGS LIST

DESCRIPTION	DRAWING NO.	SHEET NO.
STRUCTURAL COVER PAGE	S0.1	1
GENERAL NOTES AND SPECIFICATIONS	S0.2	2
SITE PLAN AND WALL DETAIL	S1.0	3
ACOUSTIC WALL PLAN AND DETAILS	S1.1	4



P: 780 244 0252 F: 780 800 2112 SUITE 1250, 10130 103 STREET, Edmonton, AB T5J 3N9 E: info@designworkseng.com www.designworkseng.com COPYRIGHT 2024 DESIGN WORKS ENGINEERING LTD.

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ENGINEERING & INSPECTIONS LTD.

NOTES.

THIS DRAWING IS NOT TO BE USED FOR CONSTRUCTION UNTIL SIGNED AND SEALED OR ADVISED IN WRITING BY THE ENGINEER.

DO NOT SCALE THIS DRAWING.

VERIFY ALL DIMENSIONS, DATUMS, AND LEVELS PRIOR TO COMMENCEMENT OF WORK. REPORT ANY DISCREPANCIES OR OMISSIONS TO THE DESIGNER IMMEDIATELY.

ALL WORK MUST COMPLY WITH THE MOST RECENT EDITION
OF THE APPLICABLE BUILDING CODE, AND ANY OTHER
GOVERNING AUTHORITY.

	GOVERNING AUTHORITY.	ANING AUTHURIT.			
No.	Description	Date			
1	ISSUED FOR REVIEW	2024-01-17			
2	ISSUED FOR MINOR SITE DEVELOPMENT	2024-05-30			



CLIE

DRAWN BY:	AR
CHECKED BY:	YJL
ENGINEER:	HOSSEIN MOHAMMADI
DATE:	2024-01-17
PROJECT #:	2021357
SCALE:	AS NOTED

PROJE

7242 HWY 27 -RETAINING WALL

VAUGHAN, ON, CANADA L4H 4Y8 MINOR SITE DEVELOPMENT APPLICATION NO. DA.24.020 SITE DEVELOPMENT APPLICATION NO. DA.23.035

DESCRIPTIO

STRUCTURAL COVER PAGE

DRAWING NO.

S0.1

1

GENERAL REQUIREMENTS

- 1. THESE DRAWINGS HAVE BEEN PREPARED USING STANDARDS OF PROFESSIONAL CARE AND COMPLETENESS NORMALLY EXERCISED UNDER SIMILAR CIRCUMSTANCES BY REPUTABLE STRUCTURAL ENGINEERS IN THIS OR SIMILAR LOCALITIES. THEY NECESSARILY ASSUME THAT THE WORK DEPICTED WILL BE PERFORMED BY AN EXPERIENCED CONTRACTOR AND/OR WORKERS WHO HAVE A WORKING KNOWLEDGE OF THE APPLICABLE CODE STANDARDS AND REQUIREMENTS AND OF INDUSTRY ACCEPTED STANDARD GOOD PRACTICE. AS NOT EVERY CONDITION OR ELEMENT IS (OR CAN BE) EXPLICITLY SHOWN ON THESE DRAWINGS, IT IS UNDERSTOOD THAT THE CONTRACTOR WILL USE INDUSTRY ACCEPTED STANDARD GOOD PRACTICE FOR ALL MISCELLANEOUS WORK NOT EXPLICITLY SHOWN.
- 2. DRAWING NOTES AND SPECIFICATIONS ARE INSTRUCTIONS TO THE CONTRACTOR AND APPLY GENERALLY TO ALL THE WORK UNLESS MORE SPECIFIC INFORMATION IS SHOWN ELSEWHERE ON THE DRAWINGS OR WRITTEN IN THE SPECIFICATIONS.
- 3. THESE DRAWINGS REPRESENT THE FINISHED STRUCTURE. THEY DO NOT INDICATE THE METHOD OF CONSTRUCTION. THE CONTRACTOR SHALL BE SOLELY RESPONSIBLE FOR CONSTRUCTION MEANS, METHODS, TECHNIQUES, SEQUENCES AND PROCEDURES. IT SHALL BE THE CONTRACTOR'S RESPONSIBILITY TO DESIGN AND PROVIDE ADEQUATE SHORING, BRACING, FORM-WORK, ETC... AS REQUIRED FOR THE PROTECTION OF LIFE AND PROPERTY (INCLUDING UTILITIES) DURING CONSTRUCTION. CONSTRUCTION MATERIALS SHALL BE PLACED ON THE STRUCTURE SUCH THAT THE DESIGN LOADS AS STATED HEREIN ARE NOT EXCEEDED.
- 4. DESIGN OF NON-PRIMARY STRUCTURAL ITEMS, SUCH AS STAIRS, RAILINGS, NON-STRUCTURAL WALLS AND PREFABRICATED STRUCTURAL ITEMS. SUCH AS FLOOR AND ROOF TRUSSES. ARE NOT INCLUDED AND ARE TO BE PROVIDED BY OTHERS UNLESS SPECIFICALLY NOTED ON THESE DRAWINGS.
- 5. TAKE DIMENSIONS TO CENTERS OF COLUMNS, BEAMS, PIERS, AND PILASTERS; FACES OF WALLS; AND TO EDGES OF OPENINGS UNLESS SHOWN OTHERWISE.
- 6. THE CONTRACTOR SHALL VERIFY ALL DIMENSIONS, CONDITIONS AND FLEVATIONS WITH ARCHITECTURAL AND STRUCTURAL DRAWINGS AND INFORM THE ARCHITECT OR ENGINEER IN WRITING OF ANY DISCREPANCIES OR OMISSIONS NOTED ON THE DRAWINGS. ANY SUCH DISCREPANCY, OMISSION, OR VARIATION NOT REPORTED BEFORE START OF CONSTRUCTION SHALL BE THE RESPONSIBILITY OF THE CONTRACTOR.
- 7. NOTES AND DETAILS ON DRAWINGS SHALL TAKE PRECEDENCE OVER GENERAL STRUCTURAL NOTES AND TYPICAL DETAILS.
- 8. CONTRACTOR SHALL ESTABLISH AND VERIFY ALL OPENINGS AND INSERTS FOR ARCHITECTURAL, MECHANICAL, PLUMBING AND ELECTRICAL WITH APPROPRIATE TRADES. DRAWINGS AND SUBCONTRACTORS PRIOR TO CONSTRUCTION.
- 9. WHERE REFERENCE IS MADE TO VARIOUS TEST STANDARDS FOR MATERIALS, SUCH STANDARDS SHALL BE THE EDITION REFERENCED IN THE GOVERNING BUILDING CODE.
- 10. TYPICAL DETAILS AND NOTES SHALL APPLY, THOUGH NOT NECESSARILY INDICATED AT A SPECIFIC LOCATION ON PLANS. WHERE NO DETAILS ARE SHOWN, CONSTRUCTION SHALL CONFORM TO SIMILAR WORK ON THE PROJECT. DETAILS MAY SHOW ONLY ONE SIDE OF CONNECTION OR MAY OMIT INFORMATION FOR CLARITY.
- 11.NO WORK SHALL BE PERFORMED AND NO MATERIAL SHALL BE PURCHASED FOR AREAS DESIGNATED WITHIN THE "HOLD" AREA INDICATED ON PLAN UNTIL THE DRAWING IS RELEASED FOR CONSTRUCTION WITH THE "HOLD" ITEMS RELEASED.
- 12.IF CONDITIONS ENCOUNTERED DURING CONSTRUCTION DIFFER FROM WHAT IS SHOWN ON THE CONTRACT DRAWINGS. THE STRUCTURAL ENGINEER SHALL BE NOTIFIED IMMEDIATELY AND WORK SHALL NOT PROGRESS UNTIL ALL PROBLEMS ARE RESOLVED TO THE SATISFACTION OF THE ENGINEER.
- 13. STRUCTURAL WORK SUPPORTING MECHANICAL EQUIPMENT SHALL BE VERIFIED BY THE EQUIPMENT SUPPLIER AND MECHANICAL ENGINEER PRIOR TO FABRICATION AND CONSTRUCTION.
- 14.IN THE EVENT THAT DISCREPANCIES EXIST BETWEEN THE PROJECT SPECIFICATIONS AND THE GENERAL STRUCTURAL NOTES, WHERE POSSIBLE, THE STRICTER OR MOST CONSERVATIVE REQUIREMENT SHALL BE FOLLOWED. IN ALL OTHER CASES THE CONTRACTOR SHALL INFORM THE ENGINEER AND AWAIT INSTRUCTION. DISCREPANCIES BETWEEN THE GENERAL STRUCTURAL NOTES AND PROJECT SPECIFICATIONS SHALL NOTE BE PERMITTED AS A BASIS FOR THE CONTRACTOR'S FAILURE TO COMPLY WITH THE REQUIREMENTS OF THE PROJECT SPECIFICATIONS OR AS A BASIS FOR CLAIMS FOR ADDITIONAL

FOUNDATIONS

- 1. REFER TO FOUNDATION PLANS FOR ADDITIONAL NOTES
- 2. THE CLIENT SHALL RETAIN THE SERVICES OF A GEOTECHNICAL ENGINEER TO CONFIRM AND OFFER RECOMMENDATION/DIRECTION RELATED TO: - EXCAVATION
- SITE PREPARATION - BACKFILL MATERIAL
- COMPACTION REQUIREMENTS - FOUNDING ELEVATION
- 3. ALL SITE PREPARATION, GRADING, COMPACTION TESTS, INSPECTIONS, ETC. SHALL BE FOLLOWED AND COMPLETED PRIOR TO ANY CONCRETE PLACEMENT.
- 4. ALL FILL AND BACKFILL BEING USED FOR SLABS OR OTHER STRUCTURAL APPLICATION SHALL BE TESTED FOR SUITABILITY BY A GEOTECHNICAL
- 5. NO BACKFILL CONTAINING STONES OVER 76mm (3"), FROZEN MATERIAL, DEBRIS, OR ORGANIC MATTER WILL BE PERMITTED.
- 6. DO NOT EXCAVATE FOR FOOTINGS BELOW A LINE INCLINED DOWN 30 DEGREES FROM NEARBY FOOTINGS UNLESS THE EXCAVATION IS ADEQUATELY BRACED OR APPROVED BY THE ENGINEER
- 7. DESIGN WORKS ENGINEERING AND INSPECTION ASSUMES NO RESPONSIBILITY OR LIABILITY FOR THE TRUTH OF THE SUBSURFACE CONDITIONS PRESENTED ON THE DRAWINGS AND IN THE BORING OR TEST PIT REPORTS. THE DATA IS INTENDED FOR THE PREPARATION OF BIDS AND SUBSEQUENT CONSTRUCTION. THEY REPRESENT CONDITIONS ONLY AT THOSE SPECIFIC LOCATIONS AT THE TIME THEY WERE MADE.
- 8. PROVIDE ADEQUATE DRAINAGE AWAY FROM FOUNDATIONS
- 9. FOUNDING SURFACE BELOW FOOTINGS SHALL BE INSPECTED BY A GEOTECHNICAL ENGINEER TO VERIFY THE SOIL BEARING CAPACITY.

REINFORCING STEEL

- 1. REINFORCING STEEL SHALL BE DETAILED AND PLACED IN ACCORDANCE W/ CAN/CSA A23.3-14 AND THE LATEST EDITION RSIC'S MANUAL OF STANDARD PRACTICE.
- 2. REINFORCING STEEL SHALL CONFORM TO CAN/CSA G30.18-M92 GRADE 400 MPa AND 400W (FOR ALL REINFORCING TO BE WELDED) AND SHALL BE DEFORMED BARS UNO.
- 3. WELDED WIRE FABRIC SHALL CONFORM TO THE REQUIREMENTS OF CAN/CSA G30.5-M1983 FOR SMOOTH WIRE FABRIC AND CAN/CSA G30.15-M1983 FOR DEFORMED WIRE FABRIC. LAPS SHALL BE MADE SUCH THAT THE OVERLAP, MEASURED BETWEEN OUTERMOST CROSS WIRE OF EACH FABRIC SHEET, IS NOT LESS THAN THE SPACING OF CROSS WIRES PLUS 50mm (2").
- 4. ALL DIMENSIONS SHOWING THE LOCATION OF REINFORCING STEEL NOT NOTED AS "CLEAR" OR "CLR" ARE TO CENTER OF STEEL. CLEAR COVER SHALL BE AS NOTED BELOW, UNO ON PLANS OR DETAILS.

CONCRETE COVER TO REINFORCING STEEL								
	MINIMUM							
	COVER CSA-A23.1	CSA-S413 (SEE NOTE #4)	1.5 h	2 h	3 h	4 h		
CONCRETE CAST AGAINST AND PERMANENTLY EXPOSED TO EARTH	75	-	75	75	75	75		
CONCRETE CAST AGAINST FORMS, BUT EXPOSED TO EARTH OR WEATHER:								
15 BARS, 16Ø WIRE, AND SMALLER, STIRRUPS, TIES, AND SPIRAL.	40	-	40	40	40	40		
COLUMN PRINCIPAL REINFORCEMENT.	50	-	50	50	65	75		
20 TO 55 BARS, AND ALL OTHER BARS.	50	-	50	50	50	50		
CONCRETE NOT EXPOSED TO WEATHER, OR NOT IN CONTACT WITH GROUND:								
35 BARS AND SMALLER FOR SLABS AND WALLS SEE NOTE #3.	20	TOP 40 BOT. 30	32	39	50	64		
FOR JOISTS,	20		25	25	40	50		
BEAM PRINCIPAL REINFORCEMENT.	20		25	25	39	50		
COLUMN PRINCIPAL REINFORCEMENT.	40	-	50	50	65	75		
STIRRUPS, TIES, SPIRALS, AND ALL OTHER BARS.	40	-	40	40	40	40		

- 5. LAP SPLICES OF REINFORCING STEEL IN CONCRETE BEAMS, SLABS AND FOOTINGS SHALL BE ACCORDING TO CAN/CSA 23.3 OR LAP SCHEDULE BELOW, UNO. STAGGER SPLICES A MIN OF ONE LAP LENGTH. NO TACK WELDING OF REINFORCING BARS ALLOWED. LATEST CAN/CSA CODE AND DETAILING MANUAL APPLY. PROVIDE BENT CORNER BARS TO MATCH AND LAP W/ HORIZONTAL BARS AT ALL CORNERS AND INTERSECTIONS PER TYPICAL DETAILS WHERE PROVIDED. VERTICAL WALL BARS SHALL BE SPLICED AT OR NEAR FLOOR LINES, SPLICE TOP BARS AT CENTER LINE OF SPAN AND BOTTOM BARS AT THE SUPPORT IN SPANDRELS, BEAMS,
- 6. MECHANICAL SPLICE COUPLERS MAY BE USED AS AN ALTERNATE TO LAP SPLICES. COUPLERS SHALL HAVE CURRENT CSA APPROVAL AND SHALL BE CAPABLE OF DEVELOPING 125% OF THE
- 7. WELDING OF REINFORCING BARS, METAL INSERTS, AND CONNECTIONS SHALL CONFORM TO CAN/CSA W186-M1990 AND SHALL BE MADE ONLY AT LOCATIONS SHOWN ON PLANS OR DETAILS. ALL REINFORCING SHALL BE BENT COLD. BARS SHALL ONLY BE BENT ONCE.
- 8. REINFORCING BAR SPACING SHOWN ON PLANS ARE MAX ON CENTERS. DOWEL ALL VERTICAL REINFORCING INTO FOUNDATION. SECURELY TIE ALL BARS IN LOCATION PRIOR TO CONCRETE PLACEMENT.

REBAR TENSION DEVELOPMENT LENGTH (mm)									
REBAR	f'c = 25MPa		f'c = 30MPa		f'c = 35MPa		f'c = 40MPa		
SIZE	TOP BARS	OTHERS	TOP BARS	OTHERS	TOP BARS	OTHERS	TOP BARS	OTHERS	
10M	375	300	350	300	325	300	300	300	
15M	575	450	525	400	500	375	450	350	
20M	775	600	700	550	650	500	600	475	
25M	1175	900	1075	850	1000	775	925	725	
30M	1425	1100	1300	1000	1200	925	1125	850	
35M	1600	1250	1500	1150	1400	1075	1300	1000	

CLASS B REINFORCING LAP SPLICES (mm)										
REBAR	f'c = 25MPa		f'c = 30MPa		f'c = 35MPa		f'c = 40MPa			
SIZE	TOP BARS	OTHERS	TOP BARS	OTHERS	TOP BARS	OTHERS	TOP BARS	OTHERS		
10M	500	375	450	350	425	325	400	300		
15M	725	575	675	525	625	500	575	450		
20M	1000	775	900	700	850	650	775	600		
25M	1525	1175	1400	1075	1300	1000	1200	925		
30M	1825	1425	1675	1300	1550	1200	1450	1125		
35M	2100	1600	1950	1500	1800	1400	1700	1300		
NOTES	:		·		·		·	·		

- 1. FOR CAST-IN-PLACE (NON-PRESTRESSED), CONCRETE, PROVIDE MINIMUM CONCRETE COVER TO REINFORCEMENT ACCORDING TO CSA-A23.1.
- 2. WHERE THE FIRE-RESISTANCE RATING OF A COLUMN EXCEEDS 3 HOURS, ADD WELDED WIRE MESH, MINIMUM 102 x 102 - MW3.2 x MW3.2, MIDWAY IN CONCRETE COVER.
- 3. FOR SHORT WALLS AS OCCURS PROVIDE COVER SAME AS FOR COLUMNS.
- 4. FOR PARKING STRUCTURES PROVIDE MINIMUM CONCRETE COVER TO REINFORCEMENT
- ACCORDING TO CSA-S413. COVER TO BOTTOM REINFORCEMENT IN THE MAIN FLOOR SLAB EXPOSED TO DEICING MUST MEET REQUIREMENTS OF CSA-S413.

ÄΣΤ		DI	REBAR COMPRESSION DEVELOPMEN LENGTH (mm)					
RET ESS AGT	REBAR SIZE							
CONCI		10M	15M	20M	25M	30M	35M	
CON ST	25MPa	190	290	380	480	580	670	
	≥30MPa	180	290	350	440	530	620	

REBAR COMPRESSION LAP SPLICES LENGTH (mm)							
REBAR SIZE							
10M 15M 20M 25M 30M 35M							
300	440	580	730	880	1020		

- CLEAR COVER AND CLEAR SPACING OF BARS MUST BE AT LEAST 1.0db AND 1.4db, RESPECTIVELY.
- FOR SLABS, WALLS, SHELLS OR FOLDED PLATES HAVE CLEAR SPACING BETWEEN BARS BEING DEVELOPED NOT LESS THAN 2d.
- A TOP BAR IS DEFINED AS A HORIZONTAL BAR HAVING A MINIMUM OF 300mm OF CONCRETE BENEATH IT.

CONCRETE

- 1. ALL CONCRETE SHALL BE NORMAL WEIGHT CONCRETE.
- 2. CONTRACTOR SHALL COORDINATE WITH WORK OF ALL OTHER TRADES AND WHERE REQUIRED INSTALL ALL BUILT-IN WORK, SLEEVES, INSERTS, ETC...AS
- 3. CONCRETE MIXES SHALL BE DESIGNED BY A CERTIFIED LABORATORY AND APPROVED BY THE ENGINEER. OF RECORD
- 4. PORTLAND CEMENT SHALL CONFORM TO CAN/CSA A23.1 AND 23.3.
- 5. NO MORE THAN 90 MINUTES SHALL ELAPSE BETWEEN CONCRETE BATCHING AND CONCRETE PLACEMENT, UNLESS APPROVED BY THE ENGINEER OR AUTHORIZED TESTING AGENCY.
- 6. CONCRETE BATCHING, MIXING, TRANSPORTATION AND PLACEMENT SHALL BE PER CAN/CSA A23.1 OR A23.4 AS APPLICABLE.
- 7. CONCRETE CONSOLIDATION SHALL BE PER CAN/CSA A23.1 OR A23.4

8. FORM WORK SHALL BE PER CAN/CSA A23.1 OR A23.4 AS APPLICABLE

- 9. REMOVE ALL DEBRIS FROM FORMS, REINFORCING STEEL AND OTHER EMBEDDED ITEMS PRIOR TO PLACING CONCRETE. CONCRETE SHALL NOT BE DROPPED THROUGH REINFORCING STEEL (WALLS OR COLUMNS) SO AS TO CAUSE A SEGREGATION OF AGGREGATES. UNCONFINED FALL OF CONCRETE SHALL NOT EXCEED 5 FEET. CARE SHALL BE TAKEN IN PLACING SLABS ON GRADE SO FILL MATERIAL IS NOT DISTURBED.
- 10. ALL ITEMS TO BE CAST IN CONCRETE SUCH AS REINFORCING, DOWELS, BOLTS. ANCHORS, PIPES, SLEEVES, ETC., SHALL BE SECURELY POSITIONED IN THE FORMS PRIOR TO PLACING OF CONCRETE.
- 11. CONCRETE SLAB ON GRADE CONTROL JOINTS SHALL BE SAW-CUT CONTROL JOINTS SUCH THAT THE ENCLOSED AREA DOES NOT EXCEED THAT INDICATED IN TYPICAL DETAIL.
- 12.EMBEDDED ITEMS SHALL BE PLACED PER CAN/CSA A23.1 OR A23.4 AS APPLICABLE.
- 13. PIPE OTHER THAN ELECTRICAL CONDUITS SHALL NOT BE EMBEDDED IN STRUCTURAL CONCRETE EXCEPT WHERE SPECIFICALLY APPROVED BY THE ENGINEER. MAX PIPE SIZE SHALL BE $\frac{1}{3}$ OF THE SLAB THICKNESS AND LOCATED AT THE MID-DEPTH. MIN SPACING SHALL BE 3 TIMES THE PIPE DIAMETER. PIPES SHALL NOT IMPAIR THE STRENGTH OF THE MEMBER.
- 14.PROTECT CONCRETE FROM DAMAGE OR REDUCED STRENGTH DUE TO COLD OR HOT WEATHER.
- 15. PROVIDE 6% AIR ENTRAINED CONCRETE EXPOSED TO EARTH AND WEATHER.
- 16. CONTRACTOR SHALL SUBMIT CONCRETE MIX REPORT WITH COMPRESSION TEST RESULTS TO THE STRUCTURAL ENGINEER FOR REVIEW PRIOR TO START OF FOUNDATION CONSTRUCTION. REPRESENTATIVE TEST CYLINDERS SHALL BE TAKEN FROM THE CONCRETE IN ACCORDANCE WITH CONCRETE CSA SPECIFICATIONS. TESTING SHALL BE PERFORMED AT 7, 28, AND 56 DAYS.
- 17. CONCRETE TO MEET THE FOLLOWING REQUIREMENTS AS OCCURS ON THIS PROJECT:

CONCRETE SCHEDULE									
EXPOSURE CLASS	ELEMENT	CEMENT TYPE	MIN. STRENGTH	SLUMP	MAX. AGG. SIZE	W/C RATIO	AIR ENTRAINMENT		
F-2	FOOTINGS,RETAINING WALLS	HS	30 MPa @ 56 DAYS	5" (120mm)	3/4" (20mm)	0.45	4%-7%		

- 1. USE TYPE GU (GENERAL USE) PORTLAND CEM ENT FOR CONCRETE, EXCEPT WHERE IN CONTACT WITH SOIL, USE TYPE HS (HIGH SULFATE) RESISTANT CEMENT.
- 2. "C" CLASSES PERTAIN TO CHLORIDE EXPOSURE.
- 3. "F" CLASSES PERTAIN TO FREEZING AND THAWING EXPOSURE WITHOUT CHLORIDES.
- 4. "N" CLASS IS EXPOSED TO NEITHER CHLORIDES NOR FREEZING AND THAWING.
- 5. "S" CLASSES PERTAIN TO SULPHATE EXPOSURE.

SPACING OF CONTRACTION JOINTS*								
SLAB THICKNESS (mm)	SPACING OF CONTRACTION JOINTS (m)							
125	3.0							
150	3.75							
175	4.25							
200	5.0							
225	5.5							
250	6.0							

* SPACINGS ARE APPROPRIATE FOR SLUMP BETWEEN 100mm AND 150mm. IF CONCRETE COOLS AT AN EARLY AGE, SHORTER SPACINGS MAY BE NEEDED TO CONTROL RANDOM CRACKING. (A TEMPERATURE DIFFERENCE OF ONLY 6°C MAY BE CRITICAL.) FOR SLUMP LESS THAN 100mm, JOINT SPACING CAN BE INCREASED BY 20%.

BASIS FOR DESIGN

IMPORTANCE CATEGORY:

GOVERNING BUILDING CODE:NBCC 2015 PROJECT LOCATION: . . .VAUGHAN, ONTARIO SEISMIC LOAD DESIGN

IMPORTANCE FACTOR (IE):	.1.0
Sa(0.2):).167
Sa(0.5):).096
Sa(1.0):	0.053
Sa(2.0):).026
Sa(5.0):	0.0065
Sa(10.0):).0027
PGA:).105
PGV:).074
SITE CLASS:	D



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	GOVERNING AUTHORITY.	
No.	Description	Date
1	ISSUED FOR REVIEW	2024-01-17
2	ISSUED FOR MINOR SITE DEVELOPMENT	2024-05-30

	,
ARCHITECT	SEAL PROFESSIONAL THE
	POVINCE OF OUT AND
	MAY 30, 2024

DRAWN BY:	AR
CHECKED BY:	YJL
ENGINEER:	HOSSEIN MOHAMMADI
DATE:	2024-01-17
PROJECT #:	2021357
SCALE:	AS NOTED

PROJECT

CLIENT

7242 HWY 27 -**RETAINING WALL**


VAUGHAN, ON, CANADA MINOR SITE DEVELOPMENT APPLICATION NO. DA.24.020 SITE DEVELOPMENT APPLICATION NO. DA.23.035

DESCRIPTION

GENERAL NOTES

S0.2



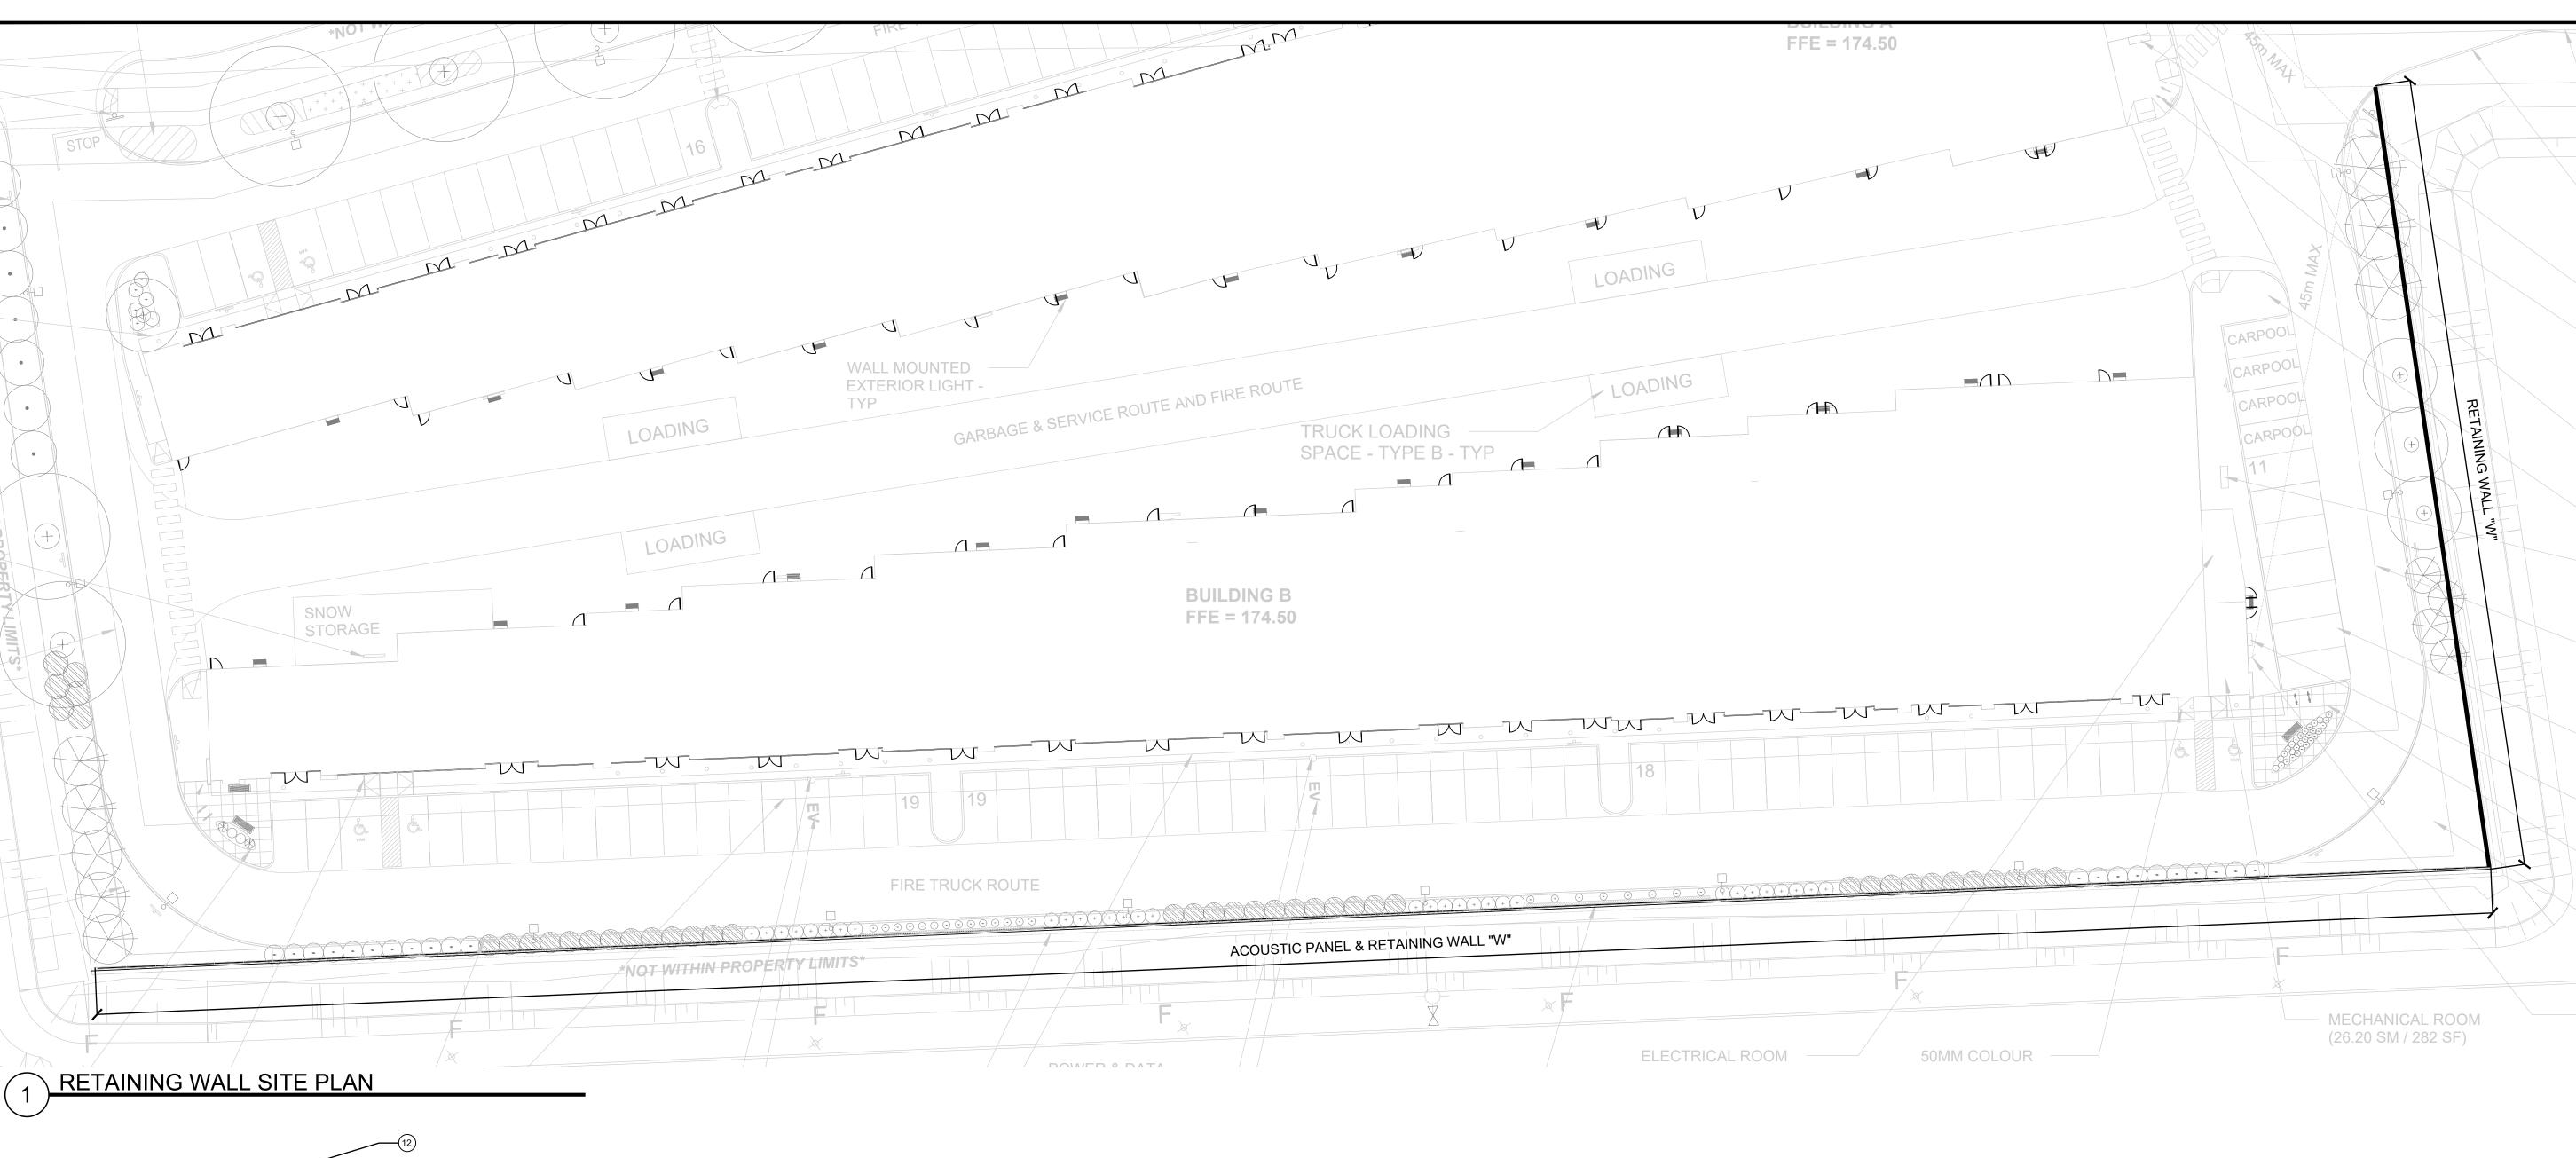



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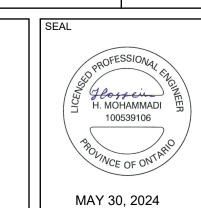
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No.	Description	Date				

1	ISSUED FOR REVIEW	2024-01-17
2	ISSUED FOR MINOR SITE DEVELOPMENT	2024-05-30

ARCHITECT



CLIENT

DRAWN BY:	AR
CHECKED BY:	YJL
ENGINEER:	HOSSEIN MOHAMMADI
DATE:	2024-01-17
PROJECT #:	2021357
SCALE:	AS NOTED

ROJECT

7242 HWY 27 -RETAINING WALL

VAUGHAN, ON, CANADA


L4H 4Y8
MINOR SITE DEVELOPMENT
APPLICATION NO. DA.24.020
SITE DEVELOPMENT
APPLICATION NO. DA.23.035

DESCRIPTIO

SITE PLAN AND WALL DETAIL

S1.0


3

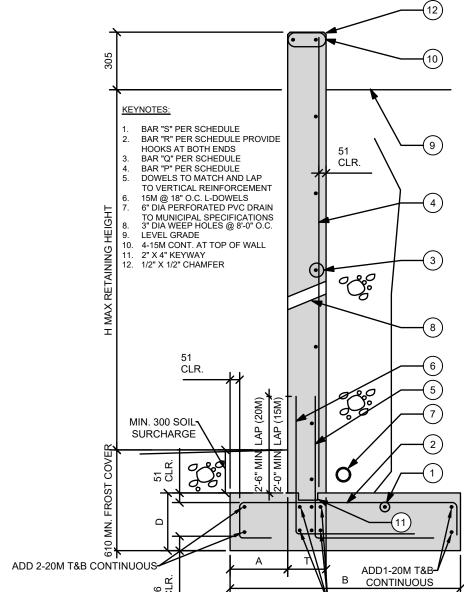

	RETAINING WALL SCHEDULE									
	DIMENSIONS REINFORCEMENT									
WALL#	MAX. H	Α	В	D	Т	Р	Q	R	S	
W1	6'-0"	305	1524	305	250	15M @ 250	10M @ 200	15M @ 250	REINF-1	
W2	8'-0"	305	2133	355	250	20M @ 200	10M @ 200	20M @ 200	REINF-1	
W3	10'-0"	305	2743	406	250	20M @ 150	10M @ 200	20M @ 150	REINF-1	
REINF	REINF-1 = 15m @ 12" T&B CONTINUOUS									

ADD 2-20M T&B CONTINUOUS

TYPICAL RETAINING WALL DETAIL

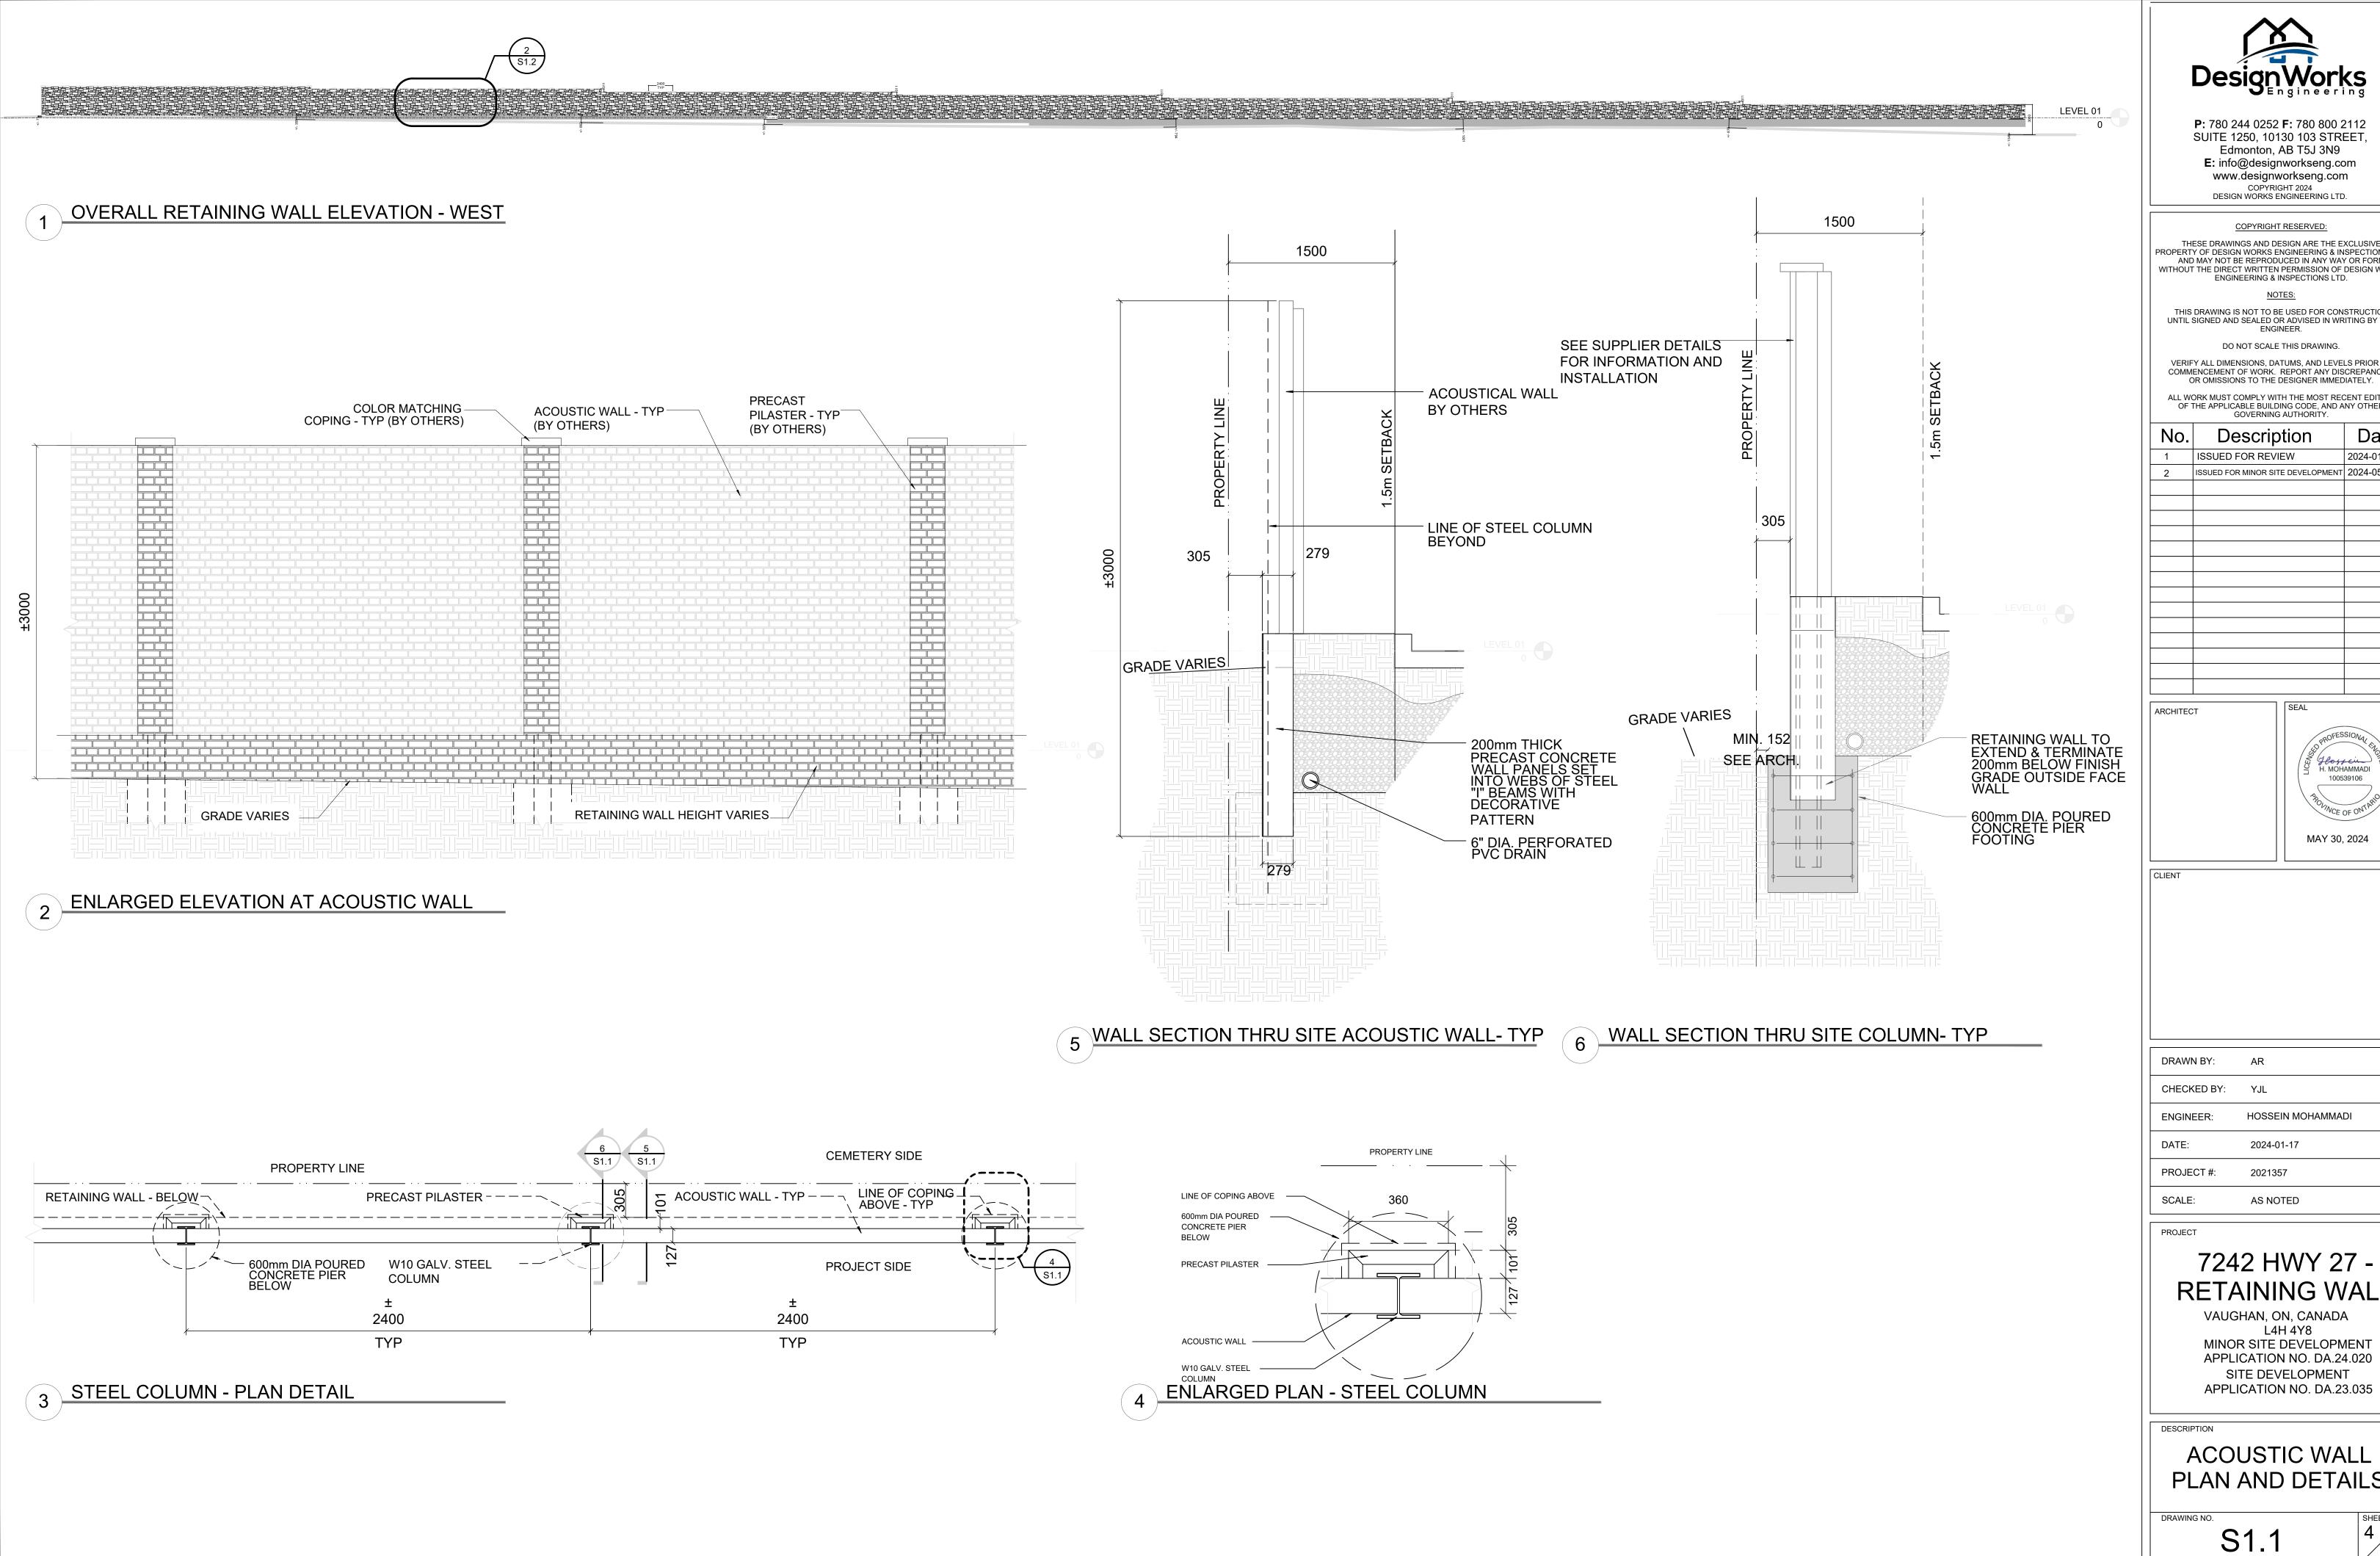

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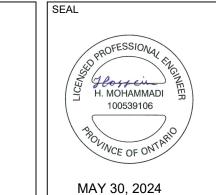
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No.	Description	Date
1	ISSUED FOR REVIEW	2024-01-17
2	ISSUED FOR MINOR SITE DEVELOPMENT	2024-05-30
1		




DRAWN BY:	AR
CHECKED BY:	YJL
ENGINEER:	HOSSEIN MOHAMMADI
DATE:	2024-01-17
PROJECT #:	2021357

RETAINING WALL

MINOR SITE DEVELOPMENT APPLICATION NO. DA.24.020 SITE DEVELOPMENT APPLICATION NO. DA.23.035

ACOUSTIC WALL PLAN AND DETAILS

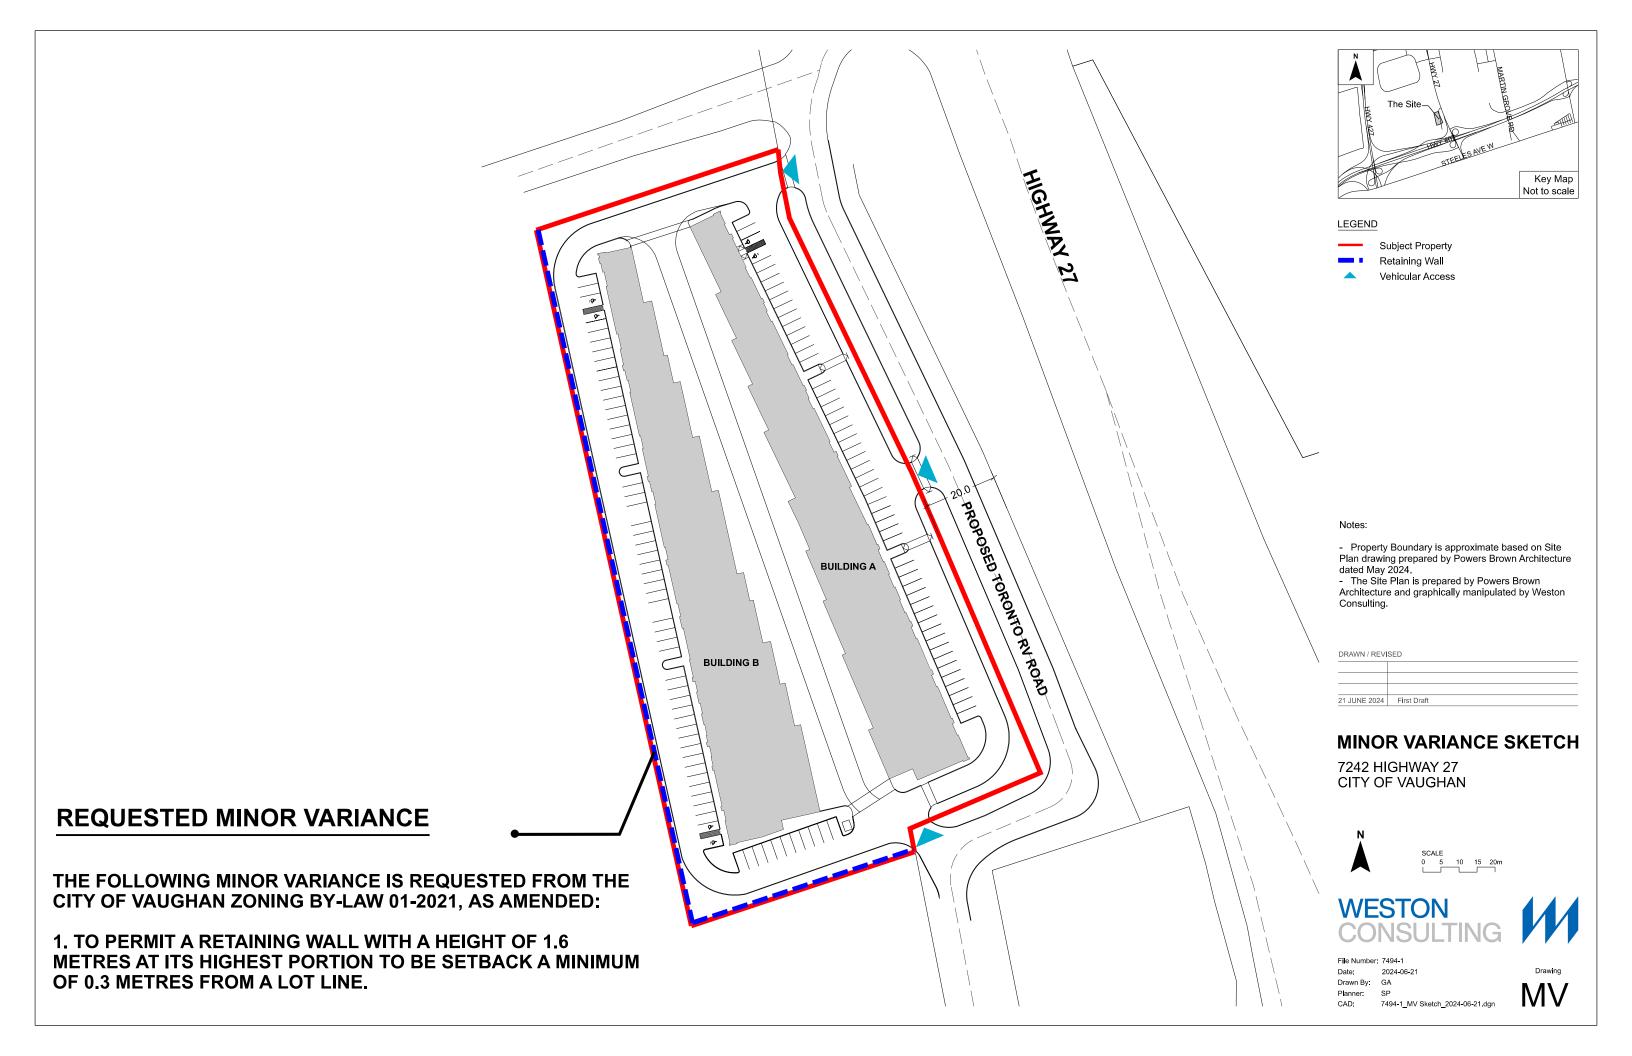

7242 HWY 27, VAUGHAN, ON

7242 HWY 27, VAUGHAN

ARCHITECTS PROJECT # 215073

A PROJECT FOR

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LANDSCAPE

OMC LANDSCAPE ARCHITECTURE


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ABBREVIATIONS

BRE	VIATIONS		
Ø	DIAMETER		
ę	CENTER LINE	R	RADIUS, RISER OR
#	POUND/ NUMBER	DD	RISERS
& @	AND AT	RD REQD	ROOF DRAIN REQUIRED
w	Al	REV	REVISION
A/C	AIR CONDITIONING	RM	ROOM
ACT	ACOUSTICAL CEILING TILE	RO RTU	ROUGH OPENING ROOF TOP UNIT
ADA	AMERICANS WITH	KIO	NOOF FOI ONT
	DISABILITIES ACT	SCWD	SOLID CORE WOOD
ADDL AFF	ADDITIONAL ABOVE FINISH FLOOR	SECT	DOOR SECTION
AFG	ABOVE FINISH GRADE	SIM	SIMILAR
AHU	AIR HANDLING UNIT	SPECD	SPECIFIED
ALT ALUM	ALTERNATE ALUMINUM	SQ SST	SQUARE STAINLESS STEEL
ARCH	ARCHITECT	STO	STORAGE
		STRUCT	STRUCTURAL
BD BFF	BOARD BELOW FINISH FLOOR	TOC	TOP OF CURB
BLDG	BUILDING	TOM	TOP OF MULLION
ВОМ	BOTTOM OF MULLION	TOP	TOP OF PARAPET
BOR	BOTTOM OF REVEAL	TOR TOS	TOP OF REVEAL TOP OF SLAB
CAB	CABINET	TW	TILTWALL
CJ	CONTROL JOINT/	TYP	TYPICAL
	CONSTRUCTION JOINT	UNO	UNLESS NOTED
CLG	CEILING	UNO	OTHERWISE
CIP CLR	CAST-IN-PLACE CLEAR	VOT	VINIVI COMPOSITION
CMU	CONCRETE MASONRY	VCT	VINYL COMPOSITION TILE
001	UNIT COLUMN	VERT	VERTICAL
COL	CONCRETE	VEST	VESTIBULE
CONSTR	CONSTRUCTION	W/	WITH
CONT	CONTINUE CORRIDOR	W/O WD	WITHOUT WOOD
CT	CERAMIC TILE	WDW	WINDOW
5-			
DF DIM	DRINKING FOUNTAIN DIMENSION		
DIST	DISTANCE		
DS	DOWNSPOUT		
DWG	DRAWING		
EIFS	EXTERIOR INSULATED		
EJ	FINISH SYSTEM EXPANSION JOINT		
ELEC			
ELEV	ELEVATOR		
EQ EXIST	EQUAL EXISTING		
EXP	EXPANSION		
EXT	EXTERIOR		
FD	FLOOR DRAIN		
FE	FIRE EXTINGUISHER		
FEC	FIRE EXTINGUISHER CABINET		
FLR	FLOOR OR FLOORING		
FLUOR	FLUORESCENT		
FIN FIXT	FINISH		
FIXI	FIXTURE FIELD VERIFY		
GA GALV	GAUGE GALVANIZED		
GYP	GYPSUM		
ЫĐ	HOSE DID		
HB HDW	HOSE BIB HARDWARE		
НМ	HOLLOW METAL		
HNDRL	HANDRAIL		
HORIZ HT	HORIZONTAL HEIGHT		
	TILIOTTI		
INSUL	INSULATION		
INFO INT	INFORMATION INTERIOR		
JAN	JANITOR		
LAV	LAVATORY		
LDG	LANDING		
LT LWC	LIGHT LIGHTWEIGHT		
-	CONCRETE		
MAX	MAXIMUM		
MFR	MANUFACTURER		
MIN	MINIMUM		
MO MTD	MASONRY OPENING MOUNTED		
MTL	METAL		
MULL	MULLION		
NIC	NOT IN CONTRACT		
NTS	NOT TO SCALE		

OC ON CENTER

OF/CI OWNER FURNISHED/

OF/OI OWNER FURNISHED/

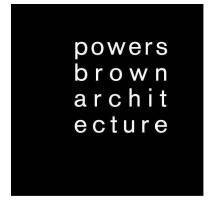OPH OPPOSITE HAND

PLAM PLASTIC LAMINATE

PLYWD PLYWOOD

PTD PAINTED

PR PAIR

CONTRACTOR INSTALLED

OWNER INSTALLED

SYMBOL LEGEND

SYMBOL L	LGLIND	
TRUE NORTH	N	NORTH ARROW
NORTH	(x)	COLUMN ID
		- EXISTING CONSTRUCTION TO REMAIN
	=====	- EXISTING CONSTRUCTION TO BE DEMOL
		- NEW PARTITION
FIRE RATING —— (NUMBER)	-xxxx	HEAD CONDITION (LETTER)
PARTITION TYPE (LETTER)		- STUD SIZE (NUMBER)
		EXISTING DOOR
		NEW DOOR
	/ &	TO CENTER LINE OF BUILDING ELEMENT
◀		FACE OF FINISH
<u></u>	A1- A101- SIM-	DETAIL NUMBERSHEET NUMBERDESCRIPTION OF SIMILAR OR OPPOSITE
\/-		- AREA TO BE DETAILED
A1 A101	A1————————————————————————————————————	BUILDING SECTION DETAIL NUMBERSHEET NUMBER
I	A1- A101-	WALL SECTION OR DETAIL NUMBERSHEET NUMBER
EXTERIOR ELEVATION	A1 -	- DETAIL NUMBER - DIRECTION OF ELEVATION
<u></u>	A101	- SHEET NUMBER
INTERIOR ELEVATION OR	A1 / A501	− SHEET NUMBER
VIEW REFERENCE	AT7 A50T -	- DETAIL NUMBER
	XXXX	ROOM NAME
	XXXX -	ROOM AREA
	XXXX	- ROOM AREA
	(XXXX	DOOR NUMBER (WITH SCHEDULE) KEYNOTE TAG
	⟨x⟩	WINDOW TAG
	P1	FINISH - WALL (WITH SCHEDULE)
	B1	FINISH - BASE (WITH SCHEDULE)
	CP1	FINISH - FLOOR (WITH SCHEDULE)
	C1	FINISH - CEILING (WITH SCHEDULE)
	9' - 0"	DIMENSION OF CEILING ABOVE FINISH FLOOR
	EQ1	EQUIPMENT (WITH SCHEDULE)
	\$ ₂	WALL MOUNTED ONE-WAY SWITCH
	▼	DATA / TELEPHONE, WALL MTD
	lacktriangledown	TELEPHONE ONLY, WALL MTD DATA ONLY, WALL MTD
	V	DATA / TELEPHONE, FLOOR MTD
		110 DUPLEX RECEPTACLE, WALL MTD
		110 DUPLEX RECEPTACLE, FLOOR MTD
	ф	DUPLEX CONVENIENCE, WALL MTD
	#	DUPLEX DEDICATED, WALL MTD
	♦	DUPLEX SEPARATE, WALL MTD DOUBLE DUPLEX CONVENIENCE, WALL MTD
	*	DOUBLE DUPLEX CONVENIENCE, WALL MTD

DOUBLE DUPLEX DEDICATED, WALL MTD

DOUBLE DUPLEX SEPARATE, WALL MTD

SIMPLEX CONVENIENCE, WALL MTD

SIMPLEX DEDICATED, WALL MTD

SIMPLEX SEPARATE, WALL MTD

CEILING MOUNTED EXIT SIGN

FIRE EXTINGUISHER CABINET

DOUBLE DUPLEX RECEPTACLE, FLOOR MTD

VICINITY MAP





PROJECT LOCATION-



7242 HWY 27, VAUGHAN



powers brown archit ecture

411 Richmond Street East Suite 206 Toronto, Ontario M5A 3S5 647.931.9787

www.powersbrown.com

PROJECT TITLE

7242 HWY 27, VAUGHAN, ON

7242 HWY 27, VAUGHAN

A PROJECT FOR

NCAP NICOLA (HWY27) LTD.

A ALL MATERIALS ON JOB TO COMPLY WITH FEDERAL

GENERAL NOTES

- AND STATE VOC/AIM REGULATIONS. B ALL CONSTRUCTION TO COMPLY WITH LOCAL ACCESSIBILITY CODES, CURRENT ENERGY CODE AND LOCAL AMMENDMENTS OR REQUIREMENTS.
- C ALL FIRE WALL PENETRATIONS SHALL BE SEALED WITH FIRE RATED FOAM SEALANT (BOTH SIDES OF WALL). SEALANT TYPE SHALL BE A COMPATIBLE RATING TO THE WALL SYSTEMS.
- MAXIMUM CLEAR SPAN HEIGHTS FOR INTERIOR METAL STUDS SHALL BE SUCH THAT DEFLECTION SHALL NOT EXCEED L/360 UNDER A 5 PSF LOAD
- (CERAMIC TILE FINISHES AND/OR WALLS TO DECK) AND L/120 AT ALL OTHER AREAS. WHERE REQUIRED BY CODE ALUMINUM VERTICAL MULLIONS TO RECEIVE STEEL STIFFENER TO ACHIEVE WIND LOAD CAPACITY.
- F ALL WOOD FRAMING, BLOCKING, SHEATHING OR BRACING SHALL BE FIRE RETARDANT TREATED. G DO NOT SCALE THESE DRAWINGS FOR DIMENSIONAL INFORMATION. REFER TO DIMENSIONS ON THE FLOOR PLANS AND ENLARGED PLANS. IF THERE IS A CONFLICT WITH THE PLAN DIMENSIONS OR AN EXISTING FIELD CONDITION, CONTACT THE
- ARCHITECT. DIMENSIONS ARE GIVEN TO FACE OF FINISH, UNO. H REFER TO BUILDING ELEVATION DRAWINGS FOR FINISH MATERIAL CALL OUTS AND PAINT REQUIREMENTS. VERIFY COLOR OF MATERIALS NOT SHOWN ON THE DRAWINGS WITH THE ARCHITECT. ALL GYPSUM BOARD THROUGHOUT THE PROJECT SHALL BE 5/8" THICK, UNO. (TYPE 'X' IF REQUIRED)

USE WATER RESISTANT GYPSUM BOARD AT ALL WET LOCATIONS AND 5/8" FIBER REINFORCED CEMENT

BOARD BEHIND ALL WALL TILE. K GALVANIZE ALL EXPOSED EXTERIOR STEEL. COORDINATE ALL REQUIRED ELECTRICAL CONDUITS AND SLEEVES FOR IRRIGATION UNDER SIDEWALK AREAS AT DECORATIVE LIGHT POLES AND PLANTERS WITH MECHANICAL AND ELECTRICAL PLANS.

\triangle	DATE	REVISION
1	2023-06-15	ISSUED FOR SPA
2	2023-10-11	RE-ISSUED FOR SPA
3	2024-01-12	RE-ISSUED FOR SPA
4	2024-03-01	RE-ISSUED FOR SPA
5	2024-05-09	RE-ISSUED FOR SPA
6	2024-05-30	ISSUED FOR MINOR SITE DEVELOPMENT

SHEET NAME SYMBOL LEGEND & ABBREVIATION INDEX

RASHAD HINDI LICENCE 6646

2024-05-30

PROJECT NO: 215073 DRAWN BY: PBA CHECKED BY: LD

G001

SHEET NUMBER

Autodesk Docs://215073 Cavalieri 7242 Highway 27 Vaughan/215073_ARCH_C&S_R21 - BLDG 1.rvt

:17 PM	
5/30/2024 2:19:17 PM	
5/30/20	

DRAWING	3 INE	DEX																					
Future Issue (12) Future Issue (11) Future Issue (10)	Future Issue (09)	Re-Issued for SPA (2024-05-09)	GINEEKING SUBMISSION (2024-05-09)	IG SUBMISSION (2024-03-	Re-Issued for SPA (2024-01-12)	Re-Issued for SPA (2023-10-11)	Issue (01)	Sheet Number	Sheet Name	Future Issue (12)	Future Issue (11)	Future Issue (10)	SUED FOR MINOR SITE DEVELOPMENT	Re-Issued for S	SINEERING SUBMISSION (2024-05-09)	Re-Issued for SPA (2024-03-01)	Re-Issued for SPA (2024-01-	Re-Issued for SPA (2023-10-11)		Sheet Name		powers brown archit ecture PROJECT TITLE 7242 HWY 27,	411 Richmond Street East Suite 206 Toronto, Ontario M5A 3S5 647.931.9787 www.powersbrown.com
	ISSI		EXPECT EN	ERFECT ENG									18SI		ERFECT ENGIN	ERFECT ENGIN						7242 HWY 2	27, VAUGHAN
			D	RAV	VIN	G IN	IDE.	X - G	ENERAL						DR	RAW	ING	INDE	-X - I	MECHANICAL		A PROJ	ECT FOR
	•	+ +		_	•				COVER										MC			† 	(HWY27) LTD.
	•	+ -	•	-	•		• (G002-A	SYMBOL LEGEND & ABBREVIATION INDEX CODE SUMMARY (BUILDING A)										M0 M1	00 SITE PLAN			
	•	+ +			•	•			CODE SUMMARY (BUILDING B) OVERALL SITE PLAN				+				+		M20	00a BUILDING A1-FOUNDATION PLUMBING LAYC 01a BUILDING A1-FOUNDATION PLUMBING LAYC			
	•	+ +			•				SITE PLAN - ENLARGED OVERALL SIGNAGE PLAN										M20	02a BUILDING A1-MEZZ. UNDERFLOOR PLUMBIN 1-2	G LAYOUT		
		+ +	•	•					TORONTO RV ROAD REALIGNMENT COMPOSITE UTILITY PLAN										M20	03a BUILDING A1-MEZZ. UNDERFLOOR PLUMBIN 2-2	GLAYOUT		
	•	+ +	•	•					PRIVATE DEVELOPMENT - COMPOSITE UTILITY PLAN CONTEXT PLAN								1			04a BUILDING A1-GROUND FLOOR PLUMVIONG I 05a BUILDING A1-GROUND FLOOR PLUMBING LA			
			I	. ,		\ - -	•										1 1		M20	06a BUILDING A1-MEZZANINE FLOOR PLUMBING 07a BUILDING A1-MEZZANINE FLOOR PLUMBING	LAYOUT 1-2		
)R/	4WIN	IG I	NDE	ΞX -	- LAN	DSCAPING								$\downarrow \downarrow \downarrow$		M20	00b BUILDING B1-FOUNDATION PLUMBING LAYO	JT 1-2		
	•	•	• •	•				L0	CIRCULATION DIAGRAM				+			-	+			01b BUILDING B1-FOUNDATION PLUMVING LAYO 02b BUILDING B1-MEZZ. UNDERFLOOR PLUMVIN		1	
	•	+	• •		•	•			LAYOUT PLAN ENLARGEMENT PLAN								+		M20	03b BUILIDNG B1-MEZZ. FUNDERFLOOR PLUMBI	IG LAYOUT		
	•	•	• •	•	+	•		L2	PLANTING PLAN PLANTING ENLARGEMENT PLAN										M20	2-2 04b BUILDINGN B1-MEZZ. UNDERFLOOR PLUMV	NG LAYOUT		
	•	•	•	•	•	•	•	L3	SIDEWALK PLAN										M20	1-2 05b BUILDINJG B1- GROUND FLOOR PLUMBING	AYOUT 2-2		
	•	+	• •	_	•	•	•		DETAILS DETAILS											06b BUILDING B1-MEZZANINE FLOOR PLUMBING 07b BUILDING B1-MEZZANINE FLOOR PLUMBING			
				DB	۸۱۸	/INIC	: INII	DEY	- CIVIL											00a BUILDING A1-GROUND FLOOR WATER SUPF			
	•						IINL		CIVIL COVER PAGE										M30	01a BUILDING A1-GROUND FLOOR WATER SUPF	Y LAYOUT		
	•	•		• •				C1.00	SITE GRADING PLAN SITE SERVICING PLAN										M3(02a BUILDING A1-MEZZ. FLOOR WATER SUPPLY 03a BUILDING A1-MEZZ. FLOOR WATER SUPPLY			
	•	•	•	• •				C2.01	SERVICING CROSS SECTION				+							00b BUILDING B1-GROUND FLOOR WATER SUPPLY			
	•	•		• •					STORM MANAGEMENT PLAN PLAN AND PROFILE										M30	01b BUILDING B1-GROUND FLOOR WATER SUPF	Y LAYOUT		
		•		• •					PRE-DEVELOPMENT DRAINAGE PLAN POST-DEVELOPMENT DRAINAGE PLAN										M30	2-2 02b BUILDING B1-MEZZ. FLOOR WATER SUPPLY	_AYOUT 1-2		
	•	•	•	• •				C4.00	DETAILS 1 DETAILS 2											03b BUILDING B1-MEZZ. FLOOR WATER SUPPLY 00a BUILDING A1-GROUND FLOOR HVAC LAYOU			
		•		• •			•	C5.00	EROSION AND SEDIMENT CONTROL PLAN - PRIVATE										M4(01a BUILDING A1-GORUND FLOOR HVAC LAYOU 02a BUILDING A1-MEZZ. FLOOR HVAC LAYOUT 1	2-2		
		•		• •					NEW RV ROAD CONNECT PLAN GRADING NEW RV ROAD CONNECT PLAN STORM MANAGEMENT										M4(03a BUILDING A1-MEZZ FLOOR HVAC LAYOUT 2-)		
		•	•	• •			(CM.02.02	PLAN NEW RV ROAD CONNECT PLAN GENERAL SERVICING										M40		2-2		
		•	•	• •			(CM.04.01	PLAN NEW RV ROAD EROSION AND SEDIMENT CONTROL PLAN				_							02b BUILDING B1-MEZZ. FLOOR HVAC LAYOUT 1 03b BUILDING B1 MEZZ FLOOR HVAC LAYOUT 2-			
	<u>'</u>			Λ/INI/	~ IN	יחרי	<i>y</i> 1													00a BUILDING A1-ROOF MECHANICAL LAYOUT 1 01a BUILDING A1-ROOF MECHANICAL LAYOUT 2			
		U	KAI	/VII/C	וו כ		\ - <i>F</i>	ARCE	HITECTURAL										M50	00b BUILDING B1 ROOF MECHANICAL LAYOUT 100b BUILDING B1-ROOF MECHANICAL LAYOUT 2	2		
	•	•		•	•	•	• /		OVERALL GROUND AND MEZZANINE FLOOR PLAN -										M6	MECHANICAL DETAILS	2		
	•	•	•	,	•	•	• /	A101-B	BUILDING A OVERALL GROUND AND MEZZANINE FLOOR PLAN -										M6 M7				
	•	•	•	,	•	•		A110-A	BUILDING B OVERALL ROOF PLAN - BUILDING A										M8 M8				
	•	+ -			•	 			OVERALL ROOF PLAN - BUILDING B OVERALL BUILDING ELEVATIONS - BUILDING A										M9 M9	000 MECHANICAL SPECIFICATION			
	•	+	•	_	•		• /	A201-B	OVERALL BUILDING ELEVATIONS - BUILDING B OVERALL BUILDING SECTIONS - BUILDING A								1 1		I IVIS	DO . PREDIMINATE OF EDITION TON		△ DATE	REVISION
	•	•		,	•	•	• /	A301-B	OVERALL BUILDING SECTIONS - BUILDING B ACOUSTIC WALL AND RETAINING WALL													1 2024-05-30 ISSUE DEVEL	D FOR MINOR SITE OPMENT
					NG	IND			RUCTURAL														
									STRUCTURAL COVER PAGE														
	•	+ +						S0.2	GENERAL STRUCTURAL NOTES														
	•	+ +							SITE PLAN AND WALL DETAIL ACOUSTIC WALL PLAN AND DETAILS														
			DR	RAWI	NG	IND	EX	- ELI	ECTRICAL														
		•					•		ELECTRICAL LIGHTING SITE PLAN CALCULATION ELECTRICAL LIGHTING SITE PLAN STUDY													PROJECT NO: 215073	
		•			•		•	E1.2	ELECTRICAL LIGHTING SITE PLAN STUDY - HIGHWAY 27													DRAWN BY: EL CHECKED BY: LD	
	•	•	•	•	•			E1.3	AND TORONTO RV RD INTERSECTION LIGHTING SCHEDULE													SHEET NAME	
	•	•	•	•				E1.4	ELECTRICAL DETAILS													DRAWIN	IG INDEX
																						SEAL	SHEET NUMBER
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																						O ARCHITECTS 2	00044
																						RASHAD HINDI	16001.1
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																						6646	I

		Ontario Building Code Data Matrix Part 3	Building Code Reference			Ontario Building Code Data Matrix Part 3	Building Code Reference ¹
3.00	Building Code Version:	O. Reg. 332/12 Last Amendment O. Reg. 191/14		3.16	Importance Category:	□ Low □ Low human occupancy □ Post-disaster shelter ■ Normal	4.1.2.1.(3) & T4.1.2.1.B
3.01	Project Type:	New□ Addition□ Renovation□ Change of use□ Addition and renovation	[A] 1.1.2.			☐ High ☐ Minor storage building ☐ Explosive or hazardous substances	
		TWO NEW ONE STOREY WITH MEZZANINE Description: MULTI-UNIT INDUSTRIAL WAREHOUSE				□ Post-disaster	
3.02	Major Occupancy	Occupancy Use	3.1.2.1.(1)	3.17	Seismic Hazard	(IE Fa Sa (0.2)) =	4.1.2.1.(3)
	Classification:	BUILDING 1 (A) GROUP F, DIV 2 MEDIUM HAZARD INDUSTRIAL			Index:	Seismic design required for Table 4.1.8.18. items 6 to 21: ((IE Fa Sa (0.2)) ≥ 0.35 or Post-disaster) □ No □ Yes	4.1.8.18.(2)
3.03	Cunavimanasad	■ Na □ Vaa	3.2.2.7.	3.18	Occupant Load	Floor Level/Area Occupancy Based On Occupant Load Type (Persons)	3.1.17.
3.03	Superimposed Major Occupancies:	No ☐ Yes Description: N/A	3.2.2.1.			BUILDING A GROUP F-2 AS PER CLIENT	
3.04	Building Area (m2)	Description: Existing New Total	[A] 1.4.1.2.				
		BUILDING 1 (A) 0 2,663 M ² 2,663 M ²					
				3.19	Barrier-free	Yes ****THIS PERMIT APPLICATION IS FOR CORE AND SHELL OF TWO	
				0.10	Design:	BUILDING, TENANT FIT-OUT WILL BE IN A SEPARATE PERMIT No	
3.05	Gross Area (m2)	Total 2,663 M² 2,663 M² Description: Existing New Total	[A] 1.4.1.2.	3.20	Hazardous Substances:	Yes ****THIS PERMIT APPLICATION IS FOR CORE AND SHELL OF TWO BUILDING, TENANT FIT-OUT WILL BE IN A SEPARATE PERMIT	.1.2. & 3.3.1.19.
		BUILDING 1 (A) 0 3,599 M ² 3,599 M ²		3.21	Required Fire Resistance Ratings	Horizontal Assembly Rating Supporting Noncombustible Assembly (H) in lieu of rating?	3.2.2.20 83. & 3.2.1.4.
						Floors over basement □ No □ Yes □ N/A	
		Total 3,599 M ² 3,599 M ²				Floors over basement \(\text{\boundary} \) No \(\text{\boundary} \) Yes \(\text{\boundary} \) N/A	
.06	Mezzanine Area	Description: Existing New Total	3.2.1.1.			Mezzanine 45M □ No ■ Yes □ N/A	
.00	(m2)	BUILDING 1 (A) 0 936 M ² 936 M ²	0.2.1.1.			Roof No Yes N/A	
				3.22	Spatial Separation	Wall EBF L.D. L/H Required Construction Type Cladding Type Area (m) or FRR (H) Required Required	3.2.3.
		Total 936 M ² 936 M ²			BUILDING A		
3.07	Building Height	Storeys above grade (m) Above grade	[A] 1.4.1.2. &			EAST 1,410 <15	
		Storeys below grade	3.2.1.1.			Noncombustible Noncombustible	
.08	High Building	■ <u>No</u> □ Yes	3.2.6.				
3.09	Number of Streets/ Firefighter access	BUILDING A: FOUR (4) STREET	3.2.2.10. & 3.2.5.	3.23	Plumbing Fixture	Ratio: Male:Female = 50:50 Except as noted otherwise	3.7.4.
3.10	Building Classification: (Size and Construction Relative to Occupancy)	3.2.2.72. GROUP F, DIVISION 2, UP TO 2 STOREYS, SPRINKLERED BUILDING A	3.2.2.20 83.	J.23	Requirements	Floor Level/Area Occupant OBC Fixtures Fixtures Load Reference Required Provided	J.7. 4 .
3.11	Sprinkler System	■ Required □ Not Required	3.2.1.5. &	_			
I	Sp. made Gystom	Proposed: □ entire building □ selected compartments □ selected floor areas □ basement □ in lieu of roof rating □ none	3.2.2.17.			THIS PERMIT APPLICATION IS FOR CORE & SHELL OF ONE BUILDING. TENANT FIT OUT WILL BE IN A SEPARATE PERMIT	
3.12	Standpipe System	■ Not required □ Required	3.2.9.	_			
3.13	Fire Alarm System	■ Required □ Not required	3.2.4./	3.24	Energy Efficiency:	Compliance Path:	
. 10		Proposed: ☐ Single stage ☐ Two stage ☐ None	3.2.4.1.2			Climatic Zone: ZONE 6A	
3.14	Water Service / Supply is Adequate	□ No ■ <u>Yes</u>		3.25	Notes:		
	Construction Type:	Restriction: ☐ Combustible permitted ☐ Non-combustible required	3.2.2.20 83. & 3.2.1.4.	ι			
3.15	,,	Actual: ☐ Combustible ☐ Non-combustible ☐ Combination					

powers brown archit ecture

411 Richmond Street East Suite 206 Toronto, Ontario M5A 3S5 647.931.9787 www.powersbrown.com

PROJECT TITLE

7242 HWY 27, VAUGHAN, ON

7242 HWY 27, VAUGHAN

A PROJECT FOR

NCAP NICOLA (HWY27) LTD.

\triangle	DATE	REVISION					
1	2023-06-15	ISSUED FOR SPA					
2	2023-10-11	RE-ISSUED FOR SPA					
3	2024-01-12	RE-ISSUED FOR SPA					
4	2024-03-01	RE-ISSUED FOR SPA					
5	2024-05-09	RE-ISSUED FOR SPA					
6	2024-05-30	ISSUED FOR MINOR SITE DEVELOPMENT					
PROJE	ECT NO: 215073	3					
DRAW	N BY: EL	·					
CHECK	KED BY: LD						

CODE SUMMARY (BUILDING

SHEET NUMBER O ARCHITECTS Z

RASHAD HINDI
LICENCE
6646

- BLDG 1.rvt
CH_C&S_R21 - BLDG
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vay 27 Vaugha
ieri 7242 Highv
215073 Cavali
Autodesk Docs://
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		Ontario Building Code Data Ma Part 3	ıtrix			Building Code Reference			Ontario Building Code Data Matrix Part 3	Building Code Reference ¹
3.00	Building Code Version:	O. Reg. 332/12 Last Amer	ndment <u>(</u>	O. Reg. 19	91/14		3.16	Importance Category:		4.1.2.1.(3) & T4.1.2.1.B
3.01	Project Type:	■ New ☐ Addition ☐ Change of use ☐ Addition and reno TWO NEW ONE STOREY				[A] 1.1.2.			 Normal ☐ High ☐ Minor storage building ☐ Explosive or hazardous substances ☐ Post-disaster 	
		Description: MULTI-UNIT INDUSTRIAL								
3.02	Major Occupancy Classification:	Occupancy BUILDING 2 (B) GROUP F, DIV 2	MEDIUM HA	AZARD IN	DUSTRIAL	3.1.2.1.(1)	3.17	Seismic Hazard Index:		4.1.2.1.(3) 4.1.8.18.(2)
							3.18	Occupant Load	Floor Level/Area Occupancy Based On Occupant Load Type (Persons)	3.1.17.
3.03	Superimposed Major Occupancies:	No □ Yes				3.2.2.7.			BUILDING B GROUP F-2 AS PER CLIENT	
		Description: N/A								
3.04	Building Area (m2)	·	· ·	New 3,001 M ²	Total 3,001 M ²	[A] 1.4.1.2.				
		BOILDING 2 (B)		<u> </u>	3,001 1012					
							3.19	Barrier-free Design:	Yes ****THIS PERMIT APPLICATION IS FOR CORE AND SHELL OF TWO BUILDING, TENANT FIT-OUT WILL BE IN A SEPARATE PERMIT No	
		Total		3,001 M ²	3,001 M ²		3.20	Hazardous Substances:	Yes ****THIS PERMIT APPLICATION IS FOR CORE AND SHELL OF TWO BUILDING, TENANT FIT-OUT WILL BE IN A SEPARATE PERMIT No	.1.2. & 3.3.1.19.
3.05	Gross Area (m2)	Description: E: BUILDING 2 (B)	· ·	1,062 M ²	Total 4,062 M ²	[A] 1.4.1.2.	3.21	Required Fire Resistance	Horizontal Assembly Rating Supporting Noncombustible	3.2.2.20 83. 3.2.1.4.
				-				Ratings		
		Tatal	1	1,062 M ²	4,062 M ²				Floors over basement	
3.06	Mezzanine Area	Total Description: E		New	Total	3.2.1.1.			Mezzanine 45M □ No ■ Yes □ N/A	
0.00	(m2)	BUILDING 2 (B)	· ·	,060 M ²	1,060 M ²	0.2			Roof No Yes N/A	
							3.22	Spatial Separation	Wall EBF L.D. L/H Required Construction Type Cladding Type Area (m) or FRR (H) Required Required (m2) H/L	3.2.3.
		Total	1	,060 M ²	1,060 M ²			BUILDING B	SOUTH 216 <15	
3.07	Building Height	Storeys above grade Storeys below grade	9 (r	m) Above	grade	[A] 1.4.1.2. & 3.2.1.1.			NORTH 1,407	
3.08	High Building	No □ Yes				3.2.6.			Noncombustible ☐ Noncombustible Noncombustible ☐ Noncombustible Noncombustible ☐ Noncombustible	
3.09	Number of Streets/ Firefighter access	BUILDING B: FOUR (4) STREET				3.2.2.10. &			Noncombustible Noncombustible	
3.10	Building	3.2.2.72. GROUP F, DIVISION 2, UP TO 2	STOREVS	SPRINKI	ERED.	3.2.5. 3.2.2.20 83.	3.23	Plumbing Fixture Requirements	Ratio: Male:Female = 50:50 Except as noted otherwise	3.7.4.
	Classification: (Size and Construction Relative to Occupancy)	BUILDING B	OTORETO,	OF TAINITE	LINED				Floor Level/Area Occupant OBC Fixtures Fixtures Load Reference Required Provided	
3.11	Sprinkler System	■ Required □ Not Required Proposed: ■ entire building □ selected floor areas □ □ in lieu of roof rating □		ompartmen	nts	3.2.1.5. & 3.2.2.17.	_		THIS PERMIT APPLICATION IS FOR CORE & SHELL OF ONE BUILDING. TENANT FIT OUT WILL BE IN A SEPARATE PERMIT	
3.12	Standpipe System	■ Not required □ Required				3.2.9.				
3.13	Fire Alarm System	■ Required □ Not required Proposed: □ Single stage ■ Two	stage □ No	ne		3.2.4./ 3.2.4.1.2	3.24	Energy Efficiency:	Compliance Path: Climatic Zone: ZONE 6A	
3.14	Water Service / Supply is Adequate	□ No ■ Yes					3.25	Notes:	Climatic Zone. Zone on	
3.15	Construction Type:	Restriction: Combustible permitted			•	3.2.2.20 83. & 3.2.1.4.				
		Actual: ☐ Combustible ☐ Non-com Heavy Timber Construction: ☐ No ☐ Yes	on		1	All references are	o Division B of the OBC unless preceded by [A] for Division A and [C] for Division C.			

powers brown archit ecture

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PROJECT TITLE

7242 HWY 27, VAUGHAN, ON

7242 HWY 27, VAUGHAN

A PROJECT FOR

NCAP NICOLA (HWY27) LTD.

2023-06-15 ISSUED FOR SPA 2 2023-10-11 RE-ISSUED FOR SPA 3 2024-01-12 RE-ISSUED FOR SPA 4 2024-03-01 RE-ISSUED FOR SPA 5 2024-05-09 RE-ISSUED FOR SPA 6 2024-05-30 ISSUED FOR MINOR SITE DEVELOPMENT


PROJECT NO: 215073 DRAWN BY: EL CHECKED BY: LD

CODE SUMMARY (BUILDING

OF ARCHITECTS Z
RASHAD HINDI LICENCE

2024-05-30

SHEET NUMBER

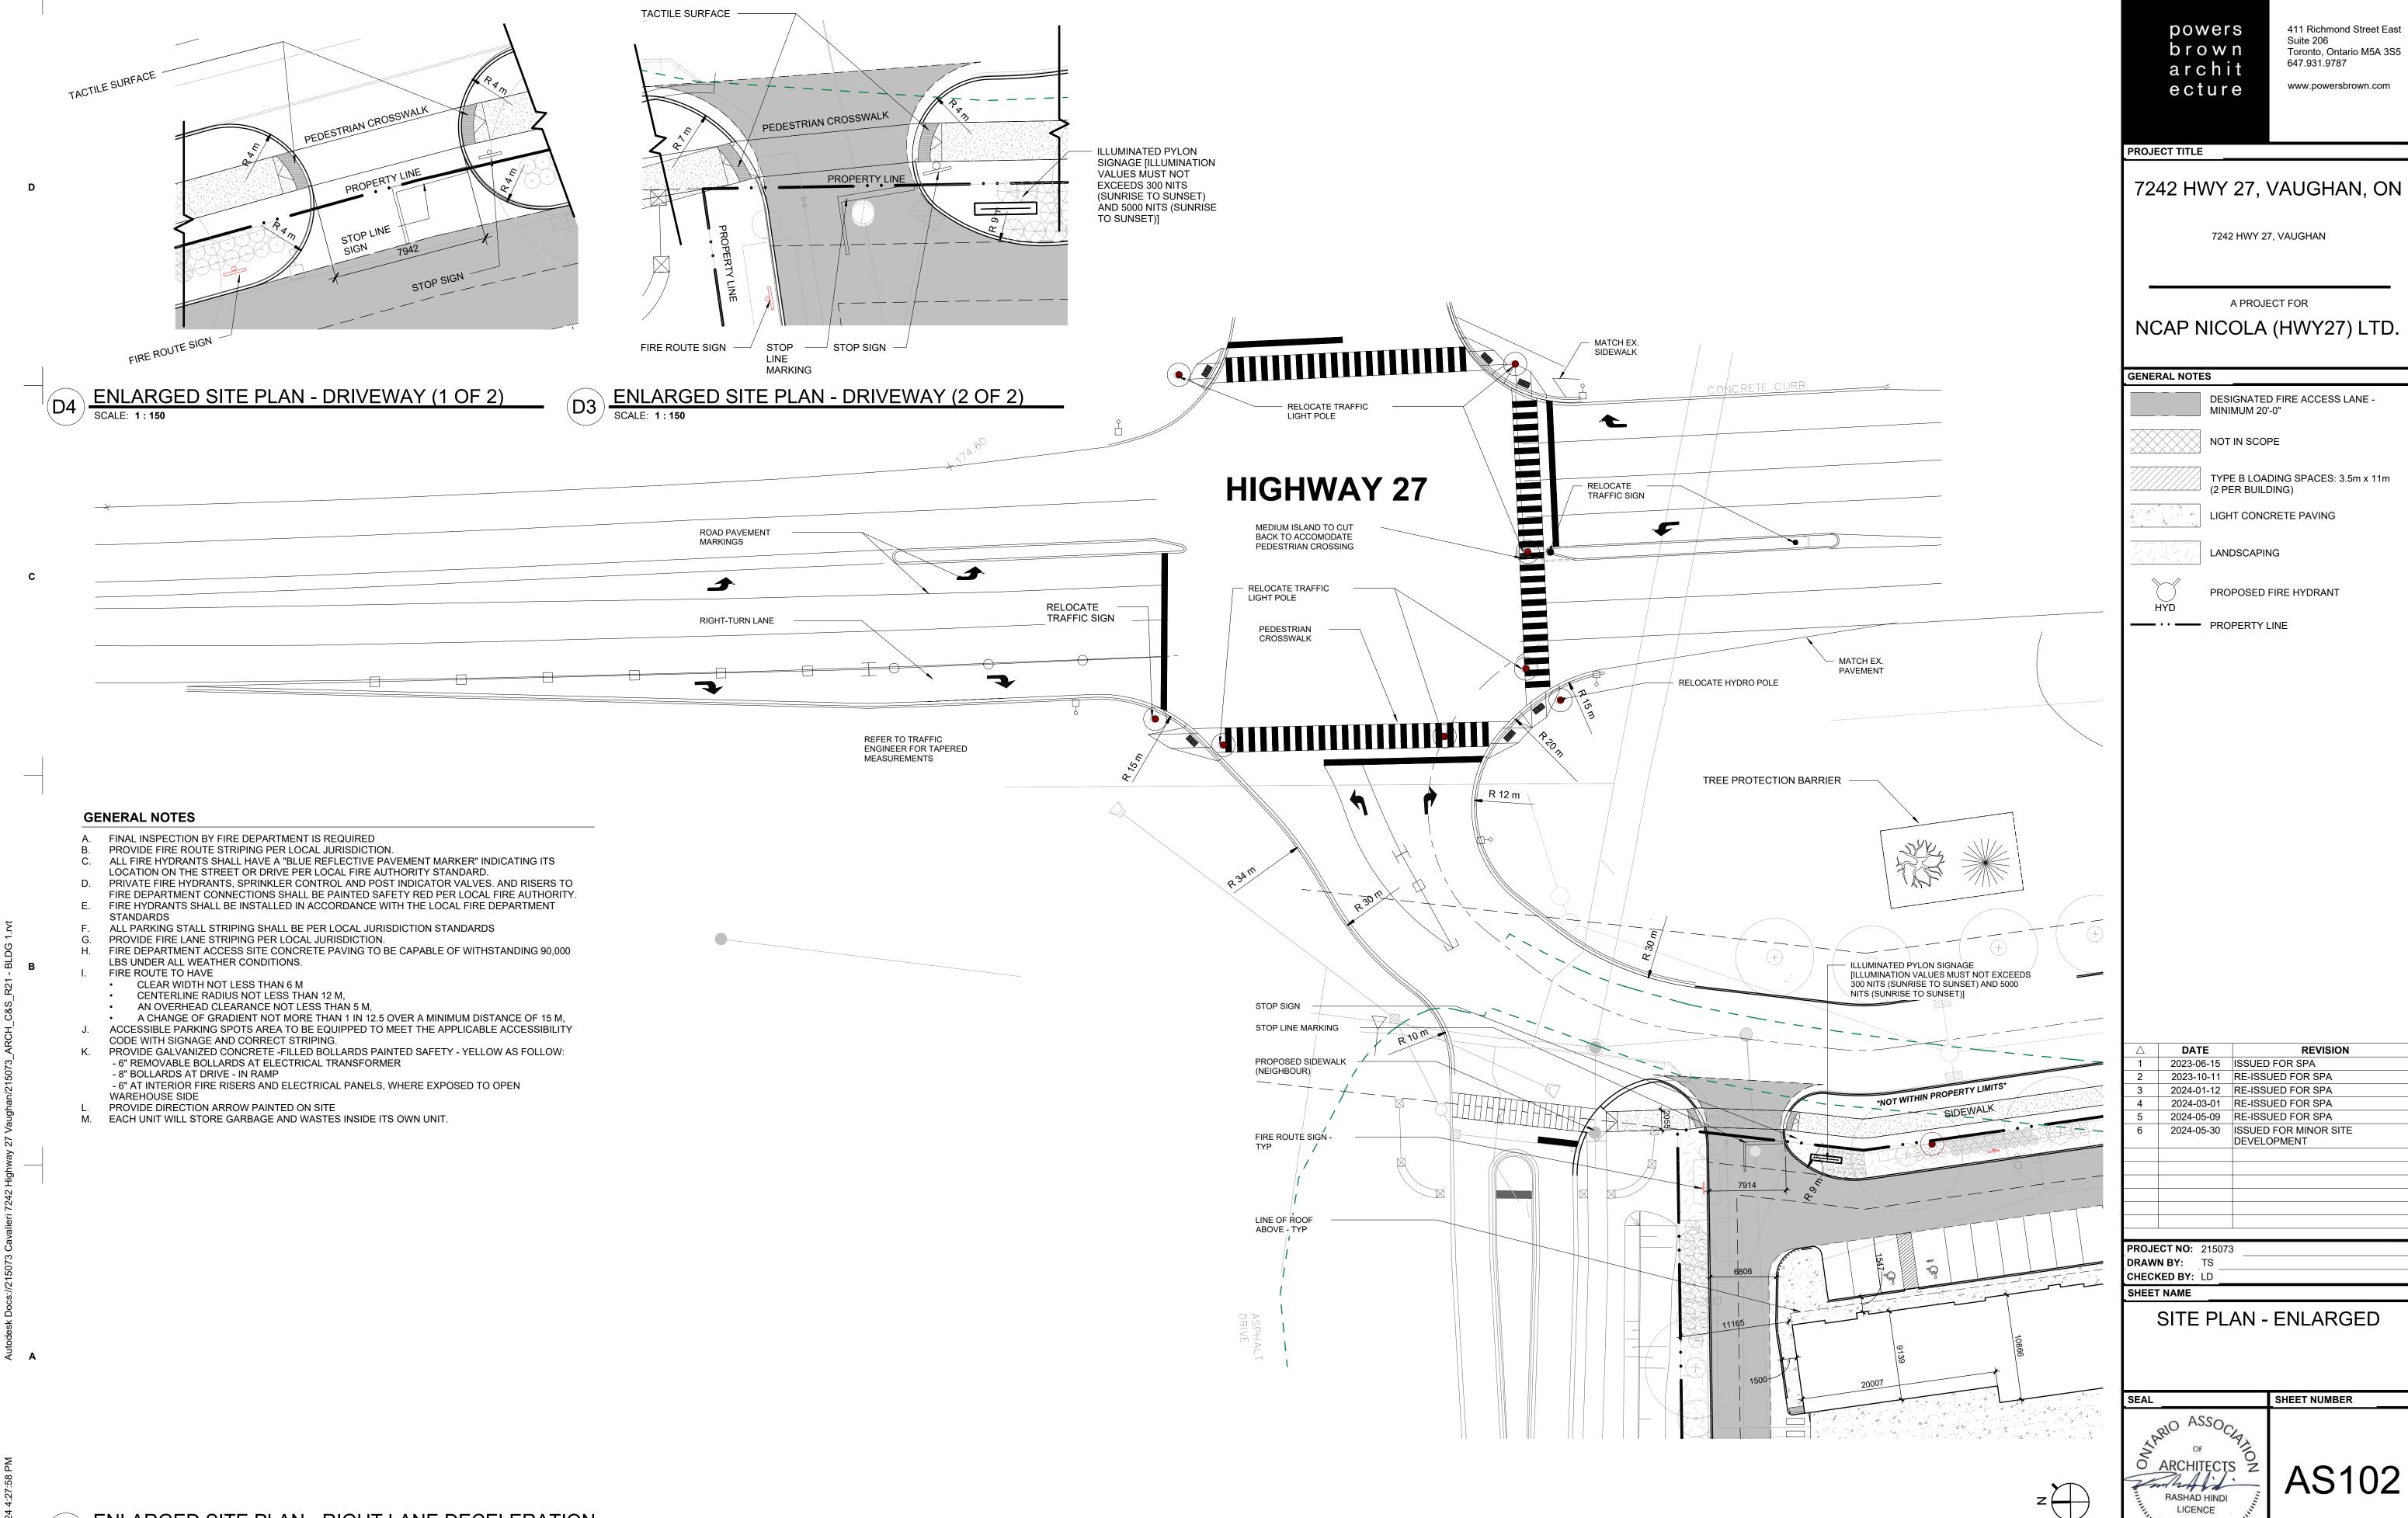


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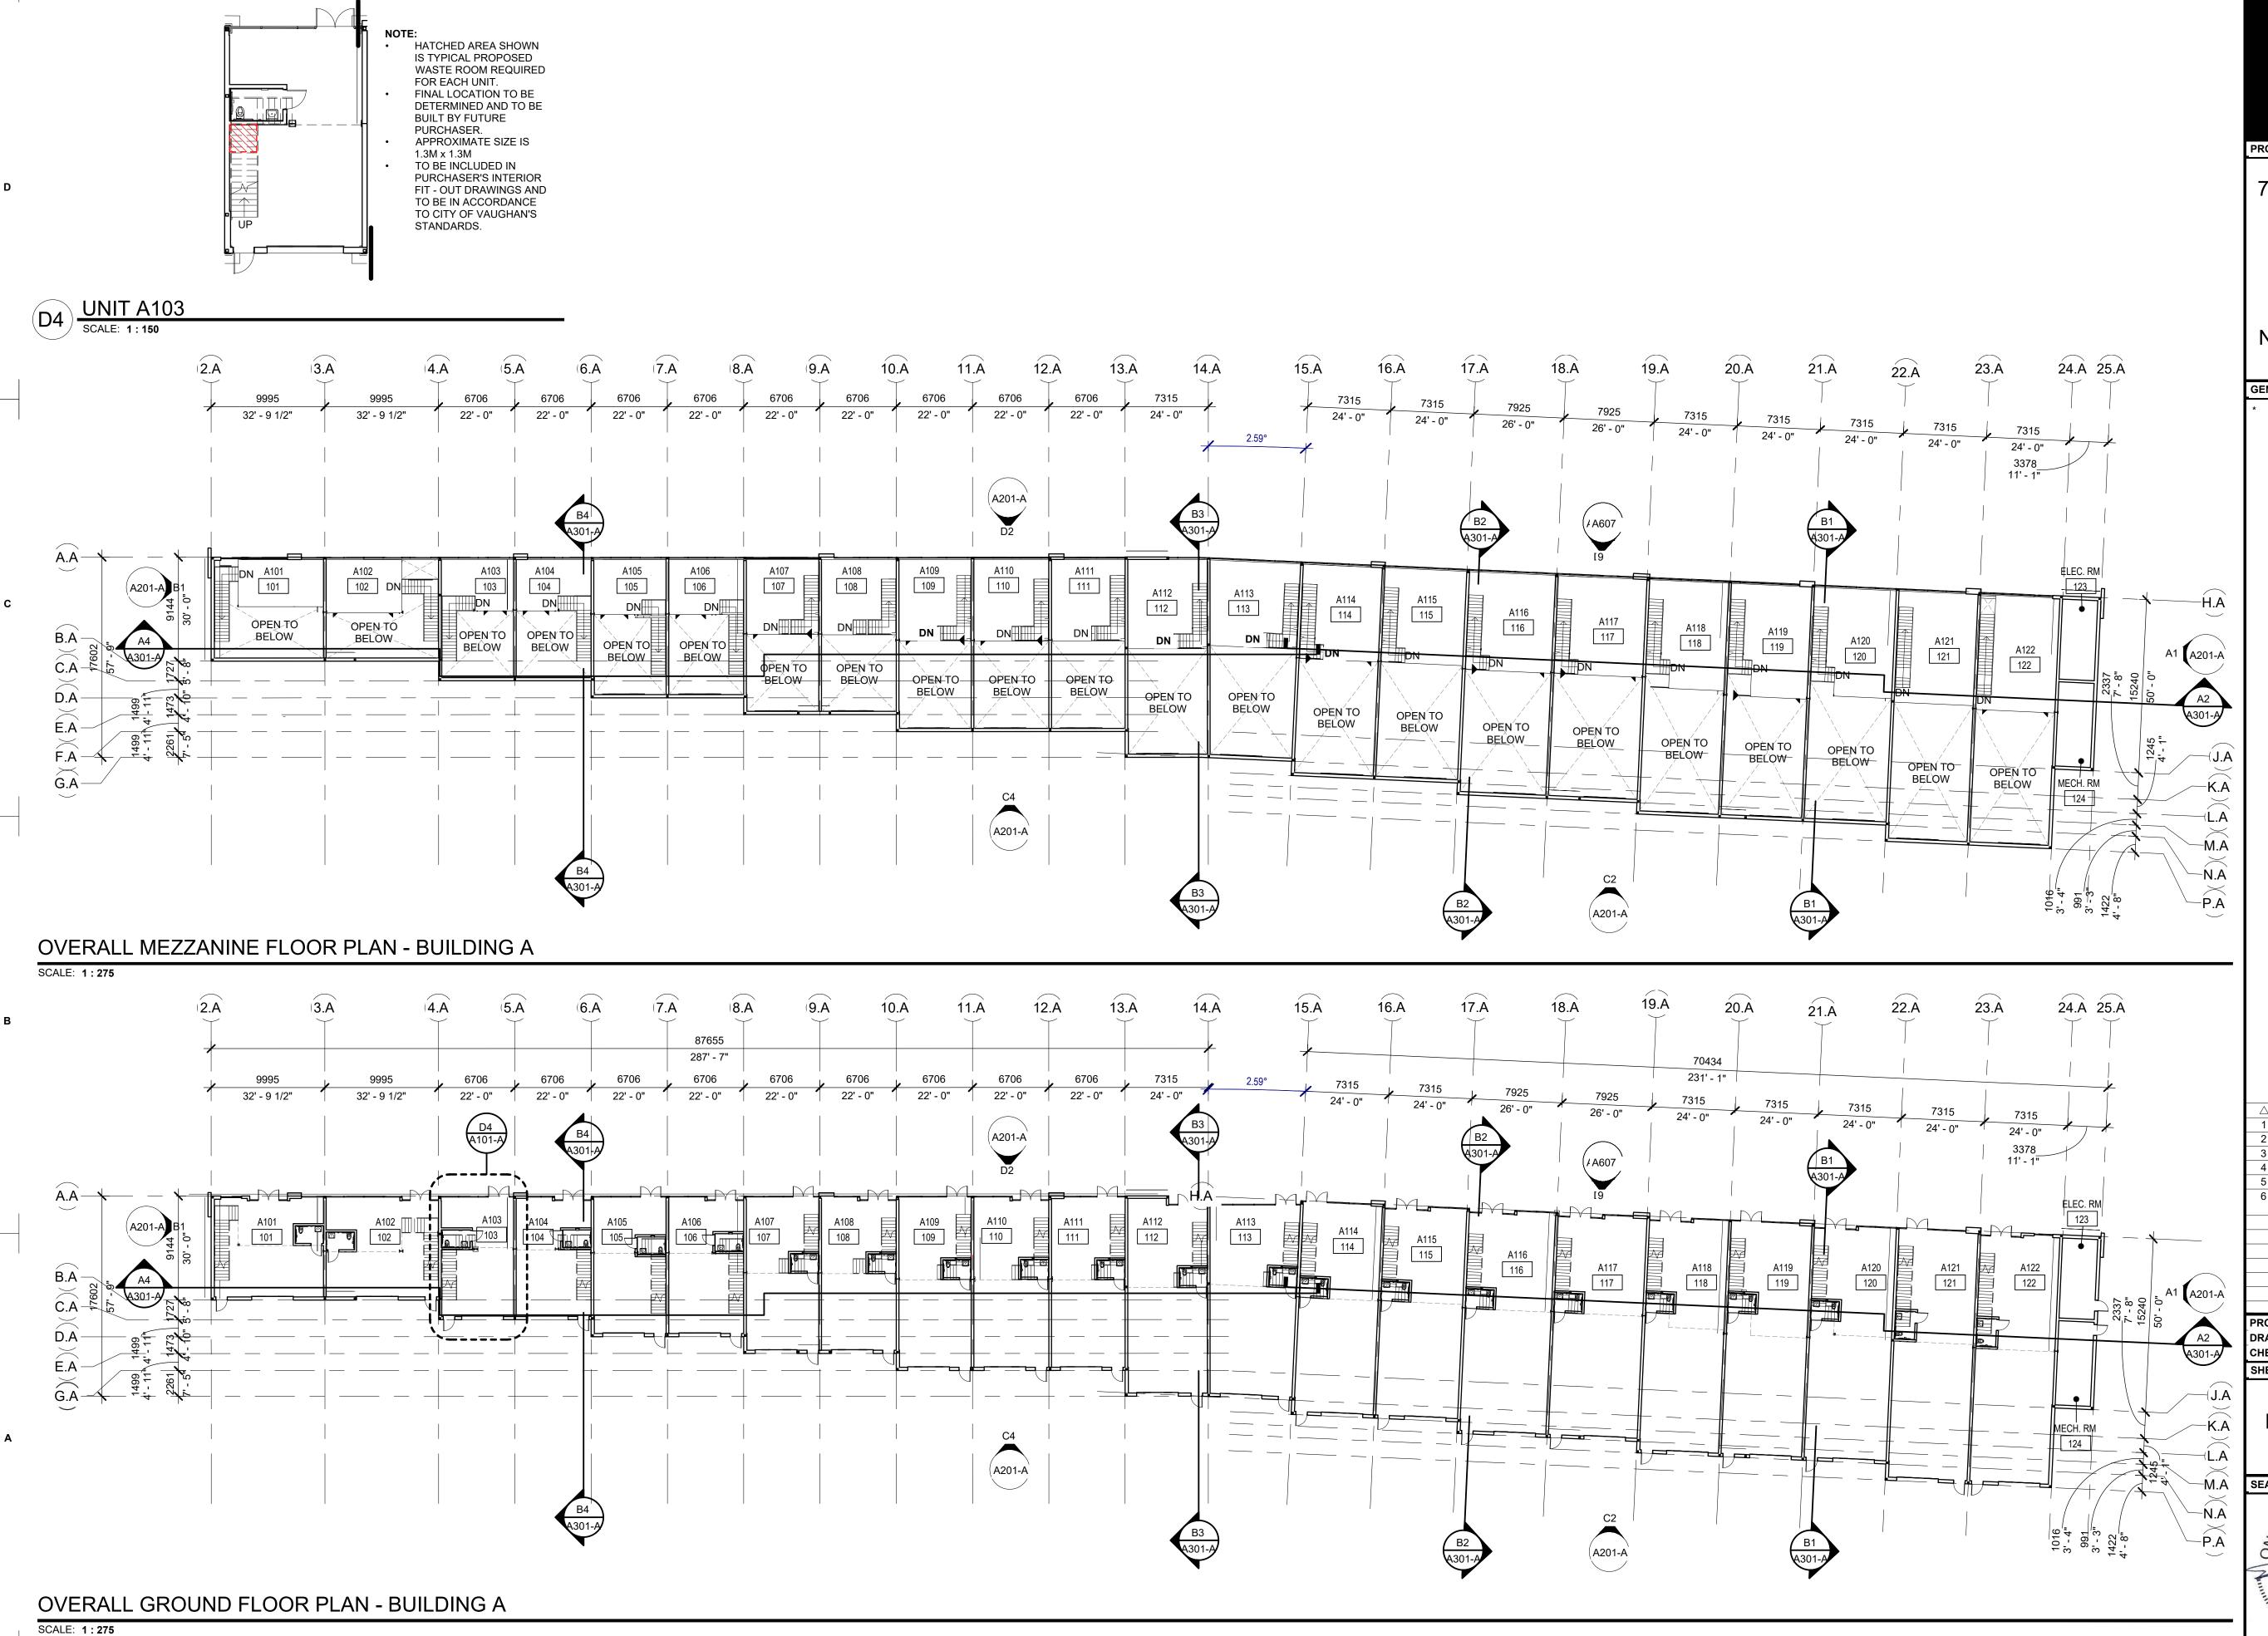
ENLARGED SITE PLAN - RIGHT LANE DECELERATION

6646 2024-05-30

Toronto, Ontario M5A 3S5

TYPE B LOADING SPACES: 3.5m x 11m 2024-03-01 PERFECT ENGINEERING SUBMISSION 2024-05-09 PERFECT ENGINEERING SUBMISSION



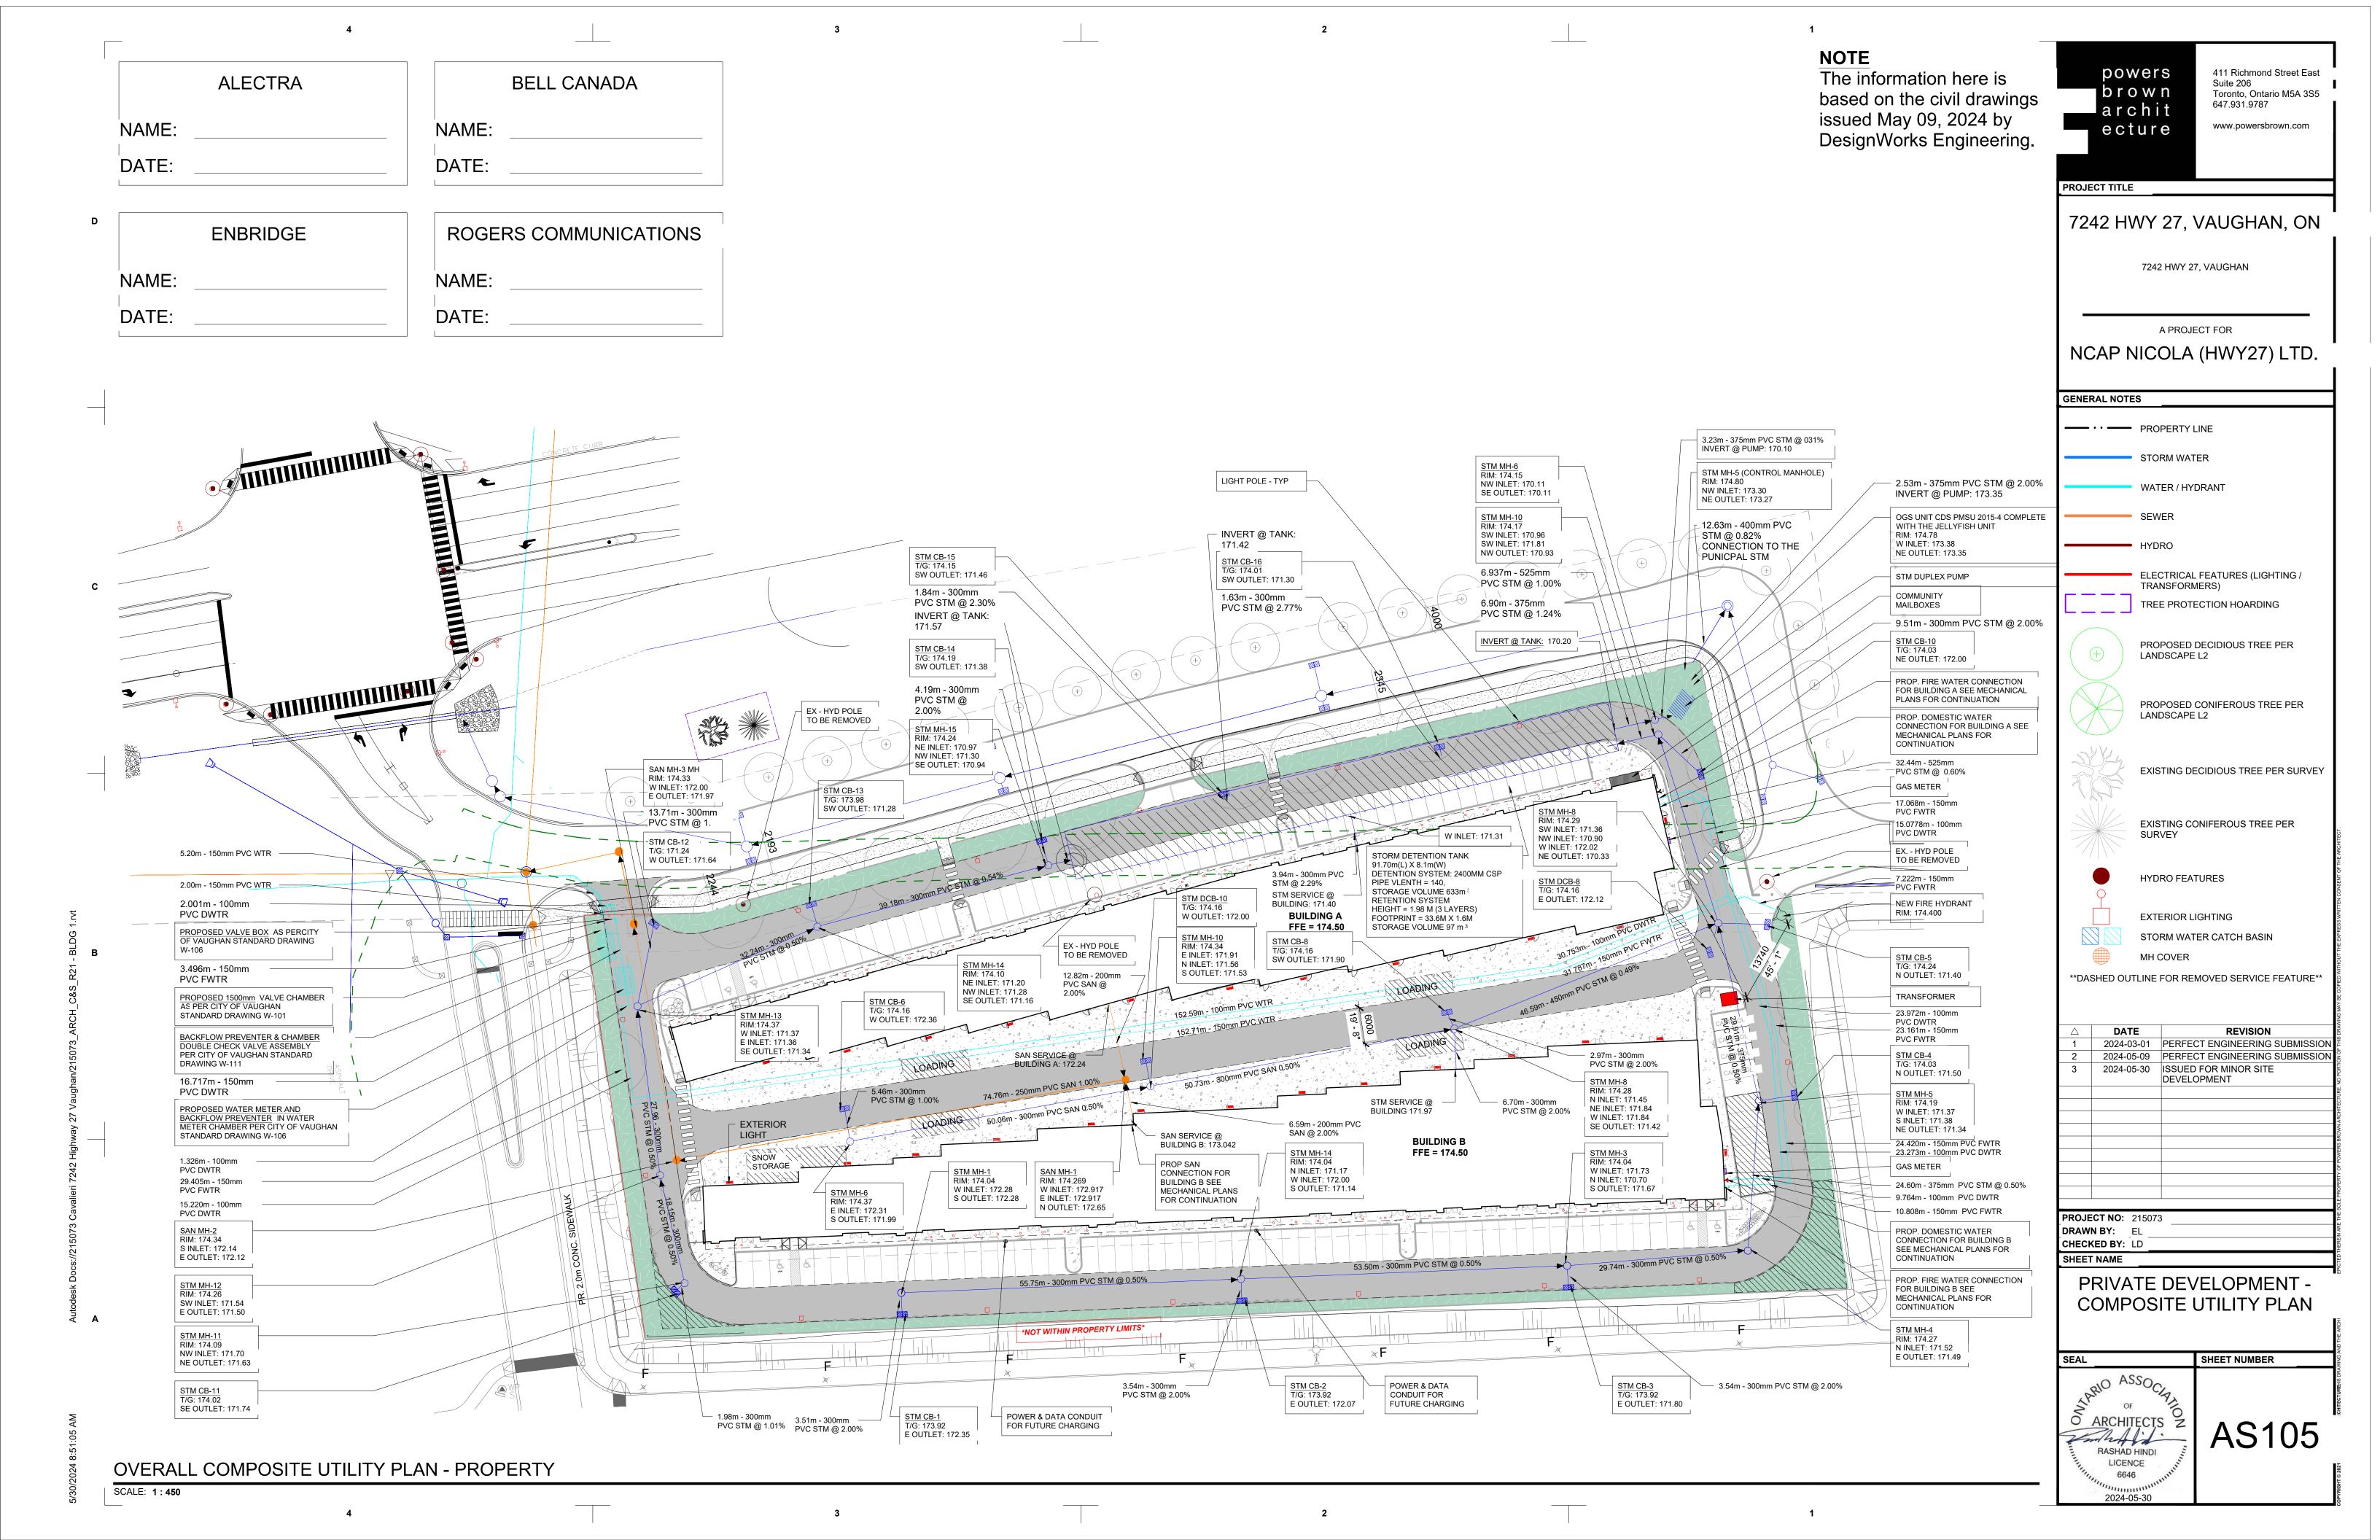

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PROJECT TITLE

7242 HWY 27, VAUGHAN, ON

7242 HWY 27, VAUGHAN

NCAP NICOLA (HWY27) LTD.

A PROJECT FOR

GENERAL NOTES

WASHROOM ARE SHOWN FOR ILLUSTRATIVE PURPOSES ONLY AND ONLY ROUGH-INS WILL BE PROVIDED

 △
 DATE
 REVISION

 1
 2023-06-15
 ISSUED FOR SPA

 2
 2023-10-11
 RE-ISSUED FOR SPA

 3
 2024-01-12
 RE-ISSUED FOR SPA

 4
 2024-03-01
 RE-ISSUED FOR SPA

 5
 2024-05-09
 RE-ISSUED FOR MINOR SITE DEVELOPMENT

PROJECT NO: 215073
DRAWN BY: TS
CHECKED BY: LD


OVERALL GROUND AND MEZZANINE FLOOR PLAN -BUILDING A

OF ARCHITECTS Z
RASHAD HINDI
LICENCE
6646

2024-05-30

A101-A

SHEET NUMBER

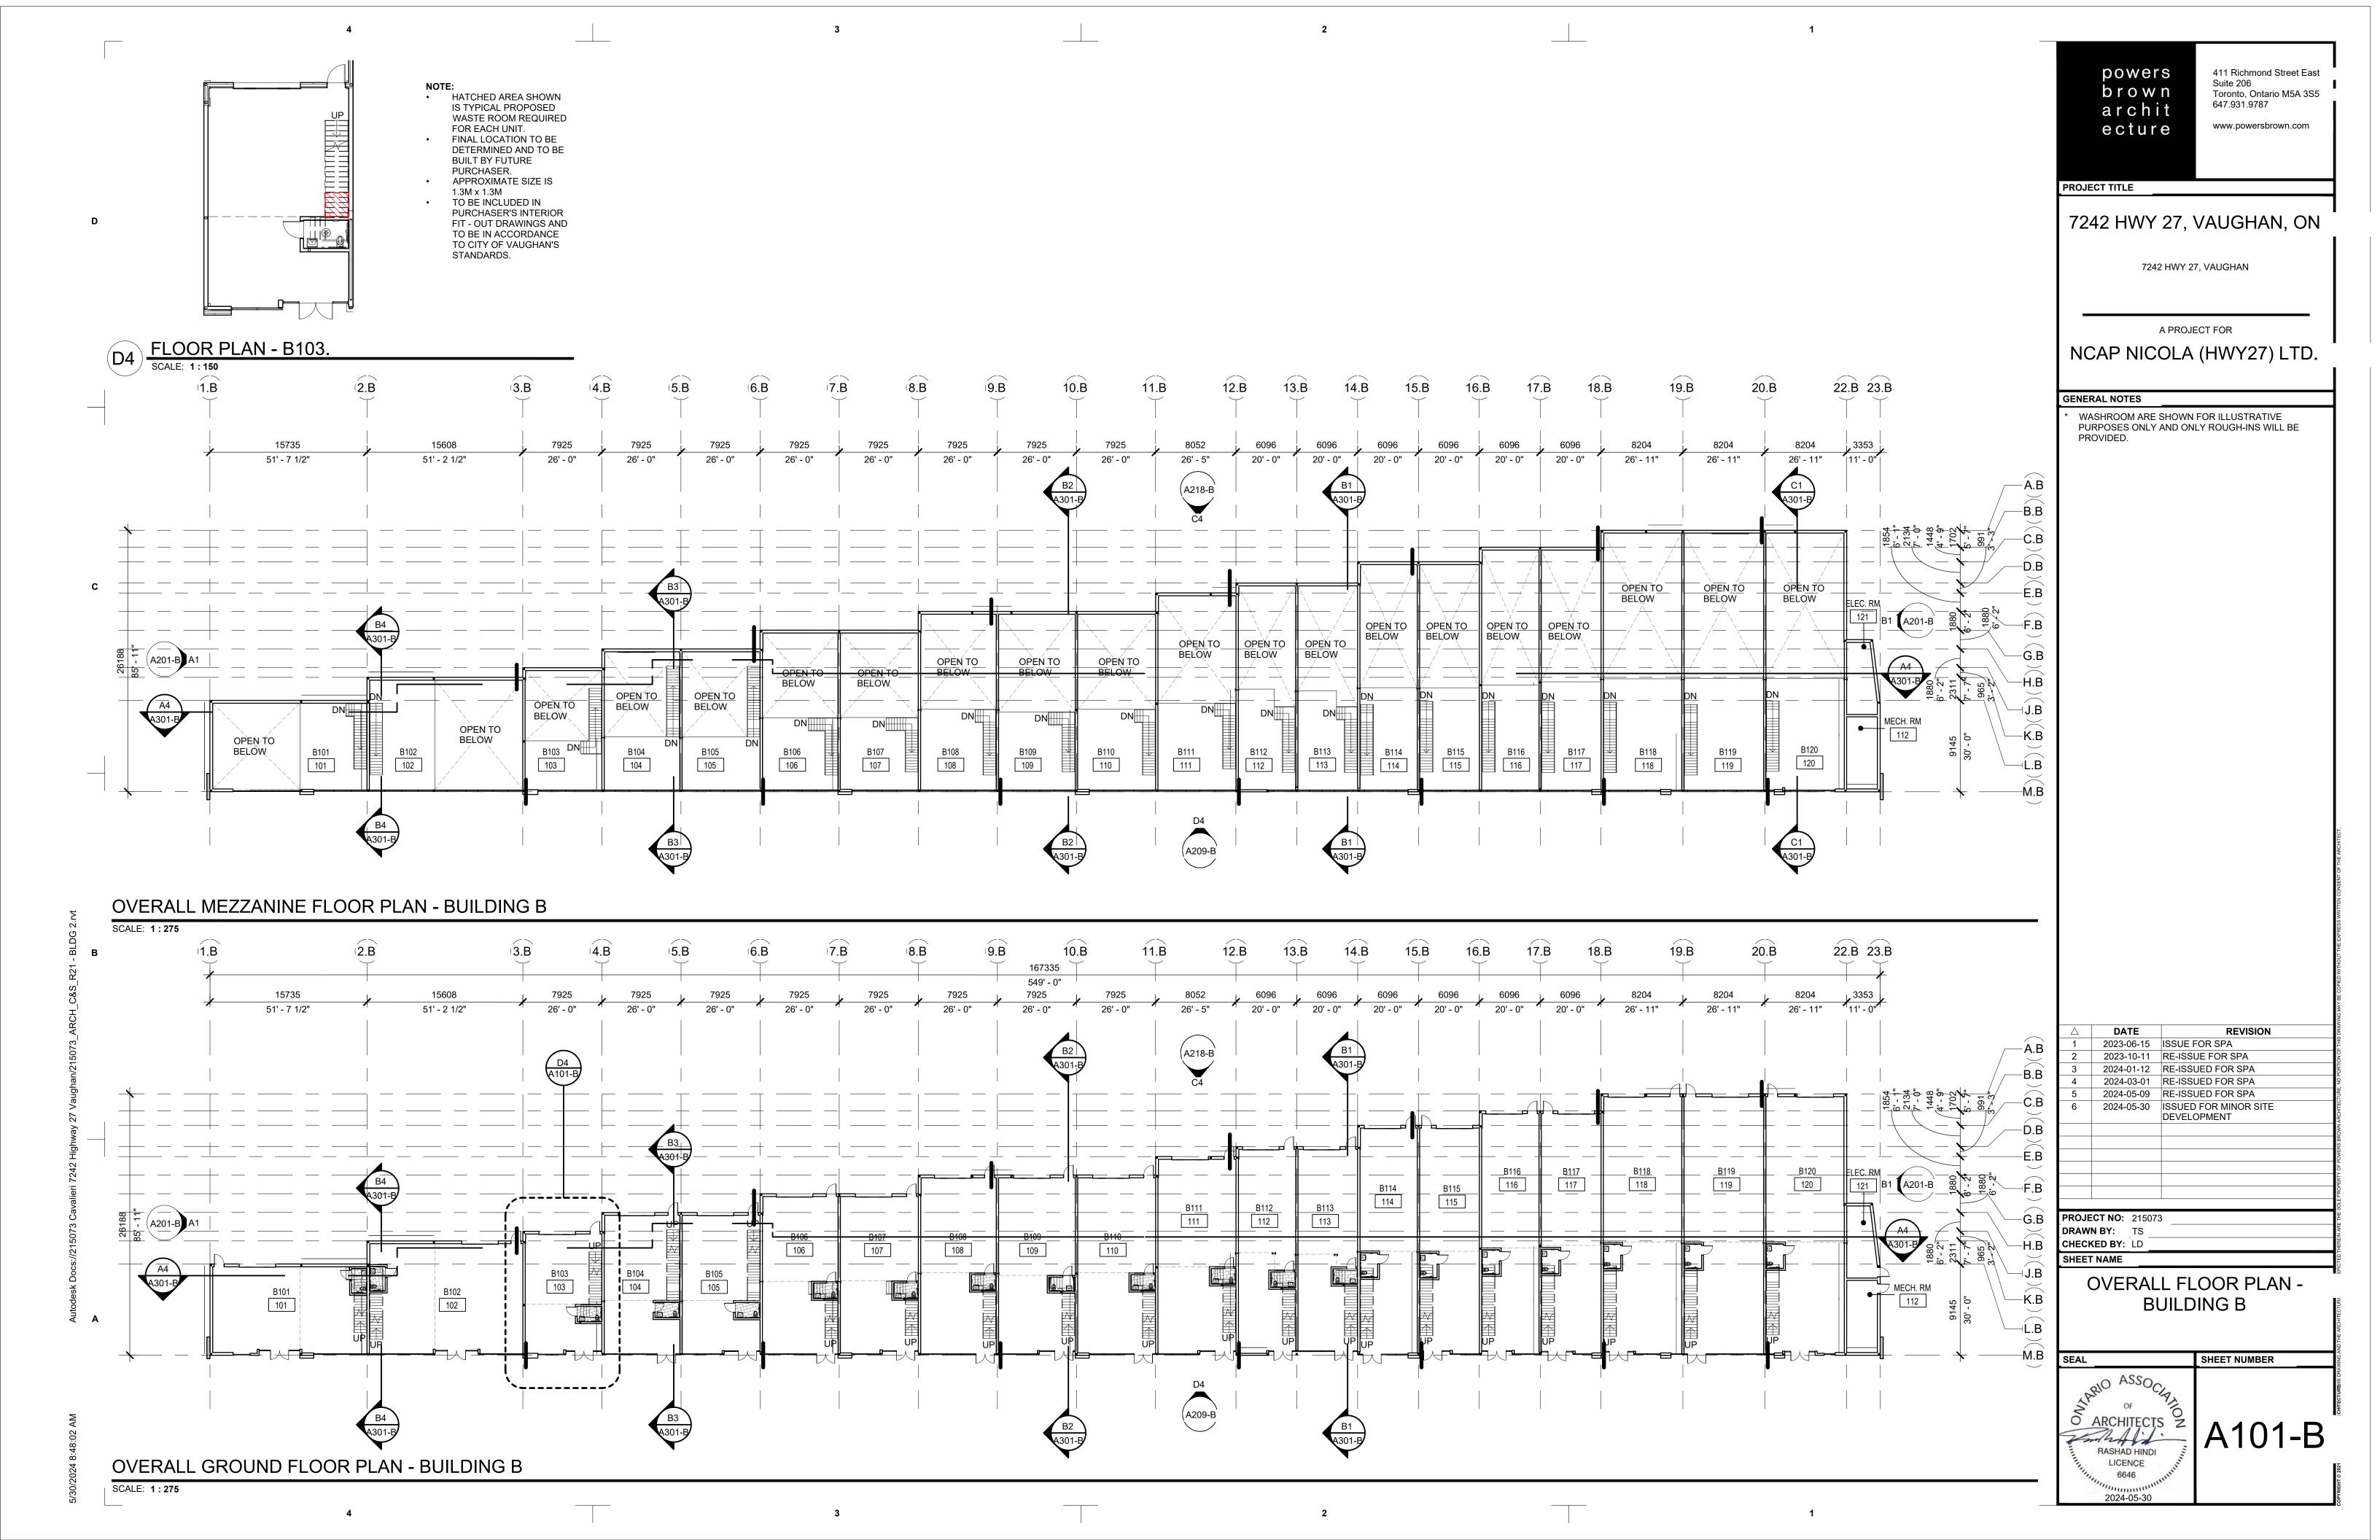

BUILDING A BUILDING AREA (M²)	PROPOSED
GROSS FLOOR AREA, AS DEFINED IN GREEN STANDARD (M ²)	3,393.66 M²
TOTAL ROOF AREA (M²)	2,903.04 M ²
ROOF COVERAGE	

SINGLE - PLY WHITE TPO ROOF (R40MIN) - 100% OF THE ROOF SPACE TPO MEMBRANE TO COMPLIES WITH REQUIREMENTS OF A MINIMUM SOLAR REFLECT INDEX (SRI) OF 79 FOR INDUSTRIAL BUILDINGS (AS PER COOL ROOF ALTERNATIVE TO THE GREEN REQUIREMENTS FOR INDUSTRIAL BUILDINGS.

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PROJECT TITLE

7242 HWY 27, VAUGHAN, ON

7242 HWY 27, VAUGHAN


A PROJECT FOR

NCAP NICOLA (HWY27) LTD.

GENERAL NOTES

TAPERED INSULATION - 1/4" PER 1 FOOT SLOPE - TYP

OVERFLOW SCUPPER ROOF DRAIN

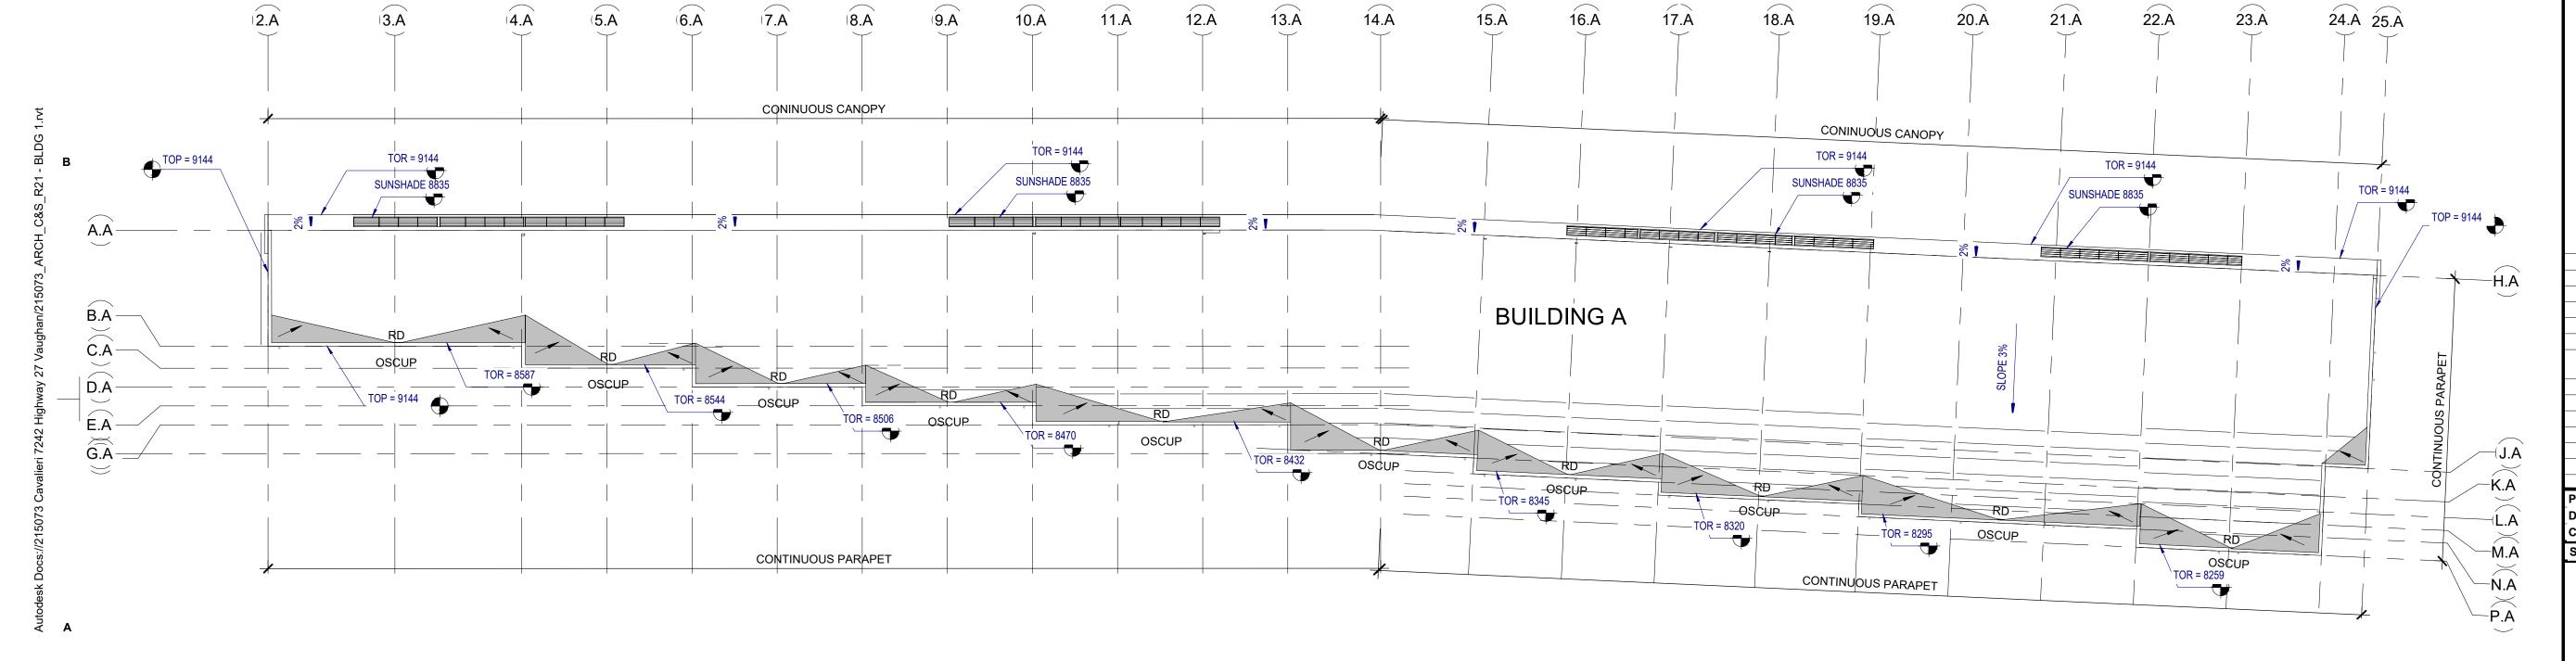

PROJECT NO: 215073 DRAWN BY: TS CHECKED BY: LD SHEET NAME

REVISION

OVERALL ROOF PLAN -**BUILDING A**

2023-06-15 ISSUED FOR SPA 2023-10-11 RE-ISSUED FOR SPA

2024-01-12 RE-ISSUED FOR SPA 2024-03-01 RE-ISSUED FOR SPA 2024-05-09 RE-ISSUED FOR SPA

2024-05-30 ISSUED FOR MINOR SITE DEVELOPMENT

SHEET NUMBER LICENCE 2024-05-30

A110-A

OVERALL ROOF PLAN - BUILDING A

SCALE: 1:275

BUILDING B BUILDING AREA (M²) PROPOSED GROSS FLOOR AREA, AS DEFINED IN GREEN STANDARD (M 2) 3,854.20 M² TOTAL ROOF AREA (M²) 3,225.09 M² ROOF COVERAGE

SINGLE - PLY WHITE TPO ROOF (R40MIN) - 100% OF THE ROOF SPACE TPO MEMBRANE TO COMPLIES WITH REQUIREMENTS OF A MINIMUM SOLAR REFLECT INDEX (SRI) OF 79 FOR INDUSTRIAL BUILDINGS (AS PER COOL ROOF ALTERNATIVE TO THE GREEN REQUIREMENTS FOR INDUSTRIAL BUILDINGS.


powers 411 Richmond Street East Suite 206 brown Toronto, Ontario M5A 3S5 647.931.9787 archit www.powersbrown.com ecture PROJECT TITLE 7242 HWY 27, VAUGHAN, ON 7242 HWY 27, VAUGHAN A PROJECT FOR NCAP NICOLA (HWY27) LTD. **GENERAL NOTES** TAPERED INSULATION - 1/4" PER 1 FOOT SLOPE - TYP OVERFLOW SCUPPER RD TOP TOR ROOF DRAIN TOP OF PARAPET TOP OF ROOF REVISION 2023-06-15 ISSUE FOR SPA 2023-10-11 RE-ISSUE FOR SPA 2024-01-12 RE-ISSUED FOR SPA 2024-03-01 RE-ISSUED FOR SPA 2024-05-09 RE-ISSUED FOR SPA 2024-05-30 ISSUED FOR MINOR SITE DEVELOPMENT **PROJECT NO:** 215073 DRAWN BY: TS CHECKED BY: LD OVERALL ROOF PLAN -

BUILDING B


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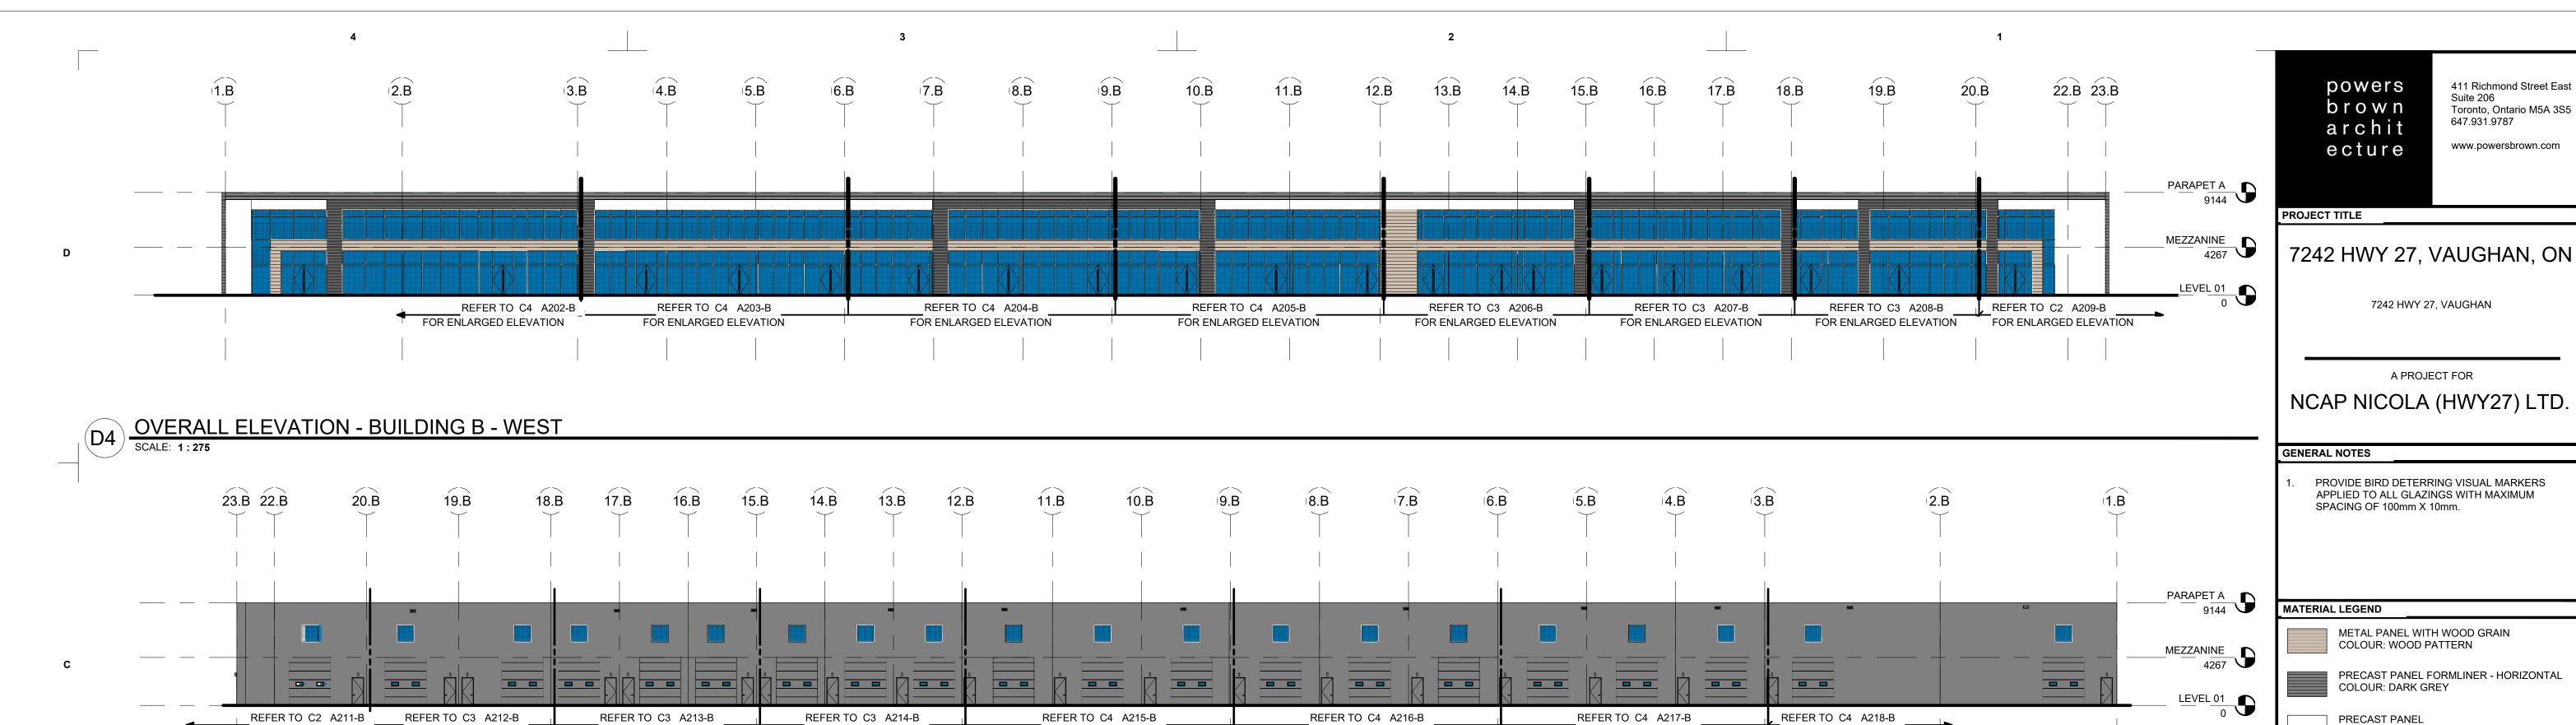
2024-05-30

A110-B

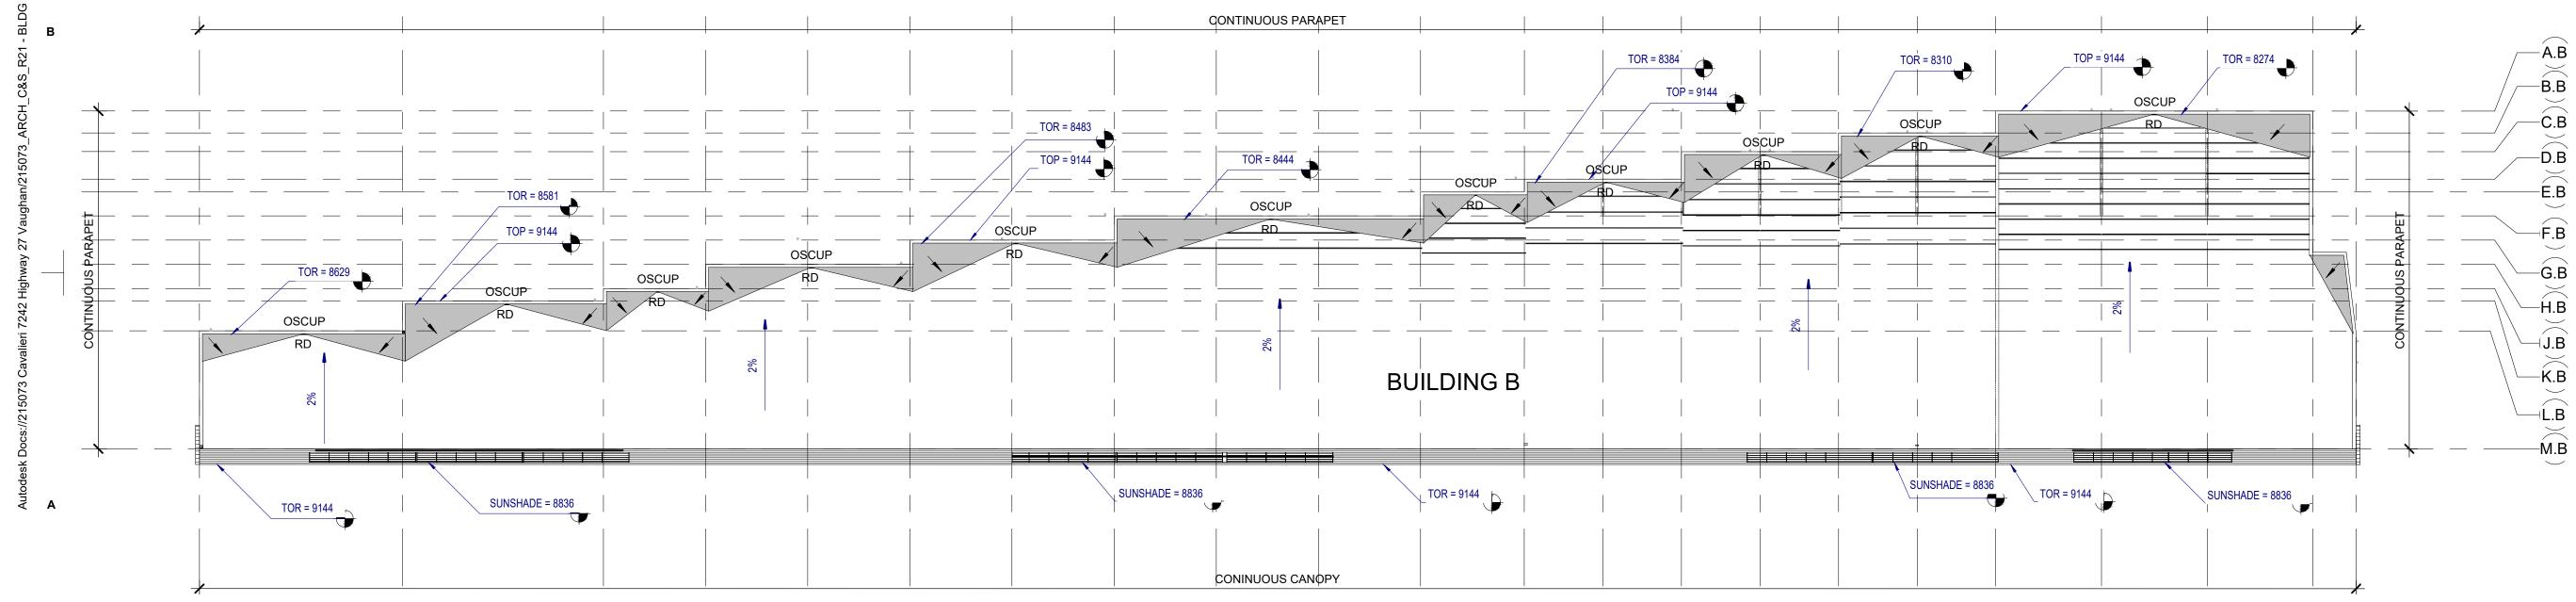

SCALE: 1:275



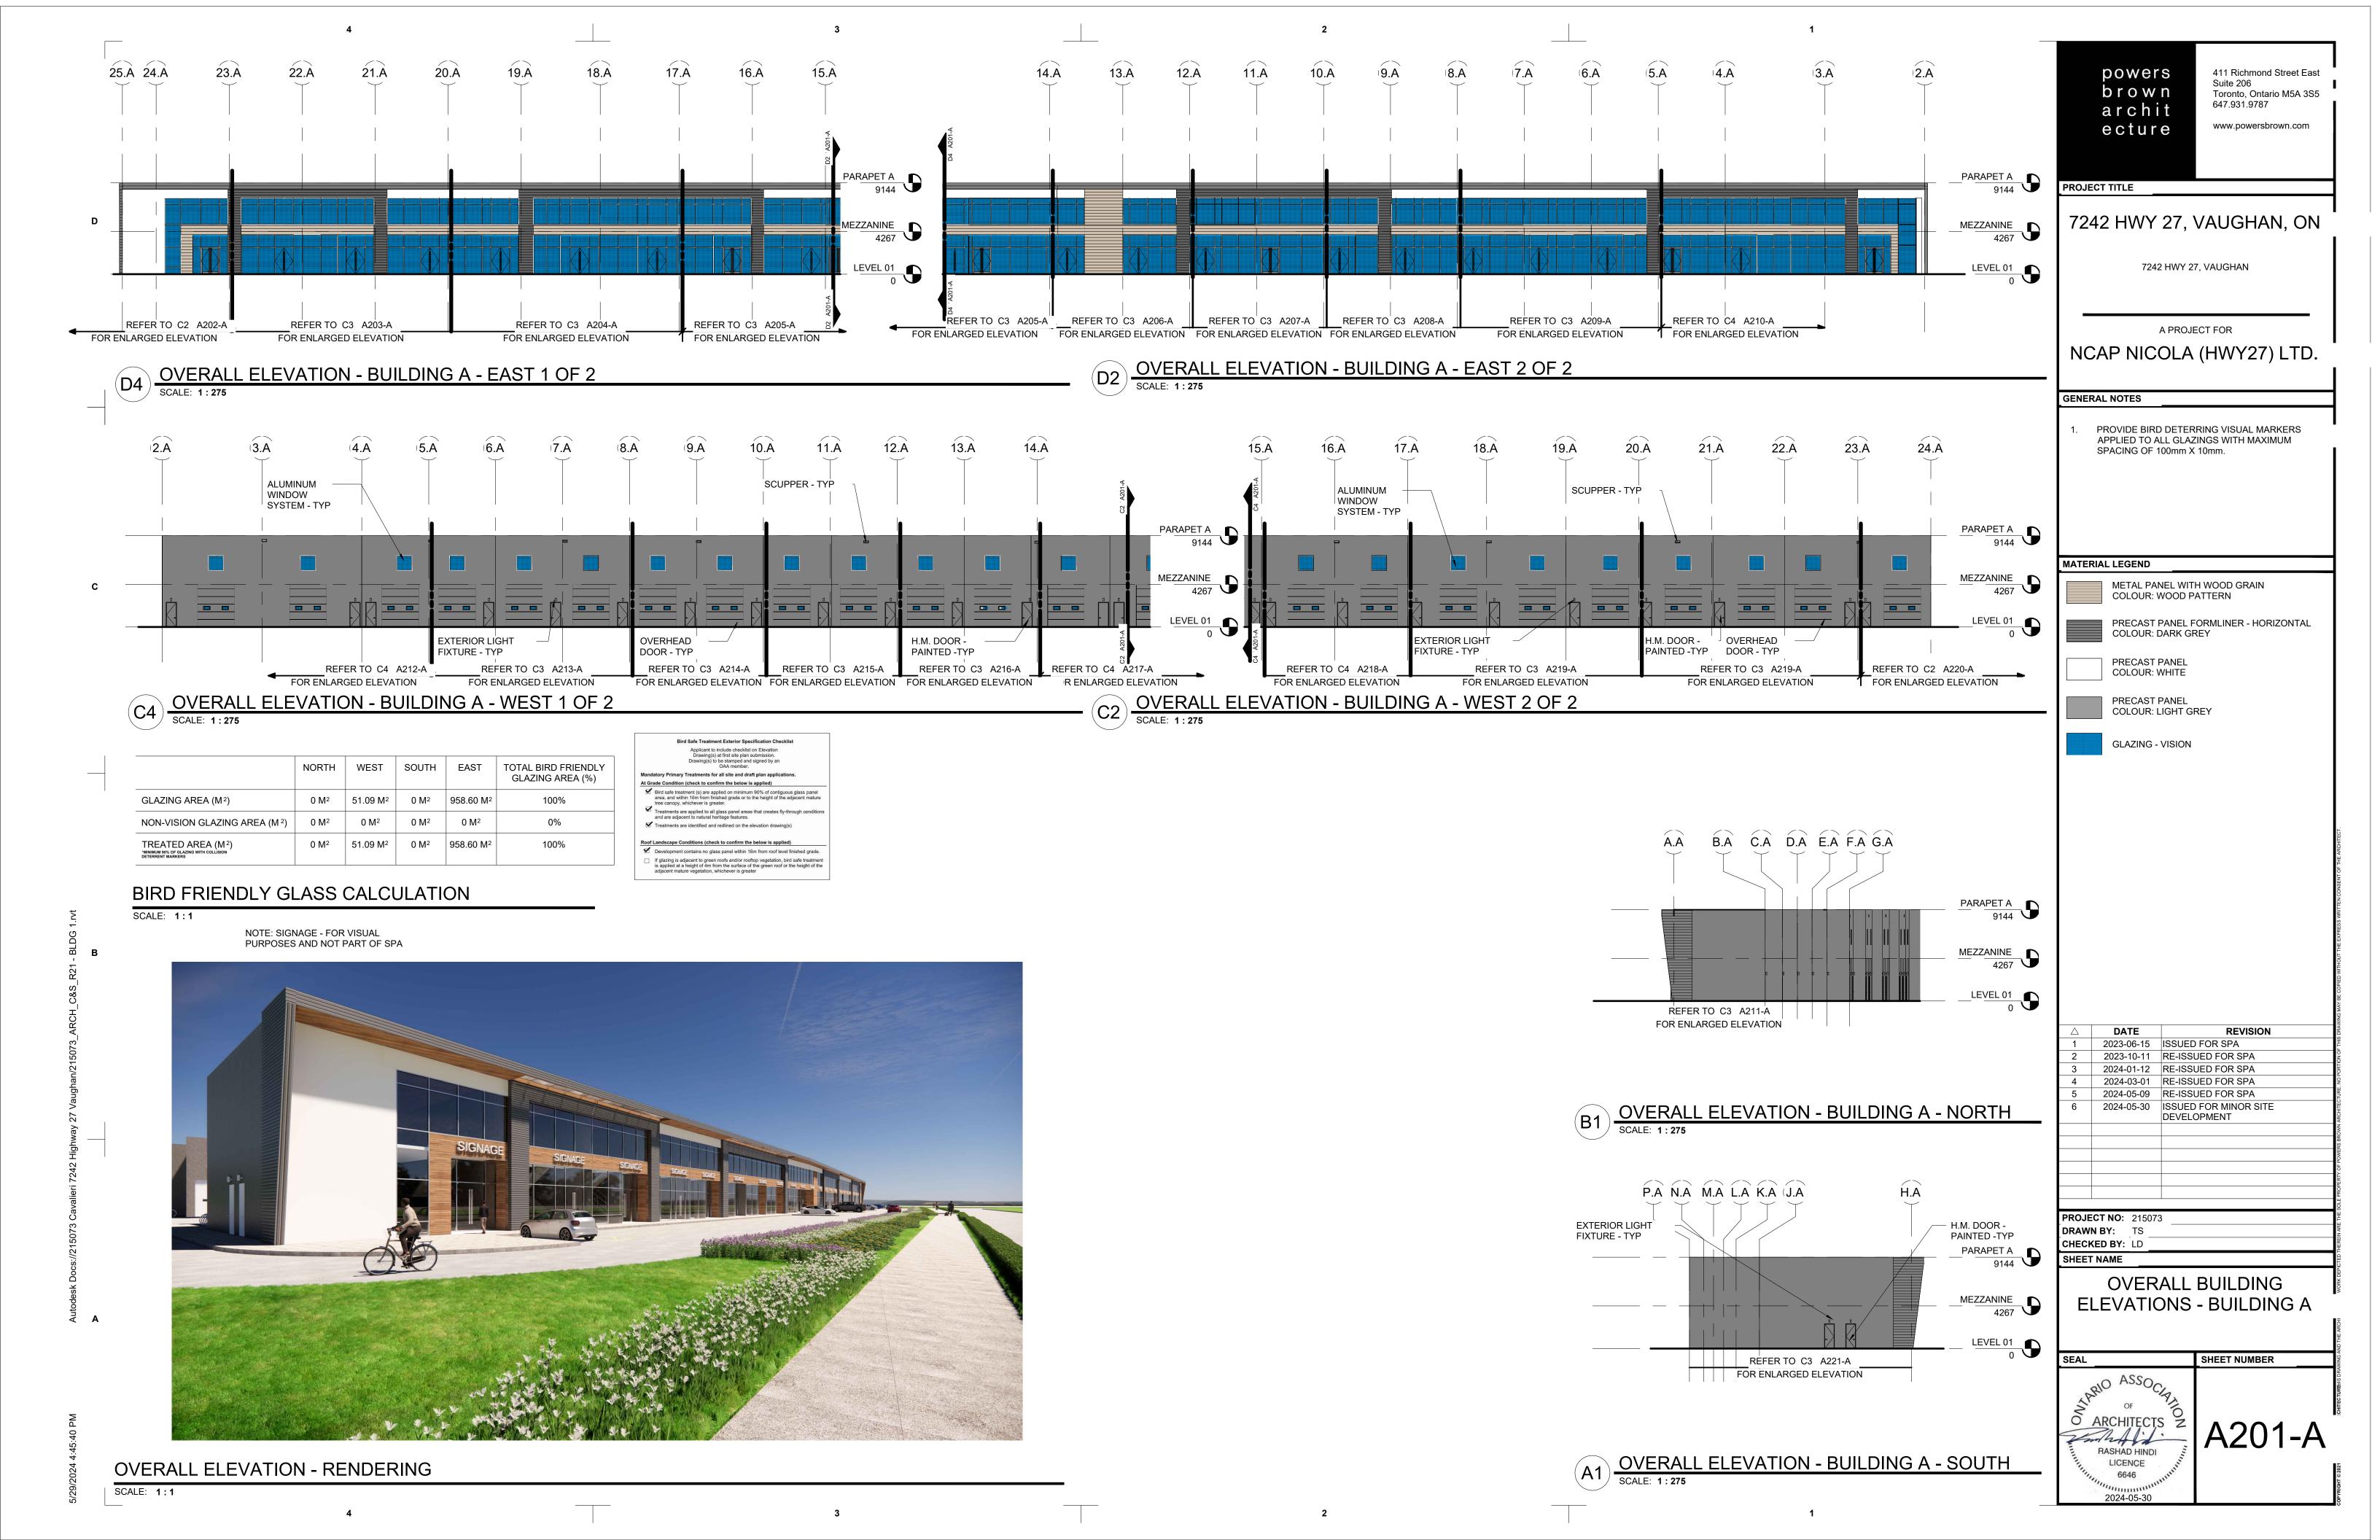

FOR ENLARGED ELEVATION

FOR ENLARGED ELEVATION

OVERALL ELEVATION - BUILDING B - EAST

		NORTH	WEST	SOUTH	EAST	TOTAL BIRD FRIENDLY GLAZING AREA (%)
	GLAZING AREA (M²)	0 M ²	48.77 M ²	0 M ²	980.58 M ²	100%
_	NON-VISION GLAZING AREA (M 2)	0 M ²	0 M ²	0 M ²	0 M ²	0%
	TREATED AREA (M ²) MINIMUM 90% OF GLAZING WITH COLLISION DETERRENT MARKERS	0 M ²	48.77 M ²	0 M ²	980.58 M ²	100%

FOR ENLARGED ELEVATION

Bird Safe Treatment Exterior Specification Checklist Applicant to include checklist on Elevation Drawing(s) at first site plan submission. Drawing(s) to be stamped and signed by an OAA member. Mandatory Primary Treatments for all site and draft plan applications. At Grade Condition (check to confirm the below is applied) Treatments are applied to all glass panel areas that creates fly-through conditions and are adjacent to natural heritage features. ▼ Treatments are identified and redlined on the elevation drawing(s) Roof Landscape Conditions (check to confirm the below is applied) Development contains no glass panel within 16m from roof level finished grade.

If glazing is adjacent to green roofs and/or rooftop vegetation, bird safe treatment is applied at a height of 4m from the surface of the green roof or the height of the

FOR ENLARGED ELEVATION

FOR ENLARGED ELEVATION

BIRD FRIENDLY GLASS CALCULATION

FOR ENLARGED ELEVATION

SCALE: 1:1

NOTE: SIGNAGE - FOR VISUAL PURPOSES AND NOT PART OF SPA



OVERALL ELEVATION - RENDERING

OVERALL ELEVATION - BUILDING B - NORTH
SCALE: 1: 275

PARAPET A
9144 MEZZANINE
4267 LEVEL 01 0 / REFER TO C4 A210-B FOR ENLARGED ELEVATION EXTERIOR LIGHT FIXTURE - TYP - H.M. DOOR -PAINTED - TYP OVERALL ELEVATION - BUILDING B - SOUTH A.B B.B C.B D.B E.B F.B G.B H.B J.B K.B L.B M.B **PROJECT NO**: 215073 DRAWN BY: TS CHECKED BY: LD PARAPET A
9144 SHEET NAME MEZZANINE 4267

> REFER TO C2 A219-B FOR ENLARGED ELEVATION

M.B L.B K.B J.B H.B G.B F.B E.B D.B C.B B.B A.B

FOR ENLARGED ELEVATION

FOR ENLARGED ELEVATION

SHEET NUMBER

2024-05-30

LEVEL 01 0

OVERALL BUILDING

ELEVATIONS - BUILDING B

COLOUR: WHITE

PRECAST PANEL COLOUR: LIGHT GREY

GLAZING - VISION

DATE

2023-06-15 ISSUE FOR SPA 2023-10-11 RE-ISSUE FOR SPA 2024-01-12 RE-ISSUED FOR SPA 2024-03-01 RE-ISSUED FOR SPA

2024-05-09 RE-ISSUED FOR SPA 2024-05-30 ISSUED FOR MINOR SITE DEVELOPMENT

A201-B RASHAD HINDI LICENCE

REVISION


411 Richmond Street East


Toronto, Ontario M5A 3S5


www.powersbrown.com

Suite 206

647.931.9787

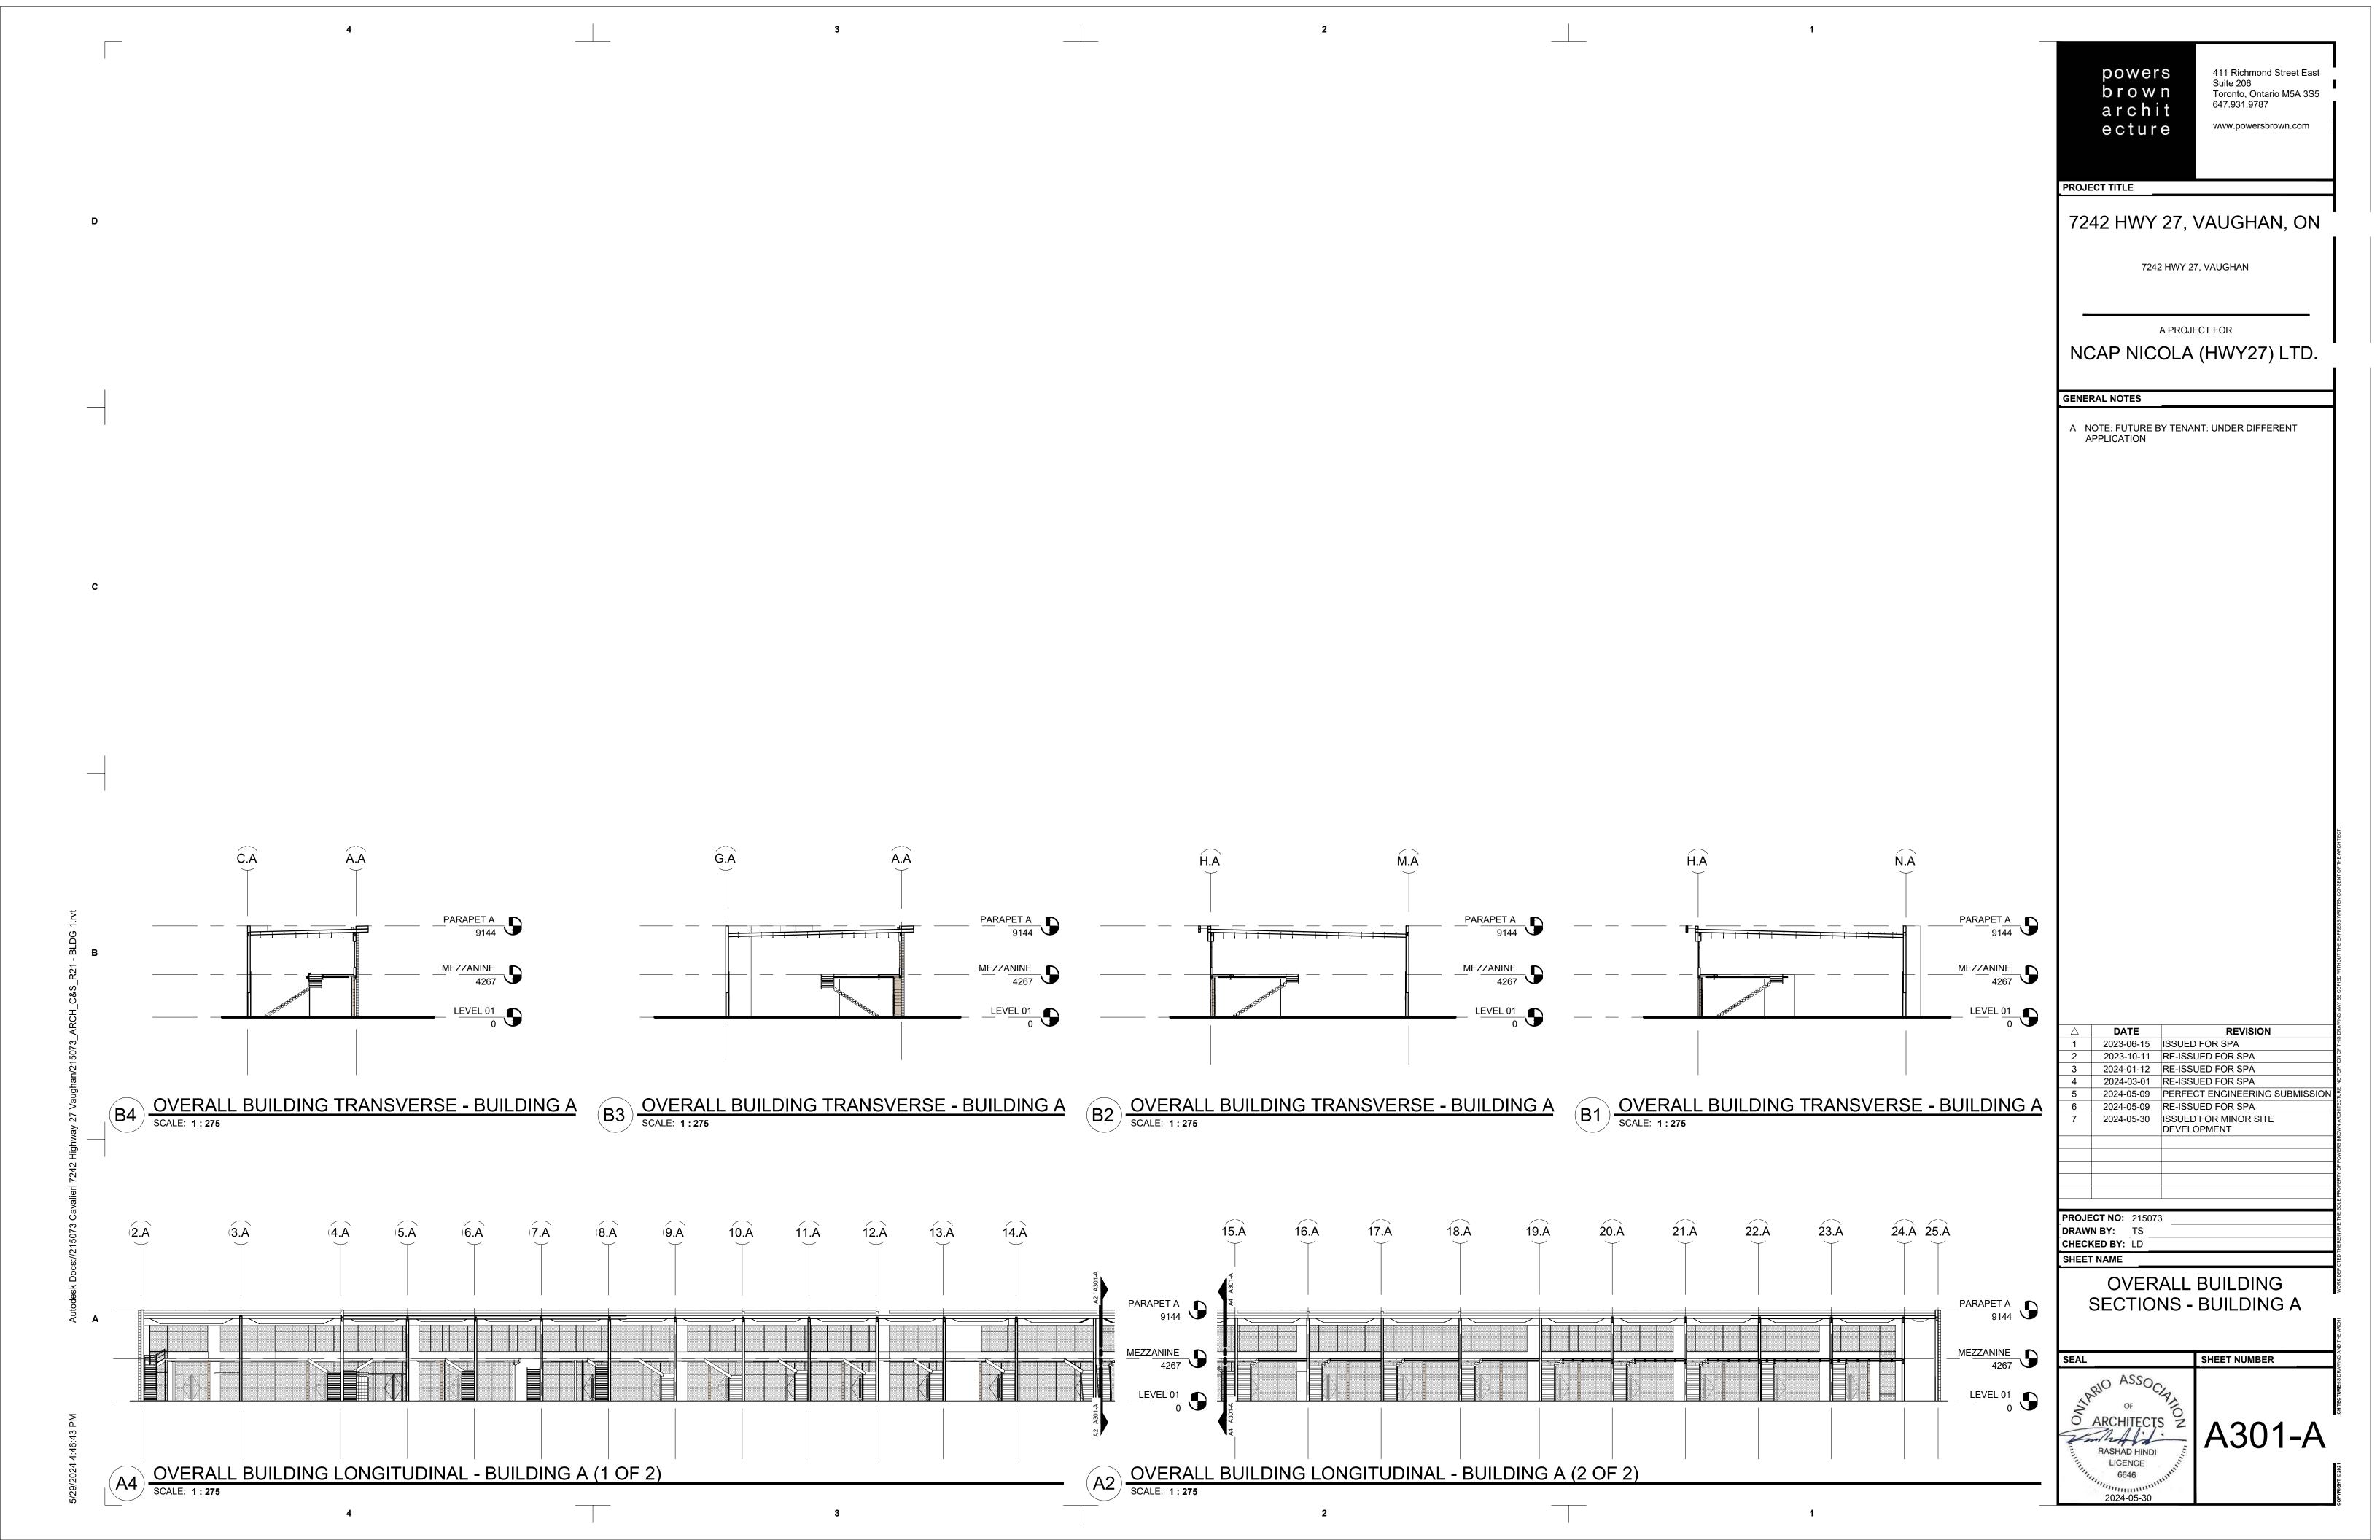

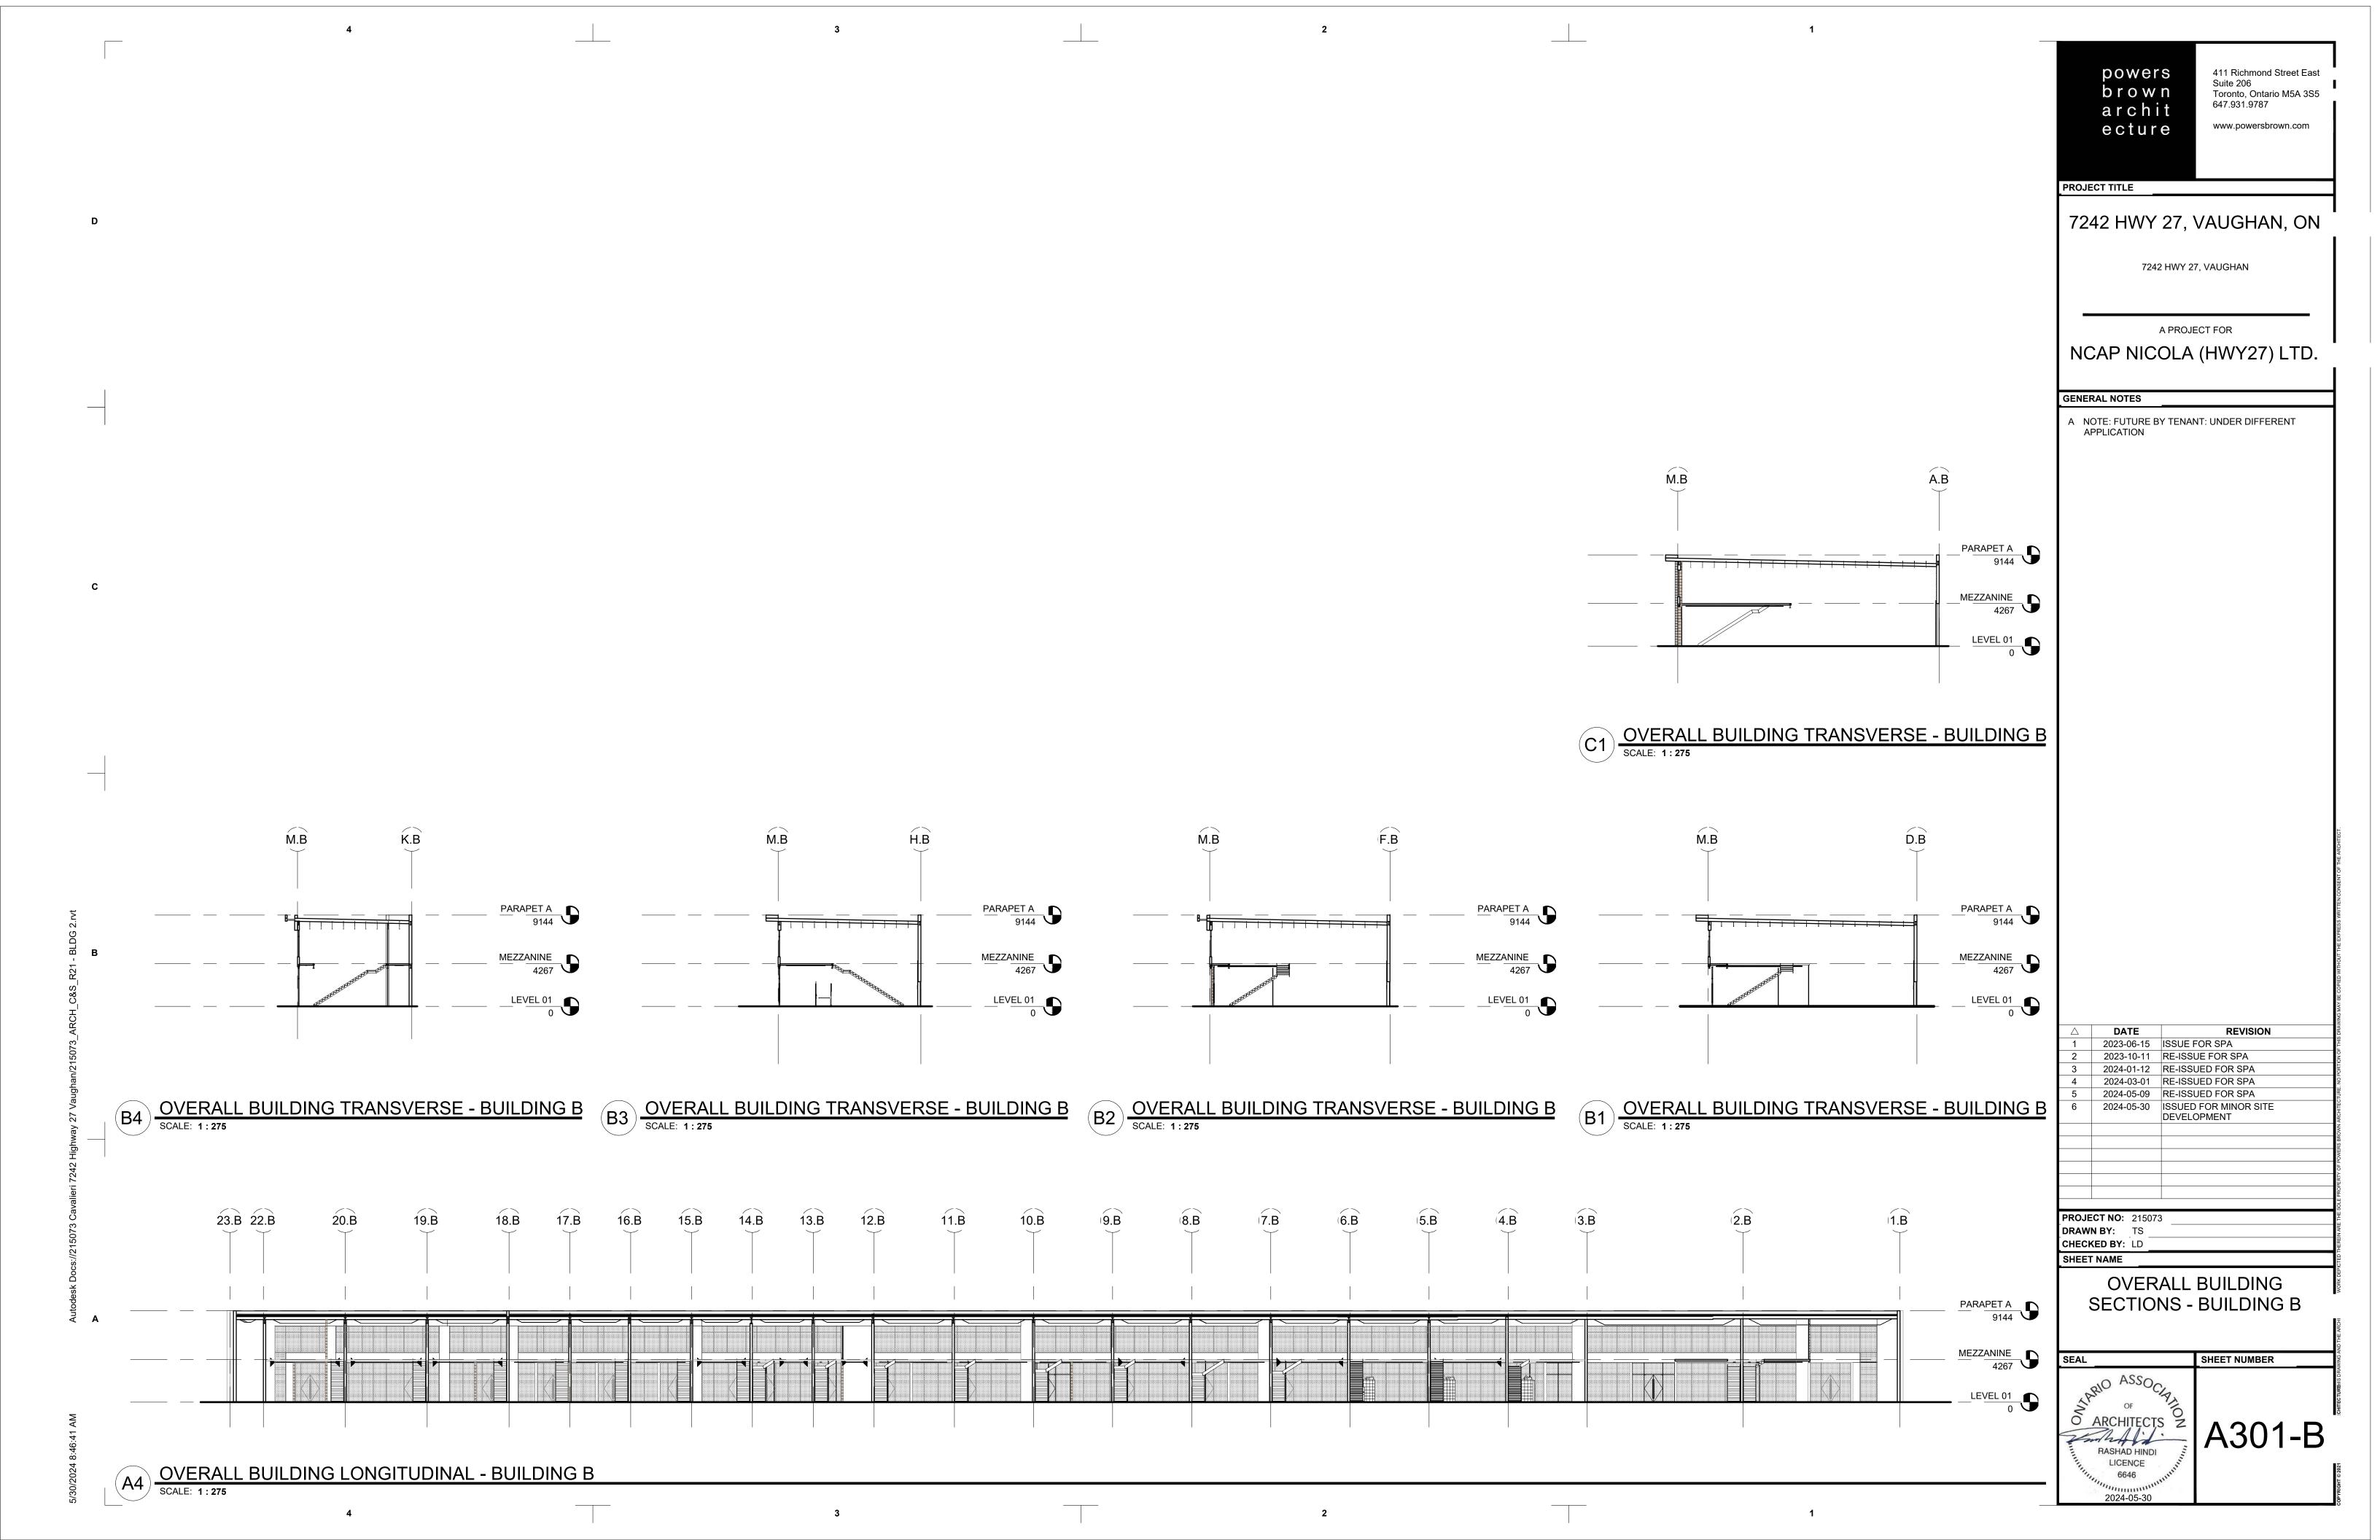

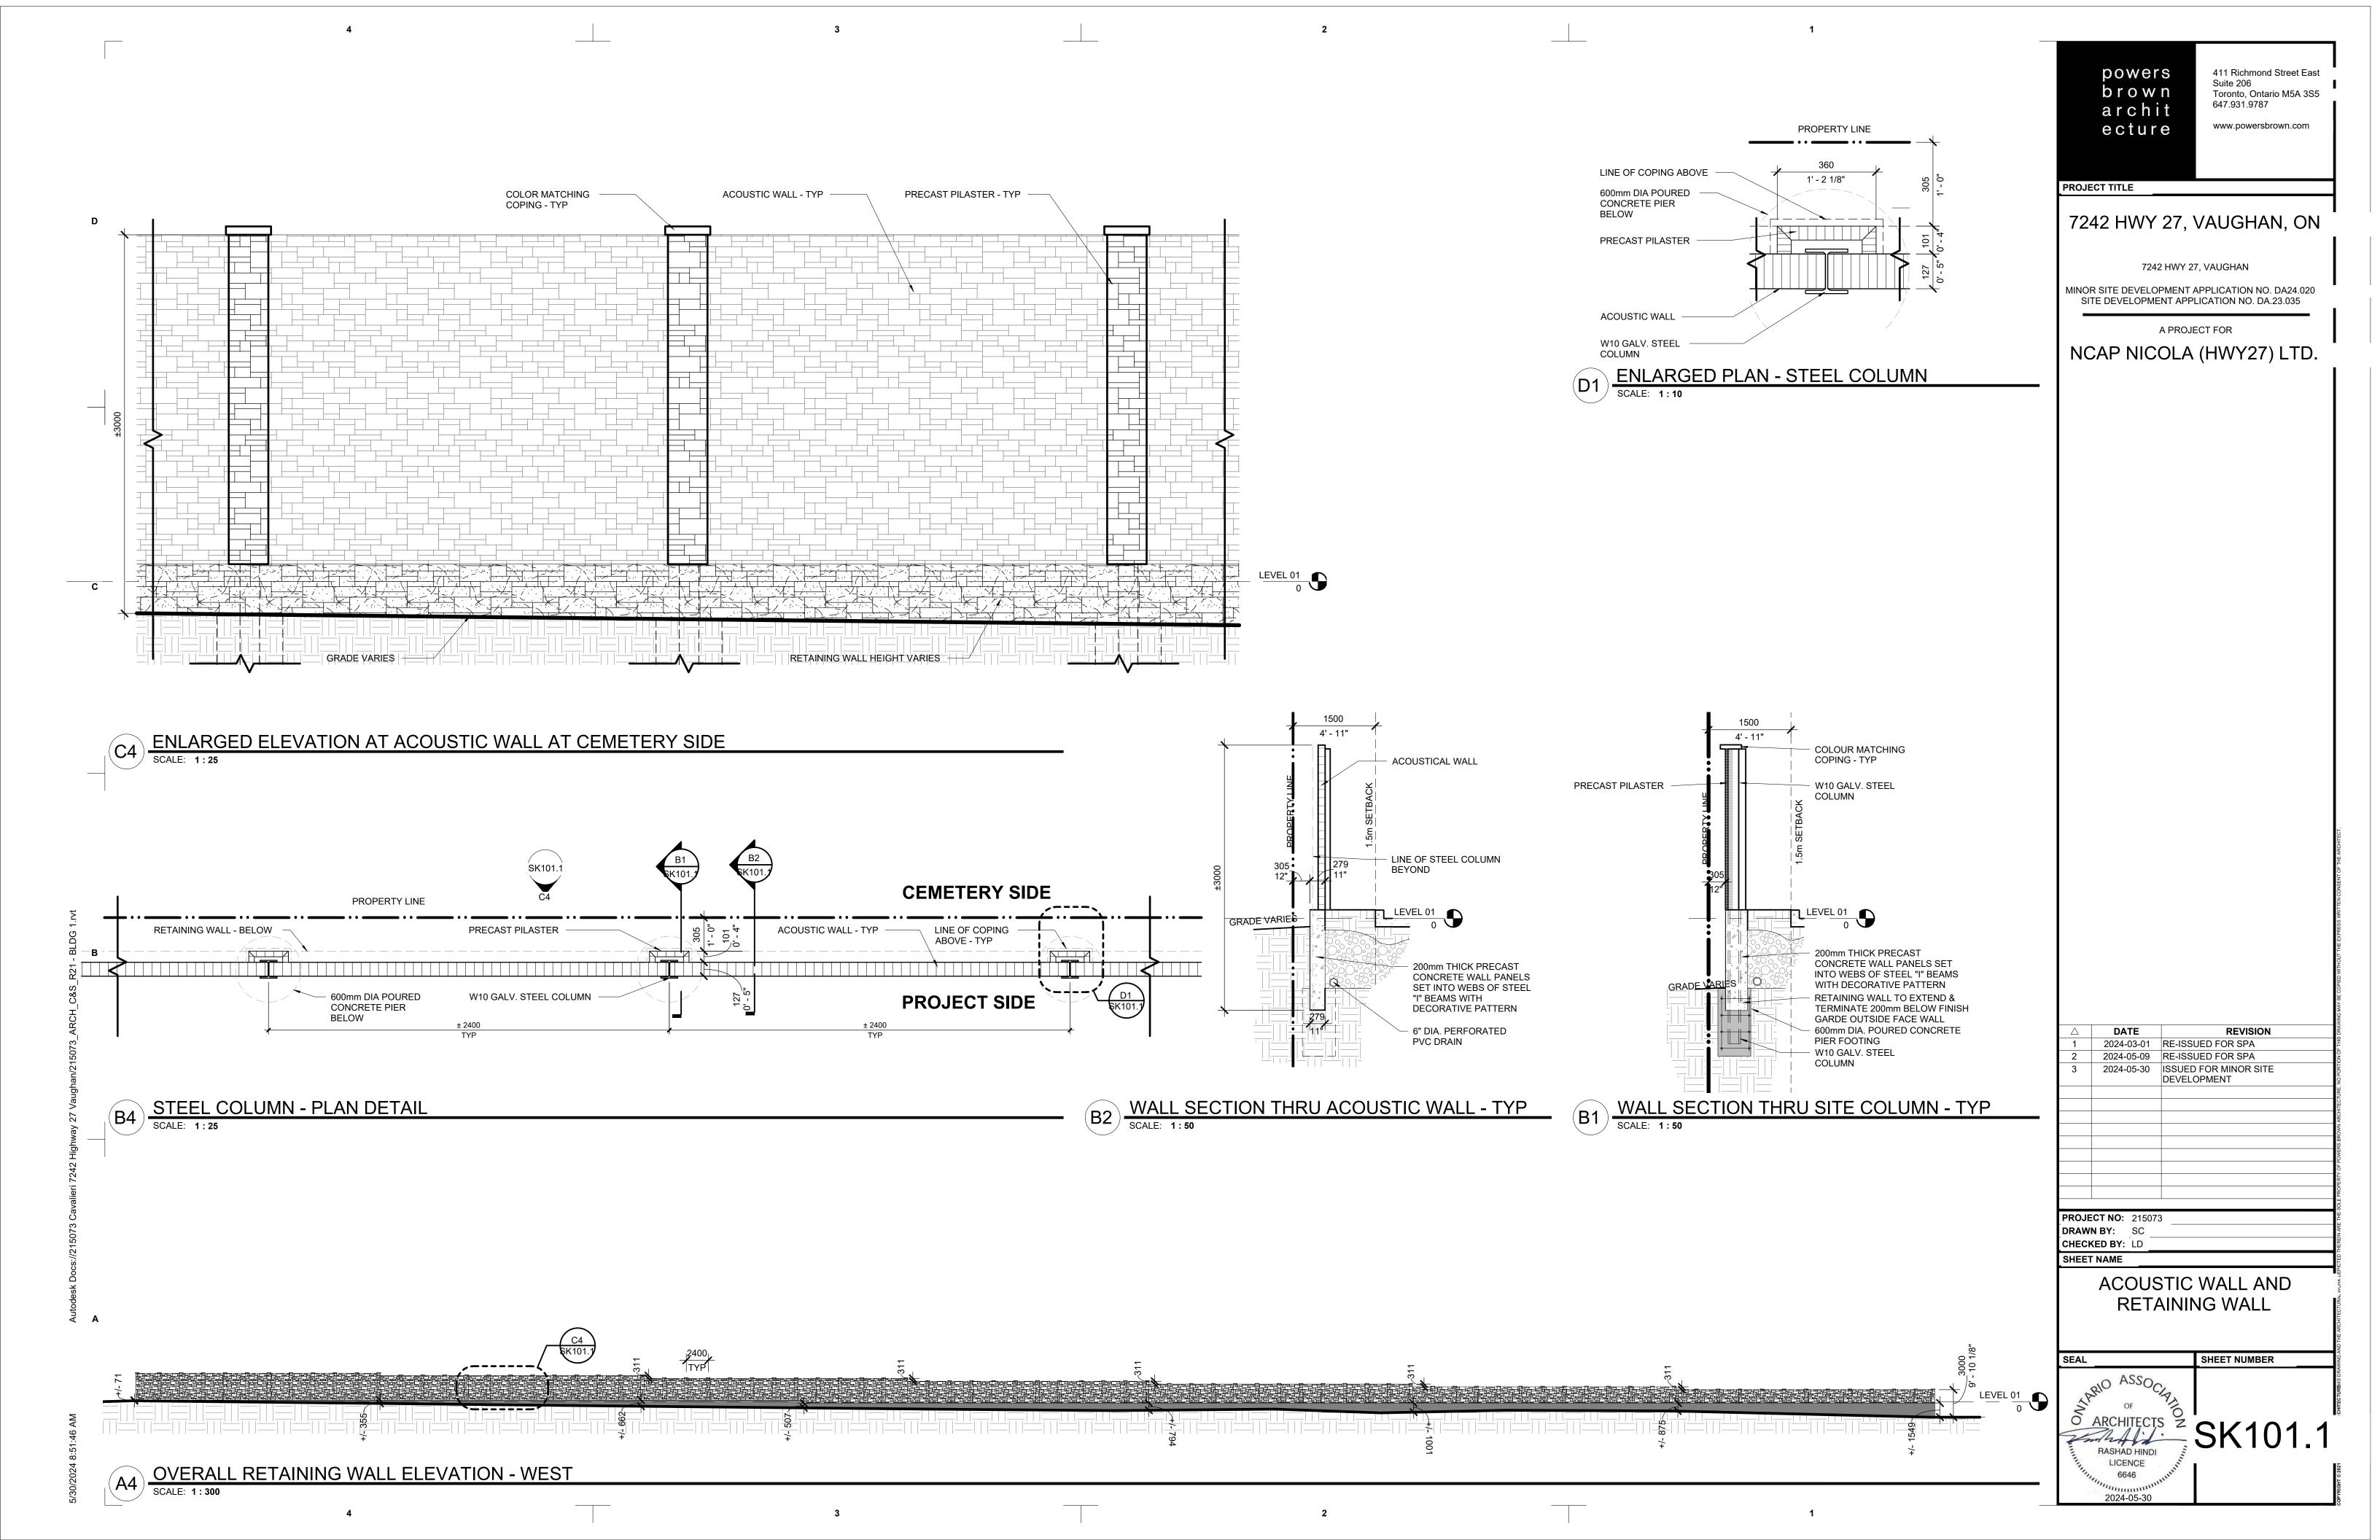

SCHEDULE B: COMMENTS FROM AGENCIES, BUILDING STANDARDS & DEVELOPMENT PLANNING

Department / Agency *Comments Received	Conditions Required		Nature of Comments
Building Standards (Zoning) *See Schedule B	Yes □	No ⊠	General Comments
Development Planning	Yes ⊠	No □	Recommend Approval w/Conditions

External Agencies *Comments Received	•		Nature of Comments *See Schedule B for full comments
Alectra	Yes □	No ⊠	General Comments
Region of York	Yes □	No ⊠	General Comments
TRCA	Yes □	No ⊠	General Comments



Date: July 22nd 2024

Attention: Christine Vigneault

RE:

File No.: A111-24

Related Files:

Applicant Weston Consulting

Location 7242 Hwy 27



COMMENTS:

	We have reviewed the proposed Variance Application and have no comments or objections to its approval.
X	We have reviewed the proposed Variance Application and have no objections to its approval, subject to the following comments (attached below).
	We have reviewed the proposed Variance Application and have the following concerns (attached below).

Alectra Utilities (formerly PowerStream) has received and reviewed the proposed Variance Application. This review, however, does not imply any approval of the project or plan.

All proposed billboards, signs, and other structures associated with the project or plan must maintain minimum clearances to the existing overhead or underground electrical distribution system as specified by the applicable standards, codes and acts referenced.

In the event that construction commences, and the clearance between any component of the work/structure and the adjacent existing overhead and underground electrical distribution system violates the Occupational Health and Safety Act, the customer will be responsible for 100% of the costs associated with Alectra making the work area safe. All construction work will be required to stop until the safe limits of approach can be established.

In the event construction is completed, and the clearance between the constructed structure and the adjacent existing overhead and underground electrical distribution system violates the any of applicable standards, acts or codes referenced, the customer will be responsible for 100% of Alectra's cost for any relocation work.

References:

- Ontario Electrical Safety Code, latest edition (Clearance of Conductors from Buildings)
- Ontario Health and Safety Act, latest edition (Construction Protection)
- Ontario Building Code, latest edition (Clearance to Buildings)
- PowerStream (Construction Standard 03-1, 03-4), attached
- Canadian Standards Association, latest edition (Basic Clearances)

If more information is required, please contact either of the following:

Mr. Stephen Cranley, C.E.T

Supervisor, Distribution Design, ICI & Layouts (North)

Phone: 1-877-963-6900 ext. 31297

E-mail: stephen.cranley@alectrautilities.com

Mitchell Penner

Supervisor, Distribution Design-Subdivisions

Phone: 416-302-6215

Email: Mitchell.Penner@alectrautilities.com



Power Stream 1

Construction Standard

03-1

	SYSTEM VOLTAGE				
LOCATION OF WIRES, CABLES OR CONDUCTORS	SPAN GUYS AND COMMUNICATIONS WIRES		4.16/2.4kV TO 27.6/16kV (SEE NOTE 1)	44kV	
	MINIMUM	VERTICAL CLEA	ARANCES (SEE	NOTE 2)	
OVER OR ALONGSIDE ROADS, DRIVEWAYS OR LANDS ACCESSIBLE TO <u>VEHICLES</u>	442cm	442cm	480cm	520cm	
OVER GROUND ACCESSIBLE TO PEDESTRIANS AND BICYCLES ONLY	250cm	310cm	340cm	370cm	
ABOVE TOP OF RAIL AT RAILWAY CROSSINGS	730cm	730cm	760cm	810cm	



MINIMUM ATTACHMENT HEIGHT = MAXIMUM SAG

- + MINIMUM VERTICAL CLEARANCE (FROM ABOVE TABLE)
 ± GRADE DIFFERENCE

- + 0.3m (VEHICLE OR RAILWAY LOCATION) + SNOW DEPTH (PEDESTRIAN LOCATION, SEE NOTE 3)

NOTES:

- THE MULTIGROUNDED SYSTEM NEUTRAL HAS THE SAME CLEARANCE AS THE 600V SYSTEM.
- 2. THE VERTICAL CLEARANCES IN THE ABOVE TABLE ARE UNDER $\underline{\text{MAXIMUM SAG}}$ CONDITIONS.
- 3. REFER TO CSA STANDARD C22.3 No.1, ANNEX D FOR LOCAL SNOW DEPTH
- 4. ALL CLEARANCES ARE IN ACCORDANCE TO CSA STANDARD C22.3.

<u>\G</u>	340cm	11'-4"			
	310cm	10'-4"			
VALUES.	250cm	8'-4"			
VALUES.					
REFERENCES					
SAGS AND	FNSIONS 1	SECTION 02			

METRIC

810cm

760cm 730cm

520cm 480cm

442cm 370cm

CONVERSION TABLE

IMPERIAL (APPROX)

27'-0" 25'-4"

24'-4" 17'-4"

15'-5" 12'-4"

MINIMUM VERTICAL CLEARANCES OF WIRES, CABLES AND CONDUCTORS ABOVE GROUND OR RAILS

ORIGINAL ISSUE DATE: 2010-DEC-24 REVISION NO: R1 REVISION DATE: 2012-JAN-09

Certificate of Approval This construction Standard meets the safety requirements of Section 4 of Regulation 22/04	
Joe Crozier, P.Eng. 2012-JAN-09 Name Date	
P Fng. Annroyal By-	Ine Crozier



Construction Standard

03 - 4





VOLTAGE	MINIMUM HORIZONTAL CLEARNACE UNDER MAXIMUM SWING CONDITIONS DIMENSION "X" (SEE NOTES 1, 3 & 4)	MINIMUM VERTICAL CLEARANCE UNDER MAXIMUM DESIGN SAG CONDITIONS DIMENSION "Y" (SEE NOTES 1, 2, 4 & 5)
0-600V AND NEUTRAL	100cm	250cm
4.16/2.4 TO 44kV	300cm	480cm

NOTES

- UNDER NO CIRCUMSTANCES SHALL A CONDUCTOR BE PERMITTED TO PENETRATE THE ENVELOPE SHOWN BY THE DOTTED LINE.
- 2. THE VERTICAL CLEARANCES ARE UNDER CONDITIONS OF MAXIMUM DESIGN SAG.
- THE HORIZONTAL CLEARANCES ARE UNDER CONDITIONS OF MAXIMUM SWING. WHERE THE CONDUCTOR SWING IS NOT KNOWN A HORIZONTAL CLEARANCE OF 480CM SHALL BE USED.
- 4. BUILDINGS THAT EXCEED 3 STOREYS OR 15M IN HEIGHT, THE MINIMUM HORIZONTAL CLEARANCE OF THE SECONDARY CONDUCTORS SHOULD BE INCREASED TO 300cm WHERE IT IS NECESSARY TO ALLOW FOR THE RAISING OF LADDERS BY LOCAL FIRE DEPARTMENTS.
- IN SITUATIONS SUCH AS MULTI-LEVEL GARAGES, WHERE ROOFS ARE NORMALLY USED BY PERSONS AND VEHICLES, THE VERTICAL CLEARANCES OF POWERSTREAM STANDARD 03-1 SHALL APPLY.
- 6. DISTRIBUTION LINES CONSTRUCTED NEAR BUILDINGS SHALL BE BUILT TO AVOID OVERHANG WHEREVER POSSIBLE. WHERE LINES MUST BE CONSTRUCTED OVER OR ADJACENT TO BUILDINGS THE APPLICABLE HORIZONTAL AND VERTICAL CLEARANCES SHALL BE AT CONDITIONS OF MAXIMUM CONDUCTOR SWING AND MAXIMUM SAG. THE ABOVE CLEARANCES ARE DESIGNED TO PREVENT PERSONS ON OR IN BUILDINGS AS WELL AS EXTERNAL MACHINERY USED IN CONJUCTION WITH A BUILDING TO COME IN CONTACT WITH CONDUCTORS. EFFORTS SHOULD BE MADE TO INCREASE THESE CLEARANCES WHERE POSSIBLE.
- 7. ALL CLEARANCES ARE IN ACCORDANCE TO CSA C22.3 NO.1-06 (TABLE-9).

CONVERSION TABLE		
IMPERIAL		
(APPROX)		
16'-0"		
10'-0"		
8'-4"		
3'-4"		

MINIMUM VERTICAL & HORIZONTAL CLEARANCES OF CONDUCTORS FROM BUILDINGS OR OTHER PERMANENT STRUCTURES (CONDUCTORS NOT ATTACHED TO BUILDINGS)

ORIGINAL ISSUE DATE: 2010—MAY—05 REVISION NO: REVISION DATE:
PEgystem Planning and Standards/Standard Design/PowerStream Standards/working (abbr/Scellan 3/3-4/c/wg d3-4 Ro May 5, 2010, dwg, %/3/2010 8/2/202 AM, Adobe POF



To: Committee of Adjustment

From: Bernd Paessler, Building Standards Department

Date: August 6, 2024

Applicant: Weston Consulting

Location: 7242 Hwy 27

CONC 8 Part of Lot 2

File No.(s): A111/24

Zoning Classification:

The subject lands are zoned EM1(H) Prestige Employment Zone and subject to the provisions of Exception 14.1162 under Zoning By-law 001-2021, as amended.

#	Zoning By-law 001-2021	Variance requested
1	The minimum setback of any building or structure to an Open Space Zone shall be 11.0m.	To permit a minimum setback of 0.30 metres from the OS lands to the retaining wall.
	Exception 14.1162	
2	A retaining wall shall be setback an equal distance to the height of the highest portion of the retaining wall. The minimum setback is 1.60m.	To permit a retaining wall with a maximum height of 1.6m to be setback a minimum of 0.30 metres from the rear lot
	Section 4.13	line.

Staff Comments:

Stop Work Order(s) and Order(s) to Comply:

There are no outstanding Orders on file

Building Permit(s) Issued:

A Building Permit has not been issued. The Ontario Building Code requires a building permit for structures that exceed $10 \mathrm{m}^2$

Other Comments:

General Comments		
1	The applicant shall be advised that additional variances may be required upon review of detailed drawing for building permit/site plan approval.	
2	This review is strictly for the retaining wall.	

Conditions of Approval:

If the committee finds merit in the application, the following conditions of approval are recommended.

^{*} Comments are based on the review of documentation supplied with this application.





To: Christine Vigneault, Committee of Adjustment Secretary Treasurer

From: Nancy Tuckett, Director of Development Planning

Date: August 13, 2024

Name of Owner: Michael Lazier - NCAP Nicola (Hwy 27) Ltd.

Location: 7242 Highway 27

File No.(s): A111/24

Proposed Variance(s) (By-law 001-2021):

1. To permit a minimum setback of **0.30 m** from the OS lands to the retaining wall.

2. To permit a retaining wall with a maximum height of **1.60 m** to be setback a minimum of **0.30 m** from the rear lot line.

By-Law Requirement(s) (By-law 001-2021):

- 1. The minimum setback of any building or structure to an Open Space Zone shall be **11.0 m**.
- 2. A retaining wall shall be set back an equal distance to the height of the highest portion of the retaining wall. The minimum setback is **1.60 m**.

Official Plan:

Vaughan Official Plan 2010 ('VOP 2010'): "Prestige Employment" by Schedule 13 – Land Use and subject to Site-Specific Policy 13.3.

Comments:

Application History

In 2023, the Owners submitted a Site Development Application (DA.23.035) to permit the proposed development which contemplates two (2) 1-storey multi-unit industrial buildings. The industrial buildings will have a combined gross floor area ('GFA') of 7,661.71 m², a total floor space index ("FSI") of 0.46, with 43 industrial units and 120 surface parking spaces along the perimeter of the Subject Lands. Vehicular access is proposed via three (3) access points on a realigned Toronto RV Road. The re-alignment of Toronto RV Road consolidates the lands held by the Owner, which are currently bisected by the road. The consolidated lot provides additional developable area. Prior to the Site Plan Application, Official Plan Amendment (OP.17.016) and Zoning By-law Amendment (Z.17.046) applications were submitted in 2017 and approved by Council on December 12, 2023, and By-laws 213-2023 and 214-2023 were enacted to adopt the amendment to the Vaughan Official Plan (VOP) 2010 and pass an amendment to Zoning By-law 001-2021 respectively.

In order to facilitate the development proposed in Site Development Application File DA.23.035, relief from Zoning By-law 001-2021 was sought via Minor Variance Application File A111/24. This Minor Variance Application (A207/23) was submitted to permit the construction of a retaining wall on the subject lands.

<u>Analysis</u>

The Owner is requesting relief to permit the construction of a retaining wall along the entirety of the western lot line and a portion of the south lot line of the Subject Lands, with the above-noted variances.

The Development Planning Department has no objection to the proposed variances to permit a proposed retaining wall for the proposed development that has a maximum height of 1.60 m (excluding the proposed acoustic panels and guardrails), while maintaining a setback of 0.30 m from the abutting Open Space Zone (Variances 1 & 2). The retaining wall is proposed as an "L-shape" as both segments are connected at the southwestern corner of the Subject Lands. The wall would have an exposed face height up to 1.60m at its highest portions (1.549 m along the western property line and 1.583

memorandum



along the southern property line) due to the property's varying topography. The retaining wall along the western property line is proposed to have acoustic paneling on top. The retaining wall along the south lot line is proposed to have a guardrail on top. The 0.30 m minimum setback for the proposed retaining wall is measured along the entirety of the proposed retaining wall at both the western and southern property lines and provides sufficient space for safe access and maintenance if required. The Urban Design Department and Development Engineering Department have also reviewed the proposal and have no concerns with the retaining wall. As such, the retaining wall is not anticipated to have any adverse impacts to the neighbouring property and land use is desirable for the appropriate development of the land.

In support of the application, the Owner has submitted an Arborist Report & Tree Protection and Removal Plan prepared by P & A Urban Forestry Consulting Ltd., dated November 30, 2021, and updated on October 13, 2023. The report inventoried a total of four (4) trees, two (2) of which are proposed to be removed and two (2) to be preserved through construction. A total of two (2) replacement trees are proposed. Urban Design staff have reviewed the report and concur with its recommendations.

Accordingly, the Development Planning Department can support the requested variance and is of the opinion that the proposal is minor in nature, maintains the general intent and purpose of the Official Plan and Zoning By-law, and is desirable for the appropriate development of the land.

Recommendation:

The Development Planning Department recommends approval of the application with the following condition of approval:

Condition of Approval:

If the Committee finds merit in the application, the following condition of approval is recommended:

1. That all comments on Site Development Application File DA.23.035 be addressed to the satisfaction of the Development Planning Department.

Comments Prepared by:

Nicholas Del Prete, Planner David Harding, Senior Planner

Lenore Providence

Subject: FW: [External] RE: A111/24 (160 Polo Crescent) - REQUEST FOR COMMENTS, CITY OF

VAUGHAN

From: Cameron McDonald < Cameron. McDonald@trca.ca>

Sent: Friday, July 19, 2024 3:56 PM

To: Committee of Adjustment < CofA@vaughan.ca>

Subject: [External] RE: A111/24 (160 Polo Crescent) - REQUEST FOR COMMENTS, CITY OF VAUGHAN

CAUTION! This is an external email. Verify the sender's email address and carefully examine any links or attachments before clicking. If you believe this may be a phishing email, please use the Phish Alert Button.

Good afternoon,

Based on a review of our screening mapping, I can confirm that the subject property is not located within TRCA's Regulated Area. As such, any site alteration or development on the property would not require a permit from TRCA.

Based on the above, we have no comments/requirements.

Regards,

Cameron McDonald

Planner I

Development Planning and Permits | Development and Engineering Services

T: (437) 880-1925

E: cameron.mcdonald@trca.ca

A: 101 Exchange Avenue, Vaughan, ON, L4K 5R6 | trca.ca



From: Development Services
To: Christine Vigneault
Cc: Committee of Adjustment

Subject: [External] RE: A111/24 (7242 Hwy 27) - REQUEST FOR COMMENTS, CITY OF VAUGHAN

Date: Monday, July 29, 2024 5:48:47 PM

Attachments: image001.pnq

image003.png

CAUTION! This is an external email. Verify the sender's email address and carefully examine any links or attachments before clicking. If you believe this may be a phishing email, please use the Phish Alert Button.

Hi Christine,

The Regional Municipality of York has completed its review of the minor variance application – A111/24 (7242 Highway 27) and has no comment.

Please note Regional comments will continue to be provided through the related Site Plan (SP.23.V.0146).

Please provide us with a digital copy of the notice of decision for our records.

Many thanks,

Our working hours may be different. Please do not feel obligated to reply outside of your scheduled working hours. Let's work together to help foster healthy work-life boundaries.

Niranjan Rajevan, M.PI. | Associate Planner, Development Planning | Economic and Development Services Branch | Corporate Services Department

The Regional Municipality of York | 17250 Yonge Street | Newmarket, ON L3Y 6Z1 1-877-464-9675 ext. 71521 | niranjan.rajevan@york.ca | www.york.ca

Our Values: Integrity, Commitment, Accountability, Respect, Excellence



SCHEDULE C: PUBLIC & APPLICANT CORRESPONDENCE					
Correspondence Type	Name	Address	Date Received (mm/dd/yyyy)	Summary	
Applicant			07/30/2024	Application Cover Letter	



City of Vaughan
Development Planning Department
2141 Major Mackenzie Drive
Vaughan, Ontario L6A 1T1

July 29, 2024 File 7494-1

Attn: Christine Vigneault - Manager Development Services & Secretary Treasurer

Nicholas Del Prete - Planner, Development Planning

Re: Minor Variance Application – Addendum Letter

7242 Highway 27, Vaughan

Related Files: DA.24.020, DA.23.035

Weston Consulting is the planning consultant for NCAP NICOLA (HWY 27) LTD., the registered owner of the lands municipally known as 7242 Highway 27 in the City of Vaughan (herein referred to as the 'Subject Lands'). This planning rationale addendum letter has been prepared to support the minor variance application, which seeks zoning reliefs for the permitted retaining wall setbacks from the lot lines to the south, north and west of the subject lands.

Minor Variance Application Context and Addendum Rationale

A Minor Variance application was submitted to the Committee of Adjustment on June 21, 2024, requesting a zoning relief to permit a retaining wall with a maximum height of 1.6 metres to be setback a minimum of 0.30 metres from the lot lines. Through the Minor Site Development (DA.24.020) application review process and discussions with City staff on July 26, 2024, a second minor variance pertaining to the minimum setback requirement for any building or structure to an Open Space Zone has been confirmed. As a result, this addendum letter has been prepared in support of the requested variances.

As described in the original application and cover letter, the Subject Lands had undergone a number of planning applications and approvals. On December 12, 2023, the Official Plan (OP.17.016) and Zoning By-law Amendment (Z.17046) applications were approved by the City Council with the site-specific provisions and the Holding Symbol. The proposed retaining wall and its 0.305 m setback (305 mm) to the adjacent property were identified and illustrated on associated drawings/plans at the time of the application review and approval process.

As mentioned previously, the Subject Lands has also undergone a Minor Site Development application (DA.24.020), which is intended to facilitate the construction of a retaining and acoustic wall on the west boundary and a retaining wall on the south boundary of the Subject Lands prior to the construction of the proposed industrial buildings and realignment of Toronto RV Road. The proposed retaining and acoustic wall on the west boundary of the Subject Lands is intended to facilitate the Noise Attenuation requirements recommended by the Noise Study and set out in the letter of understanding between Catholic Cemeteries and Funeral Services and NCAP NICOLA (HWY 27) LTD., dated November 3, 2023. The retaining walls on the south and west property boundaries are required to facilitate the site grading of the portion of the Subject Lands where the retaining wall is proposed to be constructed.



Proposed Minor Variances:

In order to facilitate the development proposed through the Site Development Application (DA.23.035) and Minor Site Plan (DA.24.020), relief from the City of Vaughan Comprehensive Zoning By-law 01-2021 for the proposed retaining wall is required. The table below identifies the requested variance:

#	Zoning By-law 01-2021	Variance Requested
1.	Section 4.13 Permitted Encroachments into Required Yards. (Table 4-1): • Retaining Wall - Shall be setback an equal distance to the height of the highest portion of the retaining wall	To permit a retaining wall with a maximum height of 1.6 metres at its highest portion to be setback a minimum of 0.3 metres from a lot line.
2.	Site Exception 14.1162 The minimum setback of any building or structure to an Open Space Zone shall be 11.0m.	To permit a minimum setback of 0.30 metres from the OS lands to the retaining wall.

Minor Variance Rationale:

Section 45(1) of the Planning Act authorizes the Committee of Adjustment to grant minor variances from the regulations of the zoning by-law, provided that an application satisfies the "four tests": that the variances requested maintain the general intent of the Official Plan and Zoning By-law, that the requested variances are minor in nature and desirable for the appropriate development or use of the lands.

Are the general intent and purpose of the Official Plan and the Zoning By-law maintained?

The proposed development has undergone approvals for the Official Plan and Zoning By-law Amendments, as well as development approvals through the recently approved Minor DA for the proposed industrial development. The proposed retaining wall has been identified to address engineering matters such as the site grading and drainage of the proposed development. As such, it is our opinion that the requested variance maintains the intent of the City's Official Plan and Comprehensive Zoning By-law.

Is the variance minor in nature?

The City's Comprehensive Zoning By-law allows a retaining wall to be on a lot line if the height is less than 1 metre. As shown on the enclosed Architectural Drawing Set (Sheet Number SK101.1), the height of the retaining wall is less than 1 metres throughout the west and south elevation, except for a small portion to the southwest corner, where it is 1.54 metres at the highest portion. It is noted that the retaining wall is not proposed on the lot line, but it maintains a setback of 0.3 metres throughout the lot line. Therefore, the retaining wall height increase at the small corner segment is minor as it exceeds the 1 metre height limit by only 0.54 metres.

Is the variance desirable for the property?

As previously noted, the retaining wall is required to address the proposed development's site grading and drainage matters. In addition, the retaining wall along the western property line also provides a base for the acoustic walls, which is recommended to mitigate noise associated with the proposed development to the adjacent cemetery. Therefore, the proposed variance is desirable for the functionality of the proposed development and enhancement of employment lands within the City of Vaughan.



Resubmission Materials

In support of the Minor Variance Application and per the comments issued by Zoning Staff on July 18, 2024, the following materials are enclosed:

- 0. Cover Letter Addendum, prepared by Weston Consulting.
- 1. Updated Minor Variance Site Plan Sketch, prepared by Weston Consulting.
- 2. Letter of Understanding, dated November 3, 2023.

Conclusion

Based on the information provided in this addendum letter, the enclosed revised drawing, and our analysis, it is our opinion that the proposed variances have planning merit as they satisfy the four tests for a minor variance approval under Section 45 (1) of the Planning Act and represent good planning. As such, it is our opinion that this application and the requested variance are desirable and appropriate for the subject property and should be considered for approval by the Committee of Adjustment.

We trust that the above is in order and constitutes a complete application for a Minor Variance application. We request that staff review the enclosed materials as soon as possible, as we understand that our application has been tentatively scheduled for the Committee of Adjustment Hearing on August 22, 2024, at 6:00 pm.

Please do not hesitate to contact the undersigned at extension 330 or Kaveh Wahdat at extension 328 should there be any questions regarding this submission.

Yours truly,

Weston Consulting

Per:

Raj Lamichhane, BARCH, MPL, MCIP, RPP

Senior Planner

cc. Client

Sandra K. Patano, Weston Consulting
Casandra Krysko, Senior Planner, City of Vaughan
Sarah Scauzillo, Building Standards Department, City of Vaughan
Rex Bondad, Development Engineering, City of Vaughan

SCHEDULE D: BACKGROUND

None