

**CULTURAL HERITAGE DISTRICT
IMPACT ASSESSMENT
and
Heritage Conservation District
Conformity Report**

**8010 Kipling Avenue
Vaughan (Woodbridge), Ontario,
Canada**

7 September 2018

prepared by



architecture + planning + urban design
+
heritage conservation
+
real estate development

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8010 Kipling Avenue

Woodbridge Heritage District

Vaughan, Ontario, Canada

CULTURAL HERITAGE IMPACT ASSESSMENT

and

CULTURAL HERITAGE DISTRICT CONFORMITY REPORT

28 August 2018

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- 5- 1860 Tremaine Map, excerpt showing approximate property location
- 6- 1880 Illustrated Atlas Map of Vaughan, excerpt showing location of 1810 Kipling Avenue
- 7- Aerial Photograph of Vicinity of subject property
- 8- Vaughan Official Plan map
- 9- Heritage Conservation District Map, Woodbridge
- 10- Site Plan of planned redevelopment of subject property
- 11- Preliminary elevation drawings of planned redevelopment of subject property
- 12- Cultural Heritage Summary Evaluation, 8010 Kipling Avenue
- 13- Curriculum Vitae, Mark Hall, OAA, MRAIC, FAIA, RPP, CAHP

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1.0 INTRODUCTION TO THE PROPERTY

This Cultural Heritage Impact Assessment (CHIA) follows City of Vaughan Guidelines for Cultural Heritage Impact Assessments, updated February 2016 (Appendix 1).

8010 Kipling Avenue is in the City of Vaughan, north of Woodbridge Avenue and William Street in the district known as Woodbridge. The property is a trapezoidal [nearly rectangular] parcel approximately 73.5m deep by 25.0m wide fronting on Kipling Avenue.

The property presently holds three structures:

(a) 1 ½ storey aluminum clad older residential building with pitched roof at the eastern end of the property, and with an enclosed front porch at the east side of the building plus a one storey addition on the west side. The building fronts onto Kipling Avenue along with:

(b) a small aluminum shed at north edge of the lot,

(c) concrete block and adjacent aluminum shed at west end (rear) of the property.

Western boundary of the property is adjacent to Canadian Pacific Rail property.

North of the property is a six-storey apartment building at 8026-8032 Kipling Avenue.

South of the property is an existing brick clad residential structure at 8006 Kipling Avenue.

The property is situated within the Woodbridge Heritage Conservation District, which is within the City of Vaughn, Ontario. This area contains many heritage buildings, and structures of similar scale which support the heritage district, combined with recently redeveloped parcels. 8010 Kipling Avenue is not a Designated Heritage Property, but is designated within the Vaughan Heritage Inventory under Part V of the Ontario Heritage Act.

The owner of the property, working with KFA, Architects, retained MW HALL CORPORATION, Heritage Conservation Consultants to prepare this Cultural Heritage Impact Assessment (CHIA) of the property and review of the planned redevelopment.

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The subject property is owned by:

First Avenue
5461 Highway 7, Suite 200
Woodbridge, Ontario L4L 0B2

Contact information is as follows:

Mr. Jack Morelli
Tel: (905) 856-3031
Email: jmorelli@firstavenue.ca

2.1 History of the property and evolution to date

The property was purchased by the present owner for purposes of redevelopment. Application is in the process of being made to City of Vaughan to redevelop the property.

2.2 Context and setting of the subject property

The Woodbridge Heritage Conservation District Study and Plan [reference a)] notes that there are seven identified 'character areas' with the Woodbridge Heritage Conservation District. At this portion of Kipling Avenue, the north portion of the Heritage Conservation District, architectural character of the district is a mixture of older, low scaled buildings and newer, larger scaled infill buildings with a sidewalk along Kipling Avenue with few trees and some grassed areas between the sidewalk and street. 8010 Kipling Avenue is on the west side of the Kipling Avenue North character area but is, itself, not a heritage property. It is a relatively deep lot and presently has the 1 ½ storey residential building fronting on Kipling Avenue with a driveway on its south side providing access to existing the commercial structures at the rear of the lot. To the north of the property is a six-storey residential condominium building. To the south of the property is a single-family brick residence which is presently being restored and expanded.

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2.3 Architectural evaluation of the subject property

The building at the front (east) of 8010 Kipling Avenue is a relatively modest house with an enclosed front porch, 12:12 pitched roof, small rear addition, with aluminum cladding which has been applied over the original exterior walls. Shape of the building and existing windows visible on the side walls indicate that the building is early 20th century/late 19th century. Structures at the rear of the property are likely mid- 20th century commercial/industrial buildings.

2.4 Planned redevelopment for the subject land and potential impacts on identified heritage resources

The 2010 Official Plan [reference e] for this property calls for it to be 'Low Rise Residential, Mixed Use'.

Planned redevelopment of the property is to remove existing buildings on the property and to construct 45 new rental apartment units with a single level of underground parking. The planned building will visually bridge the scale between an existing single-family residence on the south side of the property and the multi-unit five-storey condominium building on the north side of the property, extending the full depth of the lot with vehicular access to parking at the north of the lot. (appendices 11, 12, 13).

Present design for the building is for a one-storey base containing entry vestibule, service, guest parking, and amenity space at the front, some apartments at the rear, with upper two residential levels cantilevered over entry drive and access to underground parking and landscaped amenity area along northern side of the property. An added two storeys of residential apartments are located above the first level. The residential building is to be clad in red brick.

Scale of the new building is compatible with the heritage conservation district. It serves as a transition building between the heritage residence on the south and the multi-storey apartment building to the north. Use of red brick, properly scaled fenestration, perimeter landscaping and main entrance facing Kipling add to the scale and compatibility as a transitional structure in the heritage district.

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2.5 Examination of preservation/mitigation options for cultural heritage resources.

Existing structures on the property have a marginal contribution to the preservation/mitigation option for cultural heritage resources, due to their scale.

Maintenance of the street setback with adjacent structures, combined with use of red brick will be consistent with the heritage district.

An existing mature tree presently located in the boulevard would be removed and new street trees are proposed along the face of the planned building.

Avoidance Mitigation

There are no significant cultural heritage resources on the property.

Salvage Mitigation

Salvation mitigation is not considered applicable in this case and is not considered.

Historical commemoration

Historical commemoration is not considered applicable in this case and is not considered.

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2.6 Impact of development / mitigating measures – summary

<i>Potential Negative Impact</i>	<i>Assessment</i>
<ul style="list-style-type: none"><i>destruction of any, or part of any, significant attributes or features</i>	<i>no destruction of any part of significant <u>heritage</u> attribute or feature</i>
<ul style="list-style-type: none"><i>isolation of a heritage attribute from its surrounding environment, context, or a significant relationship</i>	<i>not applicable</i>
<ul style="list-style-type: none"><i>a change in land use where the change in use negates the property's cultural heritage value</i>	<i>land use would remain</i>
<ul style="list-style-type: none"><i>siting, massing, and scale</i>	<i>redevelopment of 1080 Kipling will provide an appropriate use of the site at a scale consistent with guidelines for development within the Heritage District</i>
<ul style="list-style-type: none"><i>design that is sympathetic with adjacent properties</i>	<i>building design fits requirements with the Heritage District.</i>

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4.0 RECOMMENDATION

Section 2 of the *Ontario Planning Act* indicates that City of Vaughan shall have regard to matters of Provincial Interest such as the conservation of features of significant architectural, cultural, historical, archeological, or scientific interest. In addition, Section 3 of the *Planning Act* requires that decision of Council shall be consistent with the *Provincial Policy Statement* (PPS 2014). Policy 2.6.3 of the PPS requires that “...*Planning authorities shall not permit development and site alteration on adjacent lands to protected heritage property except where the proposed development and site alteration has been evaluated and it has been demonstrated that the heritage attributes of the protected heritage property will be conserved.*”

“*Conserved*” means the identification, protection, management and use of built heritage resources, cultural heritage landscapes and archeological resources in a manner that ensures their cultural heritage value or interest is retained under the *Ontario Heritage Act*.“

The property contains no built heritage resource that has cultural value or interest per the criteria for heritage designation under Ontario Regulation 9/06 of the *Ontario Heritage Act*.

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This Cultural Heritage Resource Impact Assessment is respectfully submitted by

MW HALL CORPORATION



Mark Hall, OAA, MRAIC, FAIA, RPP, CAHP
President

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REFERENCES

- a) City of Vaughan Guidelines for Cultural Heritage Impact Assessments
- b) Woodbridge Heritage Conservation District Study and Plan,
- c) Ontario Planning Act, Section 2, regarding City Council responsibility for Provincial Interest heritage properties
- d) Ontario Planning Act, Section 3, regarding requirement that Council decisions are consistent with Provincial Policy Statement of 2014.
- e) Ontario Provincial Policy Statement [PPS 2014] section 2.6.3
- f) Vaughan Official Plan, Land Use, 2010

APPENDICES

- 1- Property Survey, 8010 Kipling Avenue
- 2- Photographs, 8010 Kipling Avenue
- 3- Photographs of existing buildings to north and south sides of subject property
- 4- Vicinity Map, Woodbridge, City of Vaughan, Ontario
- 5- 1860 Tremaine Map, excerpt showing property at center of Maple.
- 6- 1880 Illustrated Atlas Map, showing 8910 Kipling Avenue
- 7- Aerial Photograph of Vicinity of subject property
- 8- Vaughan Official Plan map
- 9- Heritage Conservation District Map, Woodbridge
- 10- Site Plan of planned redevelopment of subject property
- 11- Preliminary Front Elevation Drawing of planned redevelopment of subject property
- 12- Preliminary Rear Elevation Drawing
- 13- Cultural Heritage Summary Evaluation, 8010 Kipling Avenue
- 14- Curriculum Vitae, Mark Hall, OAA, MRAIC, FAIA, RPP, CAHP

SURVEYOR'S REAL PROPERTY REPORT

PART 1:
PLAN OF PART OF THE
NORTH HALF OF LOT 7, CONCESSION 8
(ALSO KNOWN AS LOT 9, DEPOSITED
PLAN 546 WOODBRIDGE)
CITY OF VAUGHAN
REGIONAL MUNICIPALITY OF YORK
SCALE 1 : 200

AKSAN PILLER CORPORATION LTD.
10
20m.

1141

PLAN

CONDOMINIUM

STANDARD

REGION

YORK

LOT 7, CONCESSION 8
PLAN 549 WOODBRIDGE
SUBJECT PIN 0338-1125 (LT)
AREA 18338.8 m²
INSTRUMENT WR 15346
DATE 02/2009

10

PART 2:
PREPARED FOR FIRST AVENUE PROPERTIES
LOCATION OF THE BUILDING: WHOLLY ON THE PROPERTY,
LITTLE BUILDINGS: NONE
DECKS: NONE
EXISTING FENCES: NONE
LINES, WITH DEVIATIONS AS SHOWN
ON THE PLAN, ARE RECORDED IN THE LAST
REGISTERED INSTRUMENT,
AS SHOWN ON PART 1.

LEGEND:

 SURVEY MONUMENT FOUND
 DENOTES SURVEY MONUMENT
 DENOTES IRON BAR
 DENOTES SHORT STANDARD IRON BAR
 DENOTES CUT CROSS
 DENOTES CONCRETE BAR
 DENOTES IRON MONUMENT
 DENOTES NORTH ARROW
 DENOTES SOUTH ARROW
 DENOTES EAST ARROW
 DENOTES WEST ARROW
 DENOTES CHAIN LINK FENCE
 DENOTES BOARD FENCE
 DENOTES POST & WIRE FENCE
 DENOTES PLAN 65R-30502
 DENOTES KMR
 DENOTES YSPC
 DENOTES FH
 DENOTES CB
 DENOTES MH
 0.050 DENOTES TREE TRUNK DIAMETER

METRIC:
DISTANCES SHOWN ON THIS PLAN
ARE IN METRES AND CAN BE
CONVERTED TO FEET BY DIVIDING
BY 0.3048.

BEARING NOTE:
BEARINGS ARE REFERRED TO THE WESTERLY
LINE OF ROAD. COUNTER-clockwise bearings are shown on
the plan. bearings are defined as shown on
BEARING OF N03 44 40 W.
 N03 44 40 W

ELEVATIONS NOTE:
ELEVATIONS SHOWN HEREON ARE GEODETIC AND
ARE DERIVED FROM THE CITY OF TORONTO
BENCH MARK 514 ELEVATION - 185.974m.
 ELEVATION OF N03 44 40 W.
 N03 44 40 W

CAUTION:
TREE CALIPERS ARE NOT TO ARBORIST STANDARDS
AND ARE DEFINED AT 1.5M ABOVE GROUND AT TREE
CALIPER. FOR ARBORIST CALIPER REFER TO ARBORIST REPORT.

SURVEYOR'S CERTIFICATE:
 I CERTIFY THAT:
 1. THE SURVEY AND PLAN ARE CORRECT AND
 IN ACCORDANCE WITH THE SURVEY ACT,
 THE SURVEYS ACT, THE LAND TITLES ACT
 AND THE REGULATIONS MADE UNDER THEM;
 2. THE SURVEY WAS COMPLETED ON
 THE 16th DAY OF OCTOBER, 2017.

OCTOBER 16, 2017
 DATE
 Anna Aksan
 Ontario Land Surveyor

AKSAN PILLER CORPORATION LTD.
 ONTARIO LAND SURVEYORS
 115-187 ELMWOOD AVENUE, TORONTO, ONTARIO, N4P 2L7
 TEL: (416) 488-1188, FAX: (416) 488-1189
 DRAWN: DS CHECKED: HP
 Reference number: 11-24-1280-00

THIS PLAN IS NOT VALID
UNTIL APPROVED
ISSUED BY THE SURVEYOR
IN ACCORDANCE WITH
Regulation 101, Part 2(5).

ASSOCIATION OF ONTARIO
LAND SURVEYORS
PLAN SUBMISSION FORM
PLAN 549 WOODBRIDGE



2- Street View 8010 Kipling



3a) 8008 Kipling Avenue




3b) 8020 Kipling Avenue



3c) 8001 Kipling Avenue





3d) 8009 Kipling Avenue

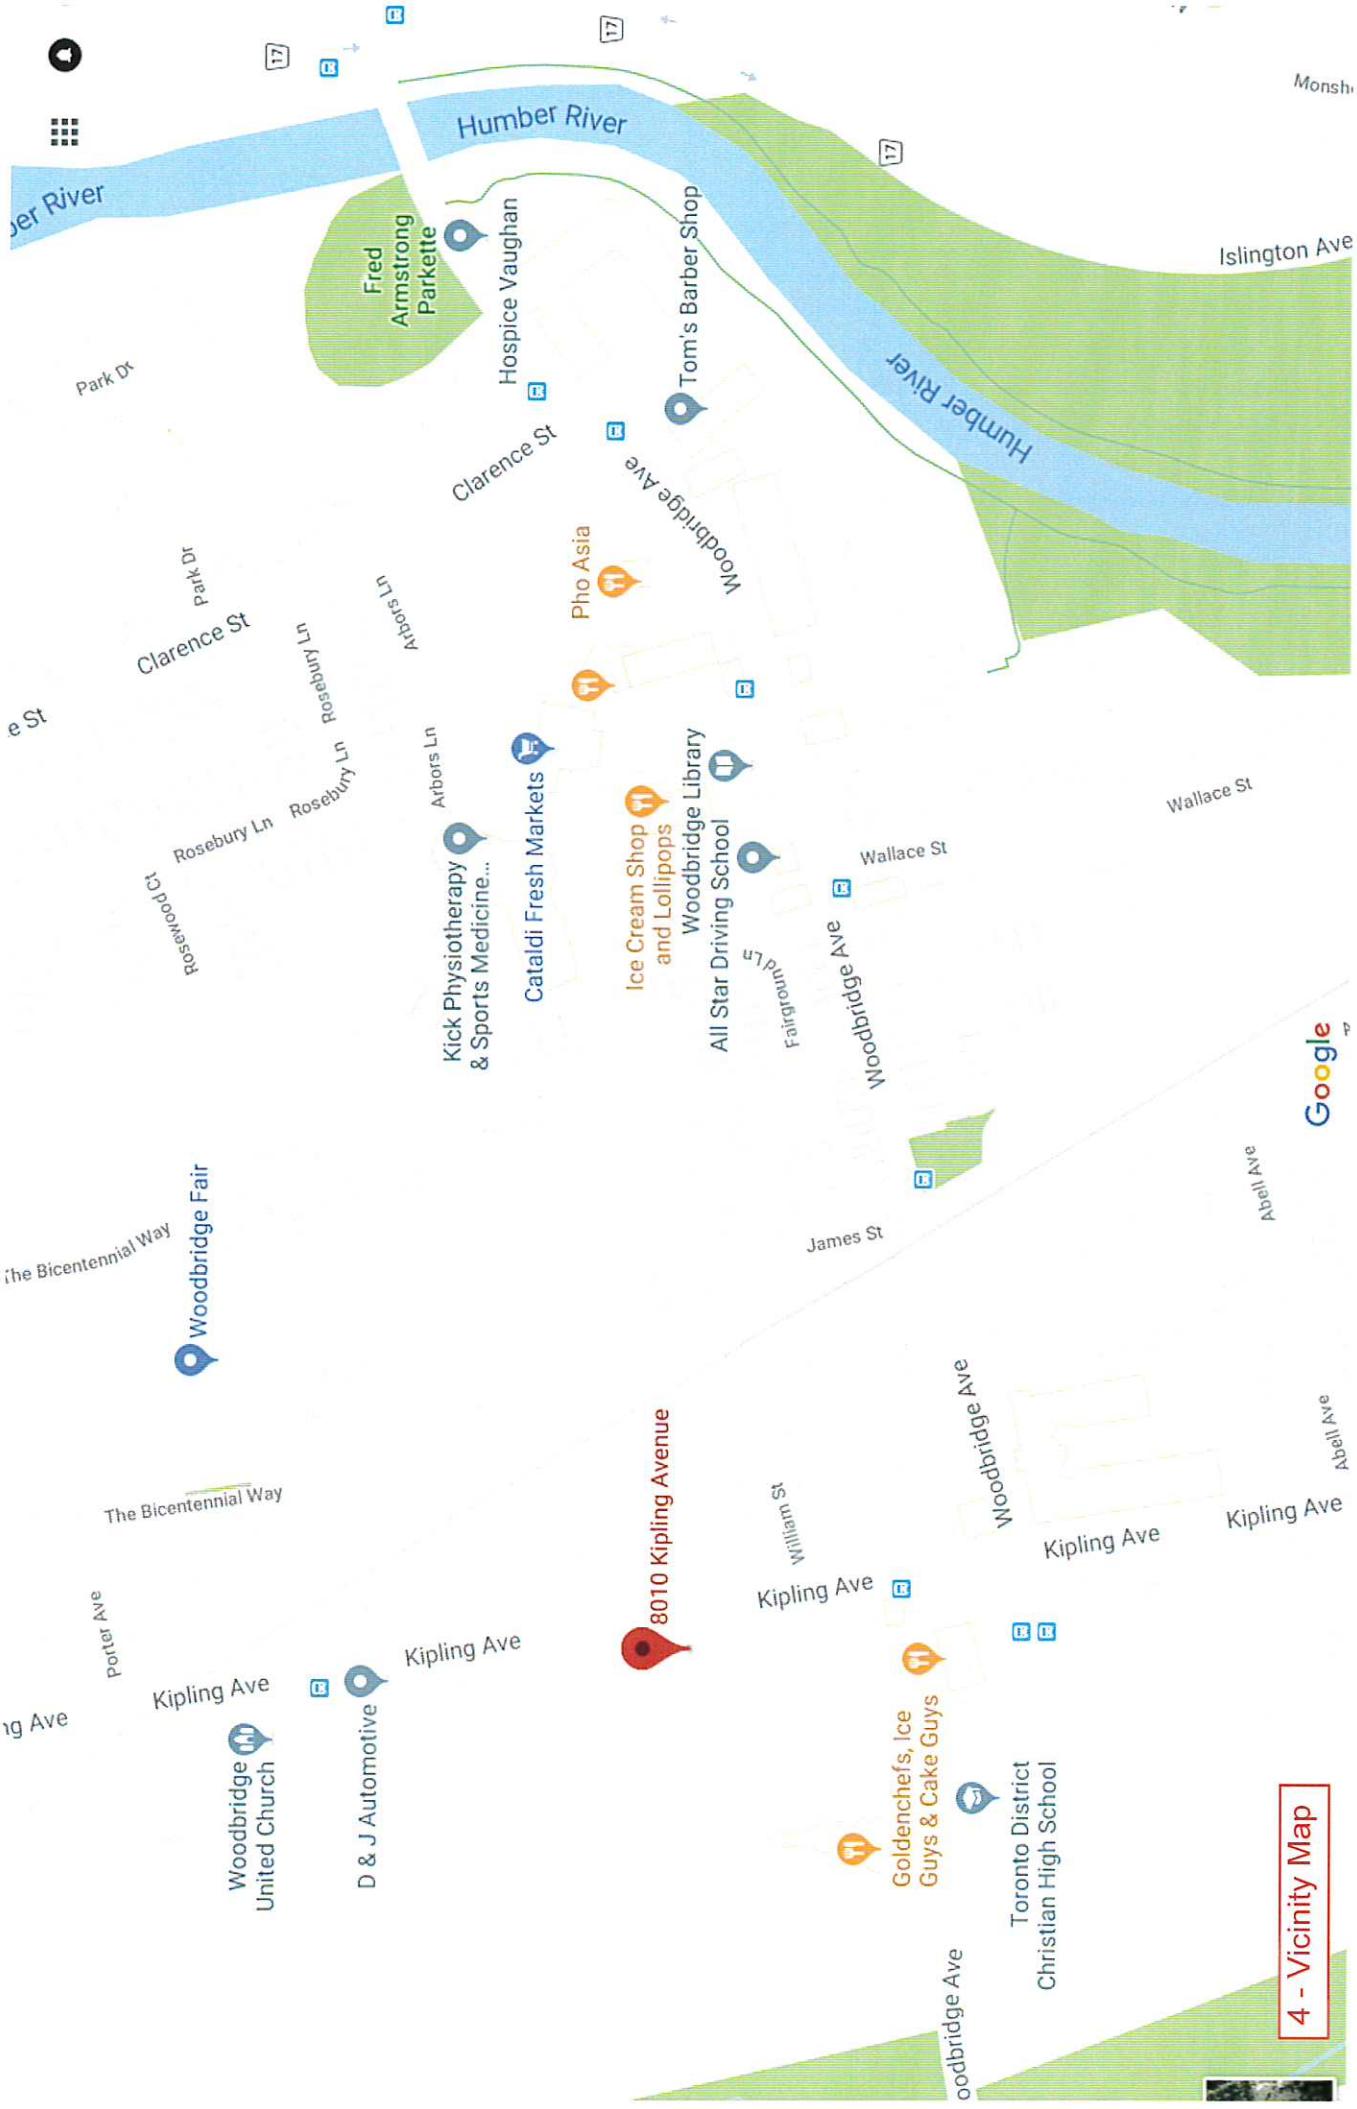

8010 Kipling Avenue

H
G

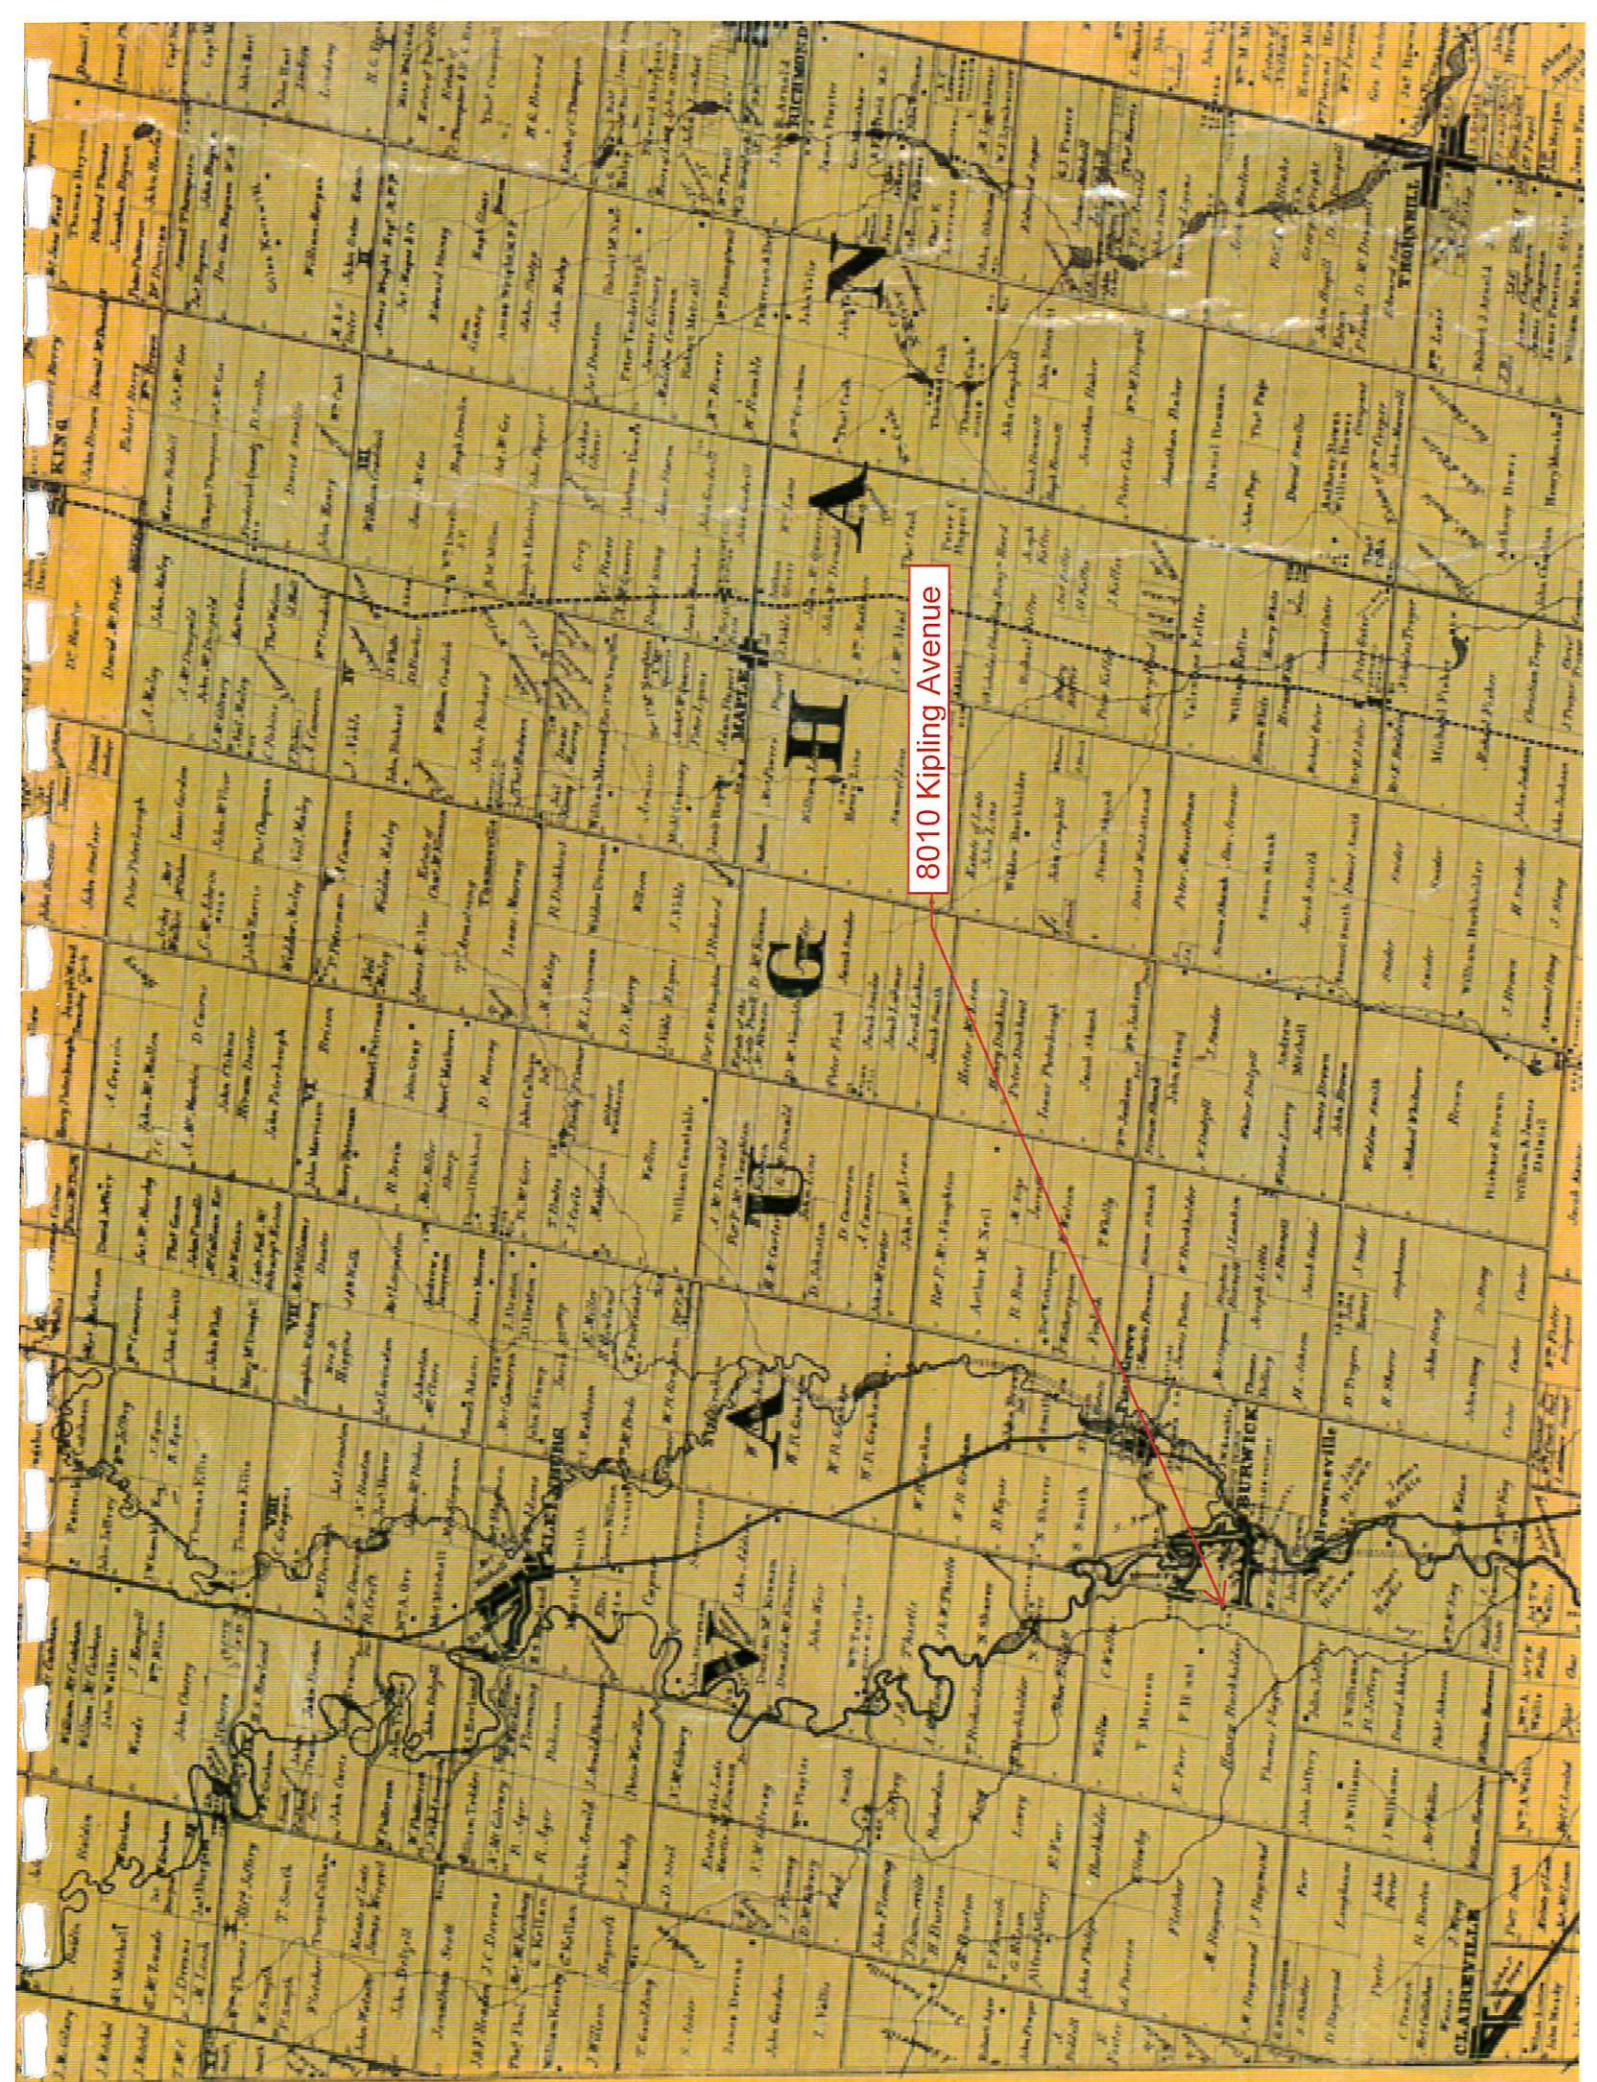

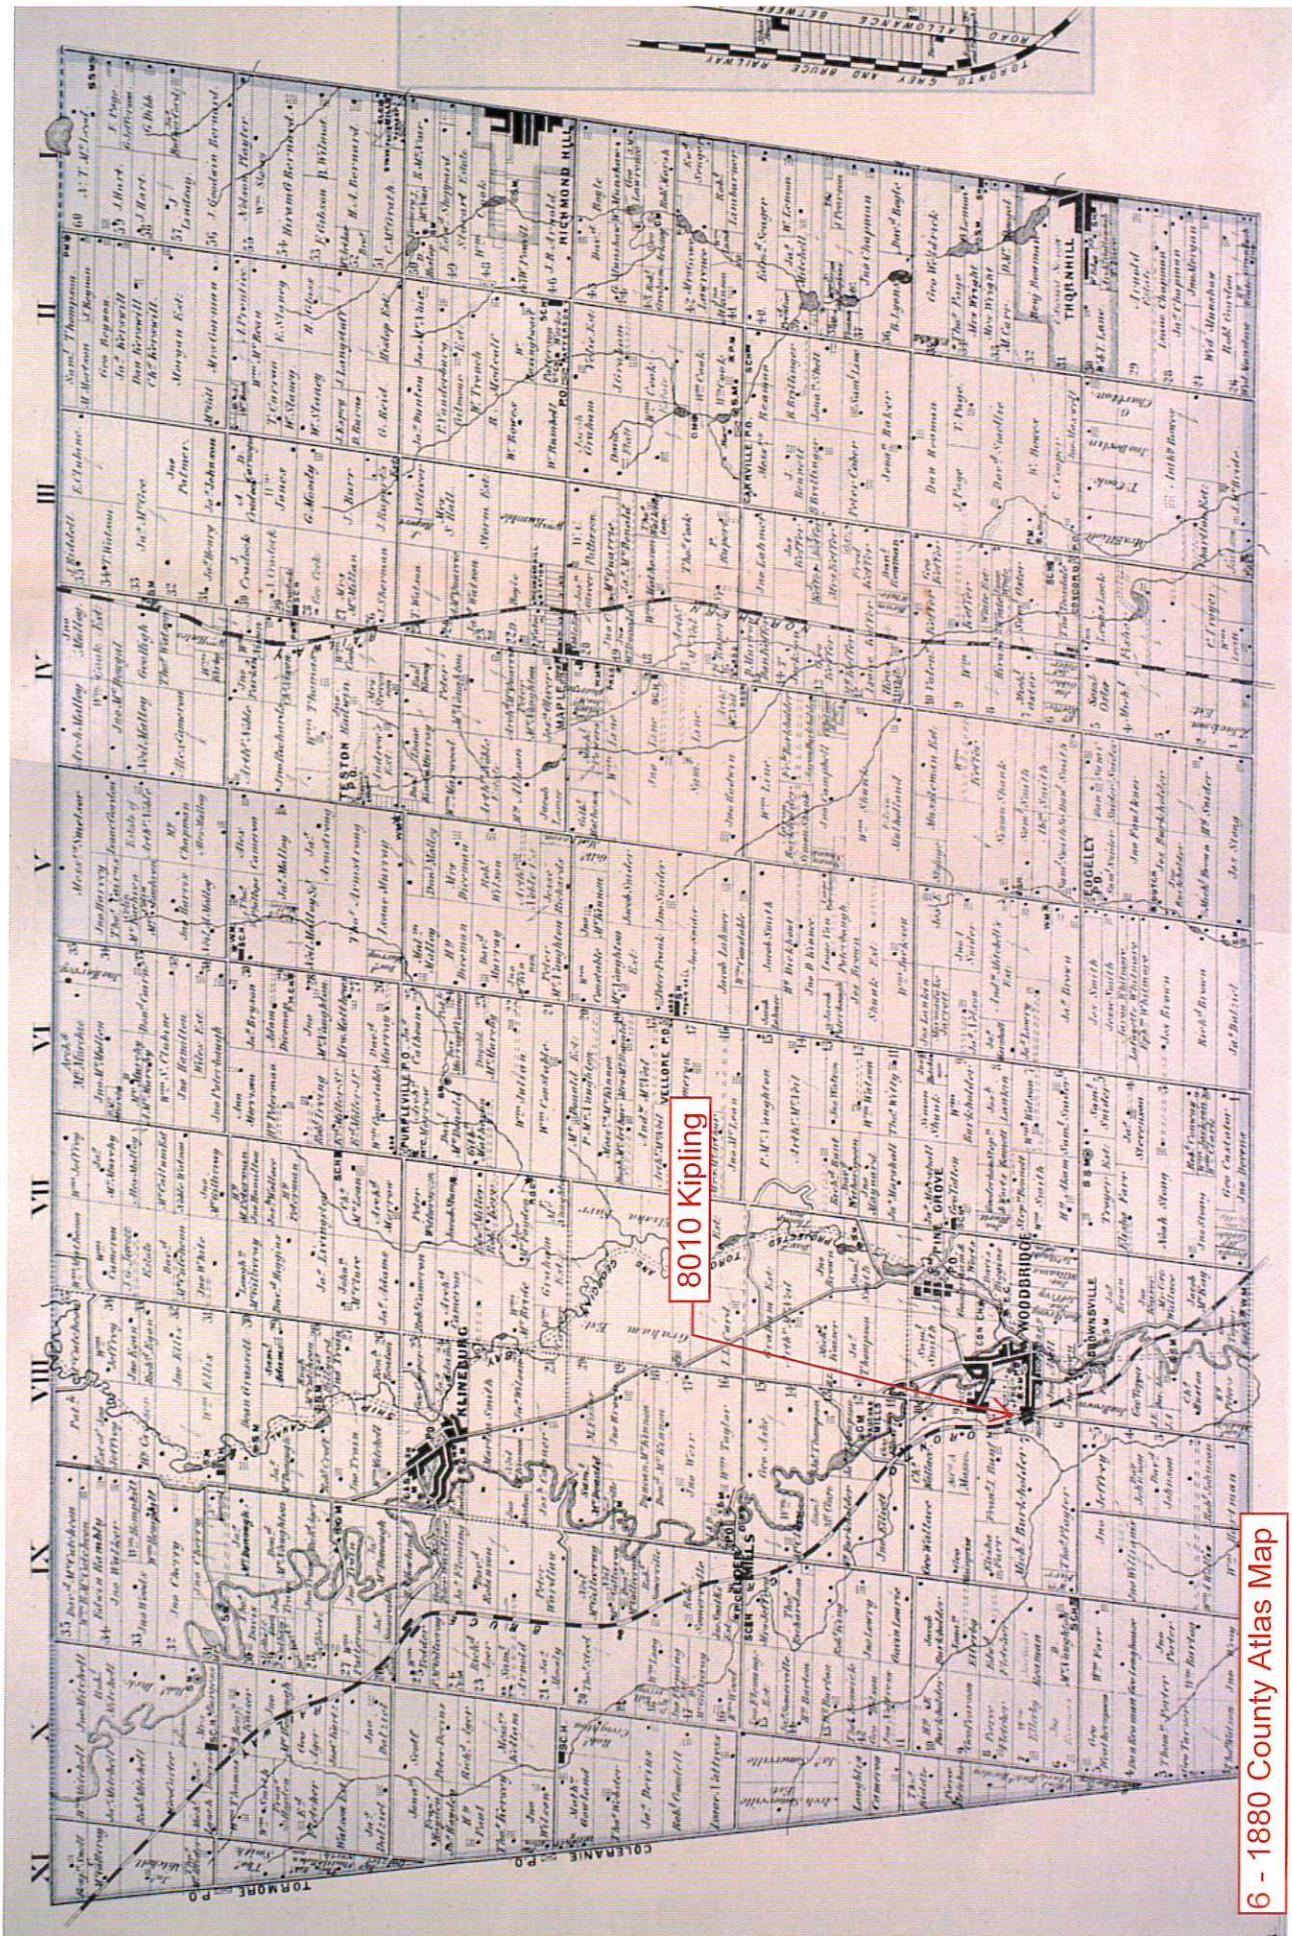


6 - 1880 County Atlas Map





7 - Aerial Map

SCHEDULE 13
Land Use

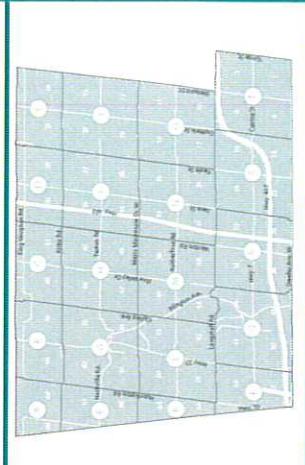

8010 Kipling Avenue

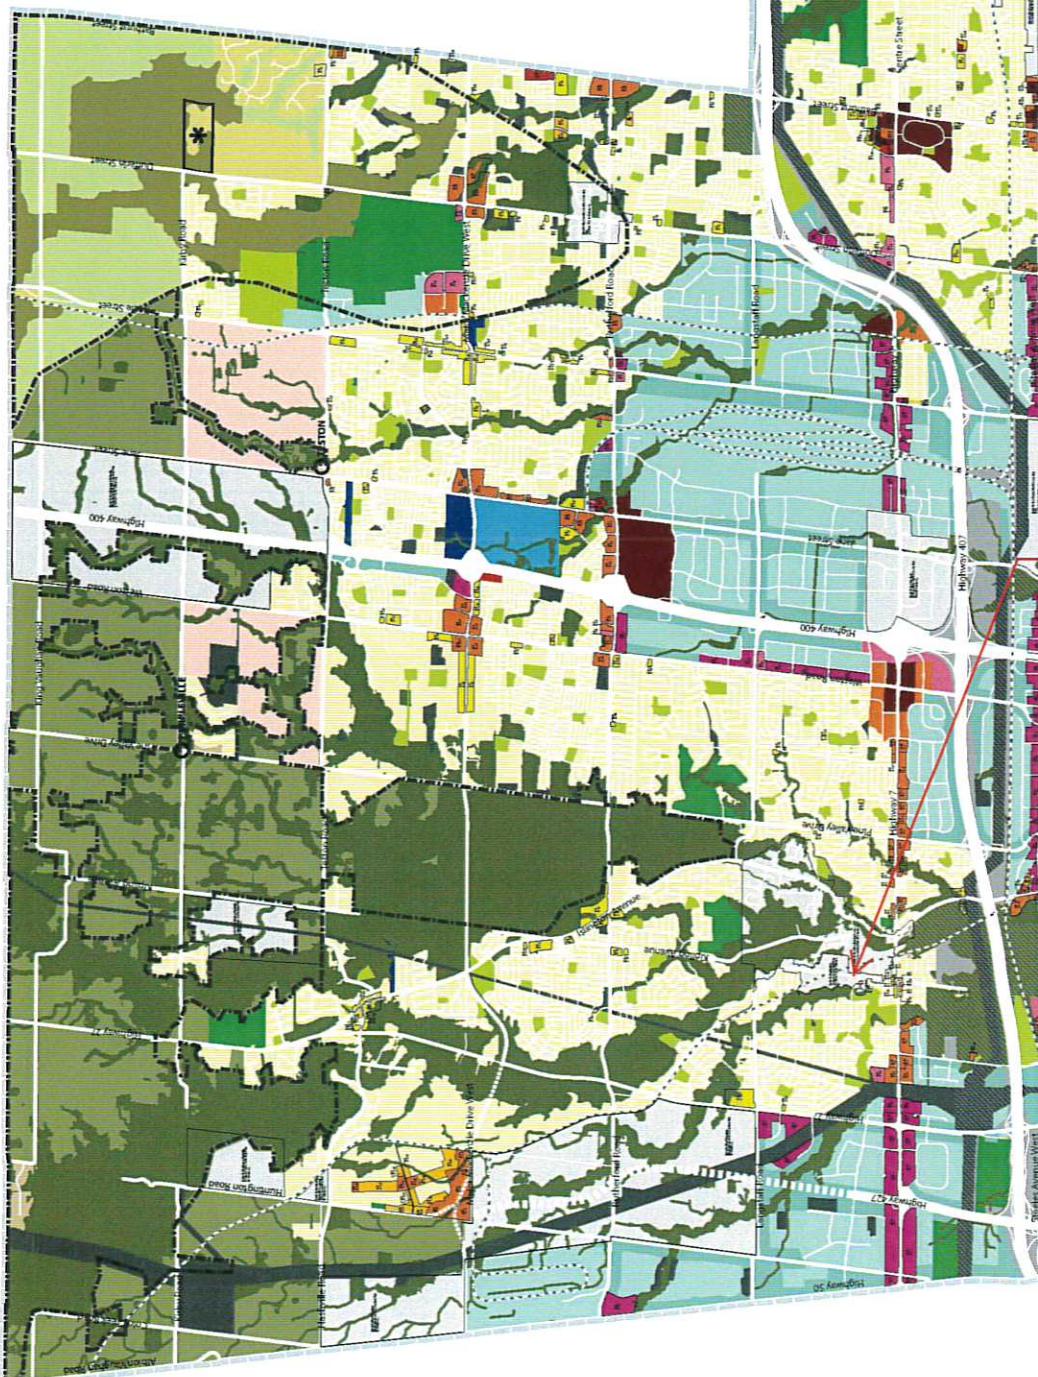

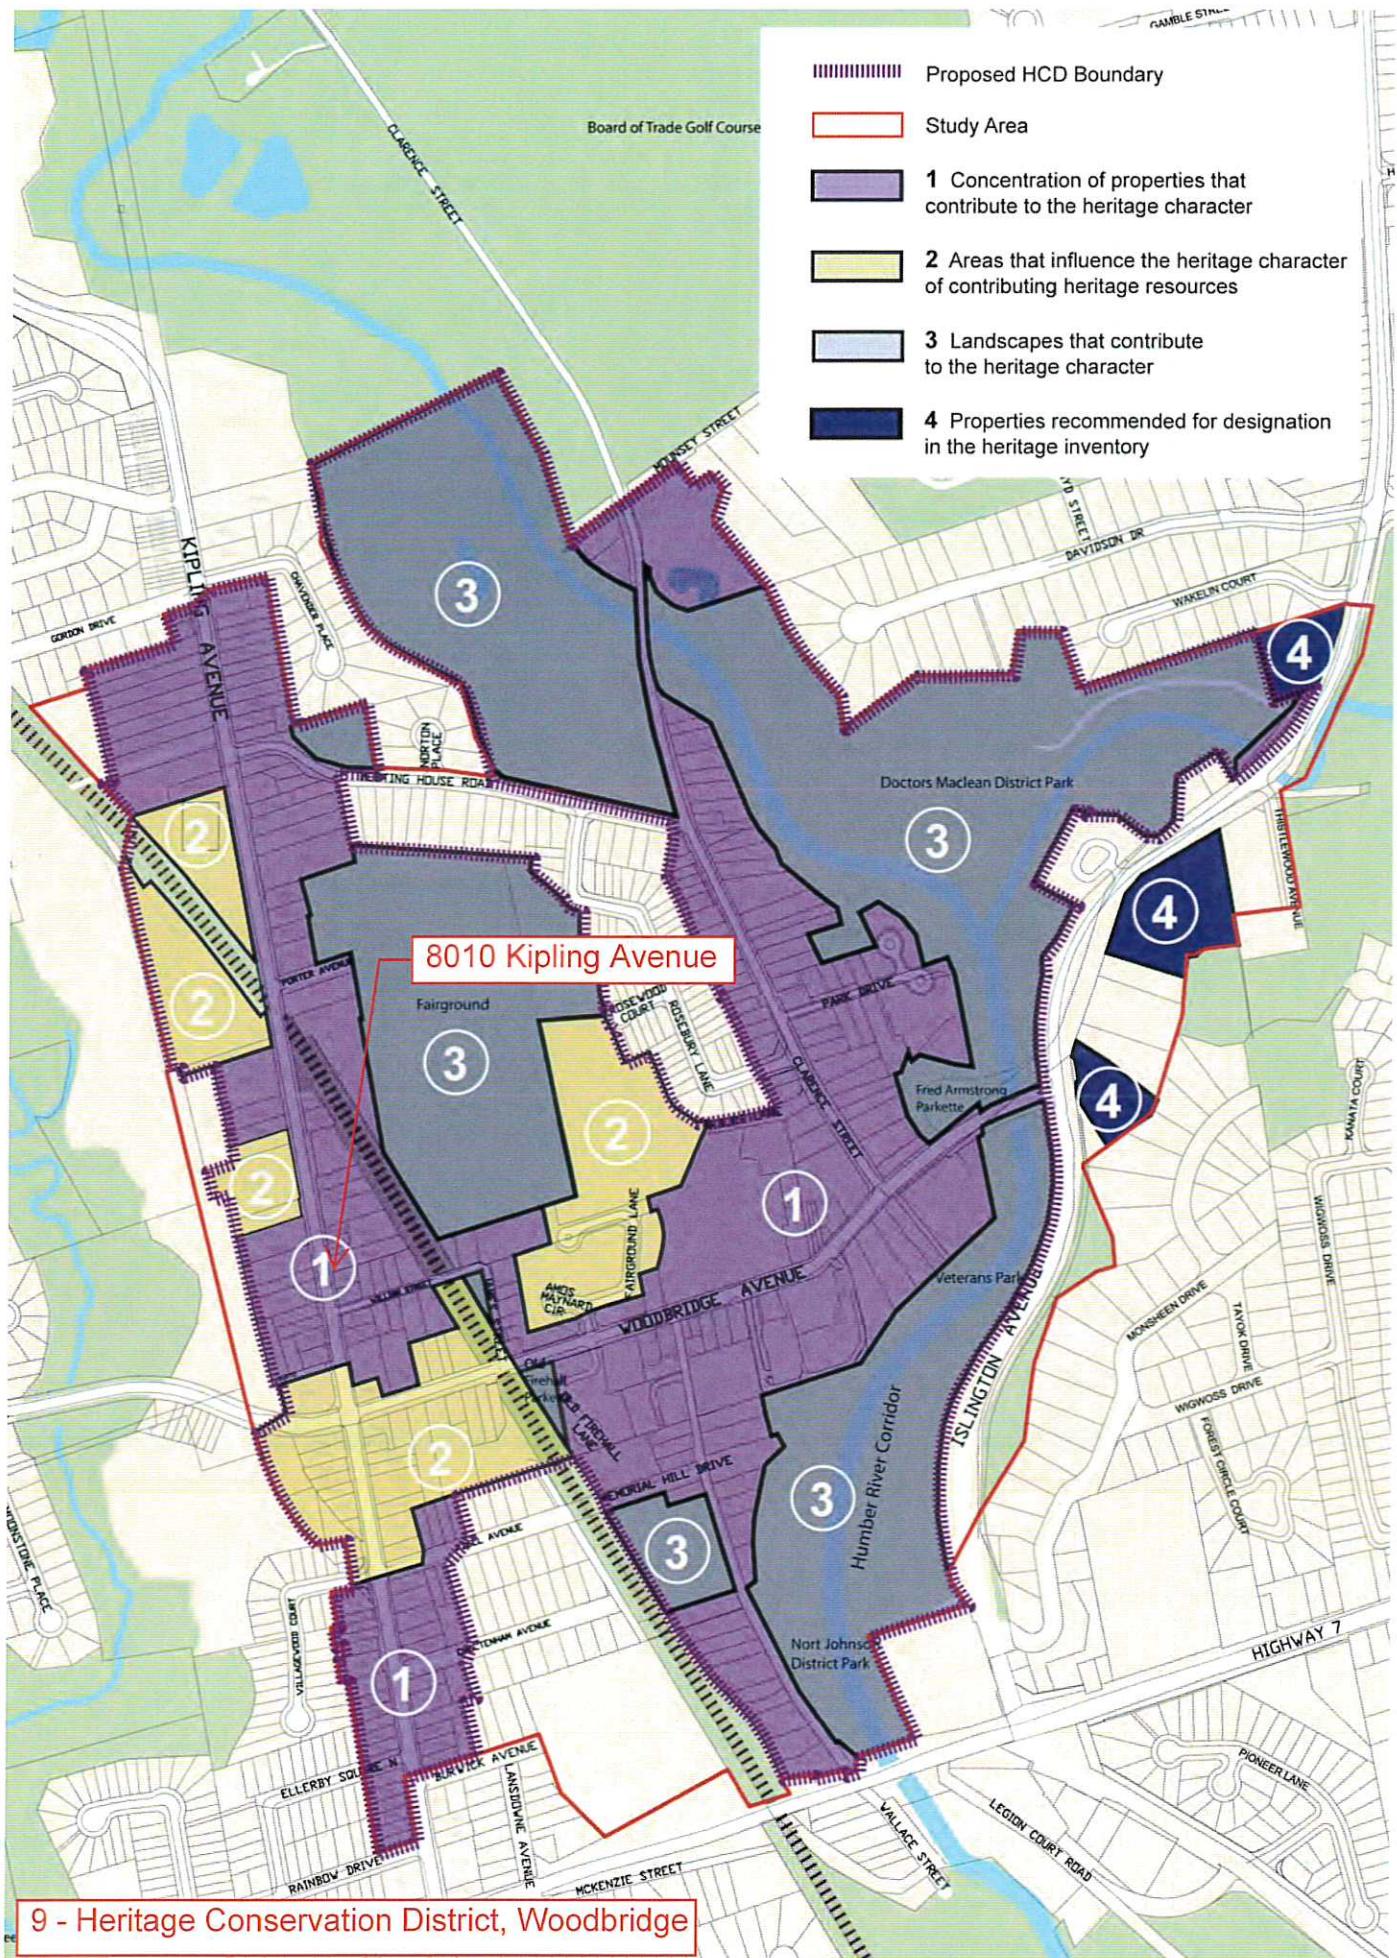

Schedule 8: A Cluster of Properties and Landscapes that Contribute to the HCD Character


FRONT (EAST)
ELEVATION



8010KIPLING, AVENUE
WOODBRIDGE, ON

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I No.	0000000000
Expiry Date	01/01/2023

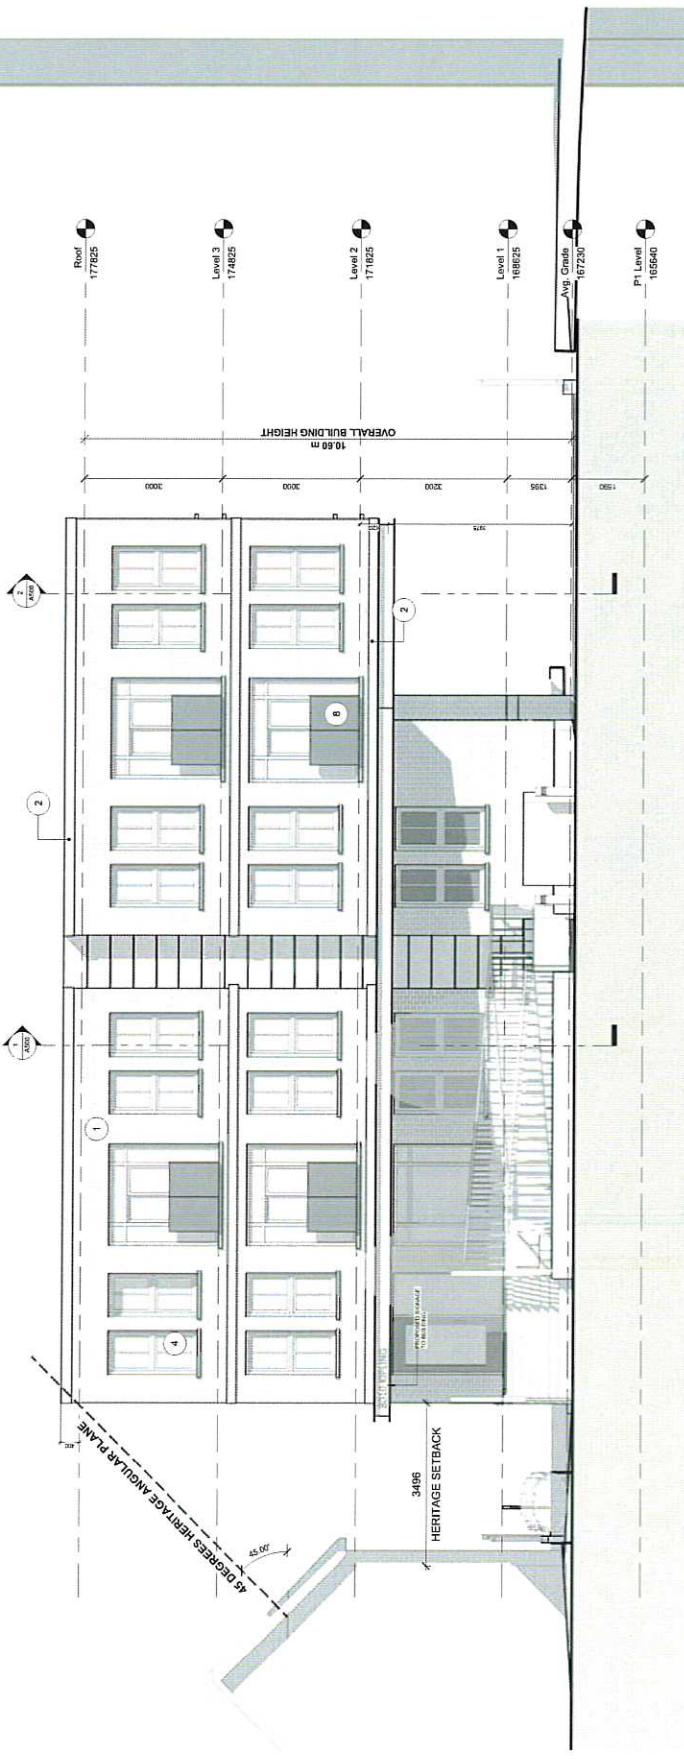

① East Elevation
1 : 50

East Elevation	
Project No:	11064
Scale:	1 : 50
Date:	Issue Date
Drawn by:	Author
Drawing Title	

A400

8010 Kipling Avenue, Woodbridge, Ontario**Heritage Impact Summary Chart****ONTARIO REGULATION 9/06, ONTARIO HERITAGE ACT**

prepared by: MW HALL CORPORATION, Heritage Consultant

15-Jan-18

CRITERIA for determining cultural heritage value, and for determining whether or not a property is worthy of Designation under the Ontario Heritage Act**ASSESSMENT of whether existing conforms to the Ontario Heritage Act**

1.i The property has design value or physical value because it, is a rare, unique or early example of a style, type, expression, material or construction method

1.ii The property has design value or physical value because it, displays a high degree of craftsmanship or artistic merit

1.iii The property has design value or physical value because it, demonstrates a high degree of technical or scientific achievement.

2.i The property has historical value or associative value because it, has direct association with a theme, event, belief, person, activity, organization or institution that is significant to a community.

2.ii The property has historical value or associative value because it, has the potential to yield information that contributes to an understanding of a community or culture

2.iii The property has historical value or associative value because it, demonstrates or reflects the work or ideas of an architect, artist, builder, designer or theorist who is significant to a community

3.i The property has contextual value because it, is important in defining, maintaining or supporting the character of an area.

3.ii The property has contextual value because it, is physically, functionally, visually or historically linked to its surroundings

3.iii The property has contextual value because it, is a landmark

The existing property does not have design value or physical value, is not rare, unique or an early example of a style, type, material or construction method. Further, the residential building has been substantially modified with a major more contemporary addition, with the original masonry covered with stucco and siding. Planned infill of new housing works well as a transition structure between the single family residence to the south and multi-storey apartment to the north of the site.

The existing structure does not display any unusual degree of craftsmanship or artistic merit. Infill replacement is designed to be compatible with the District.

The existing property does not demonstrate any high degree of technical or scientific achievement. Replacement building is properly scaled for the District.

The existing building does not have historical value or associative value significant to the present community of the former community of Maple, now part of City of Vaughan as part of the Designated Heritage District. Planned replacement is contemporary in design, but use of materials, fenestration, orientation to street represents appropriate infill/transitional structure for the District.

Neither the existing residential building nor the planned redevelopment are landmark structures.

Mark Hall, OAA, MRAIC, RPP, MCIP, FAIA, AICP, CAHP

ACADEMIC + PROFESSIONAL TRAINING

Harvard University, Master of City Planning in Urban Design
US Navy Civil Engineer Corps Officer School, Certificate of Graduation
Construction and Design Management
Massachusetts Institute of Technology
Graduate Studies in Planning and Economics
Pratt Institute, Master Degree program studies in Planning and Economics
University of Michigan, Bachelor of Architecture

DESIGN AND CONSTRUCTION EXPERIENCE

Mariposa Land Development Company [1438224 Ontario Inc.] Toronto / Orillia, President	DMJM, Los Angeles, Planner
Orchard Point Development Company [1657923 Ontario Inc.] Orillia, Vice President	Gruen Associates, Los Angeles, Planner
MW HALL CORPORATION, Toronto, Toronto, President Teddington Limited, Toronto, Development advisor, Planner, Architect	US NAVY, Civil Engineer Corps, Officer Apel, Beckert & Becker, Architects, Frankfurt
ARCHIPLAN, Los Angeles, Principal/President	Green & Savin, Architects, Detroit

CITY DEVELOPMENT / URBAN DESIGN / REAL ESTATE DEVELOPMENT

Mark Hall has directed a number of city development and urban design projects, including waterfront revitalization, commercial, multi-unit residential, industrial facilities and major mixed use projects in both public and private clients/employers. He has worked on staff for public agencies, including real estate development and property management services. He understands the dynamics of city development, the techniques required for successful implementation, and procedural, financial and political requirements. His experience and contributions range throughout Canada, the United States, Europe, Southeast Asia, the Middle East and the Arctic. As a result of his extensive experience in this area, he has been invited to participate in the Regional Urban Design Assistance Team [R/UDAT] programs of the American Institute of Architects, and a program of waterfront renewal in Toronto by the Ontario Professional Planners Institute. He is a Registered Professional Planner in Ontario, member of the Canadian Institute of Planners, and a founding member of the American Institute of Certified Planners. Recently, as president of Mariposa Land Development Company, he designed and built a 54 unit condominium apartment project designed to upgrade the waterfront of historic downtown Orillia, Ontario. The building has spurred a number of revitalization projects in Orillia.

HISTORIC PRESERVATION / ADAPTIVE REUSE

Mr. Hall has developed special interest and expertise in historic preservation and adaptive reuse of historic structures and city districts. He has served as president of the Los Angeles Conservancy, and designed projects combining historic preservation and appropriate adaptive reuse of the properties. He is a member of the Canadian Association of Heritage Professionals. Recently he served as preservation architect on renovations of the RC Harris Water Plan, a designated cultural heritage building in Toronto. He has served as architect for restoration and additions to a number of historic houses in the Annex, Beaches and other areas of central city Toronto, as well as Belleville, Orillia, Mississauga and Brampton, and in Los Angeles and Florida. He frequently works with property developers, municipalities and heritage property owners as consultant regarding historic properties of concern to municipalities in which they are working.

ARCHITECTURE

A licensed architect for over 40 years, Mr. Hall is licensed to practice in Canada and the US. He has been responsible for design and construction of a number of significant projects: mixed use structures, corporate headquarters and industrial facilities, military facilities, multi-unit residential, civic and commercial centres, and seniors housing. He understands the design, construction and real estate development process, as well as management of multi-disciplinary and client concerns for cost effective, efficient, award-winning structures. Many of the structures he has built are the result of implementing more comprehensive master planned developments. For his work in historic preservation, education and community service he was awarded Fellowship in the American Institute of Architects.

COMMUNITY & EDUCATION SERVICE

In addition to professional practice, Mr. Hall has made major commitments to teaching and community service. He taught urban design and city planning at USC, UCLA, Southern California Institute of Architecture [SCI ARC] and Boston Architectural Center. While at Harvard he worked with the Harvard Urban Field Service in Boston's Chinatown. As an officer in the US NAVY he was awarded a special Commendation Medal for development of a master plan for the NAVY's Arctic Research Laboratory and the adjacent Inupiat community of Barrow, Alaska. His work has been published in professional journals and has received various awards and honors. He served on the board of directors and later as president of the Southern California chapter of the American Institute of Architects. He was co-chair for the Ontario Professional Planners Institute [OPPI] of a multi-disciplinary design Charette to determine the future of the Metropolitan Toronto waterfront, and later on a committee of the Ontario Association of Architects looking into solutions to urban sprawl. He has served as president of the non-profit Housing Development Resource Centre [HRDC] and as president of Toronto Brigantine, a non-profit organization providing sail training aboard two tall ships in the Great Lakes.



ATTACHMENT #2

Context Map/Concept Plan

ATTACHMENT #3



Aerial Orthographic Plan Project No.: 17064 Date: FEB 27 2018 Drawing No.: A
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 First Avenue Properties


Project No.: 

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Issue / Designation Date: 20180301 Issued for SPA 01
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 KFA architects + planners inc. 197 Stoney Avenue • Suite 100 Toronto, Ontario M5S 2C8 416 633 6229 kfapro.com

ATTACHMENT #4



8010

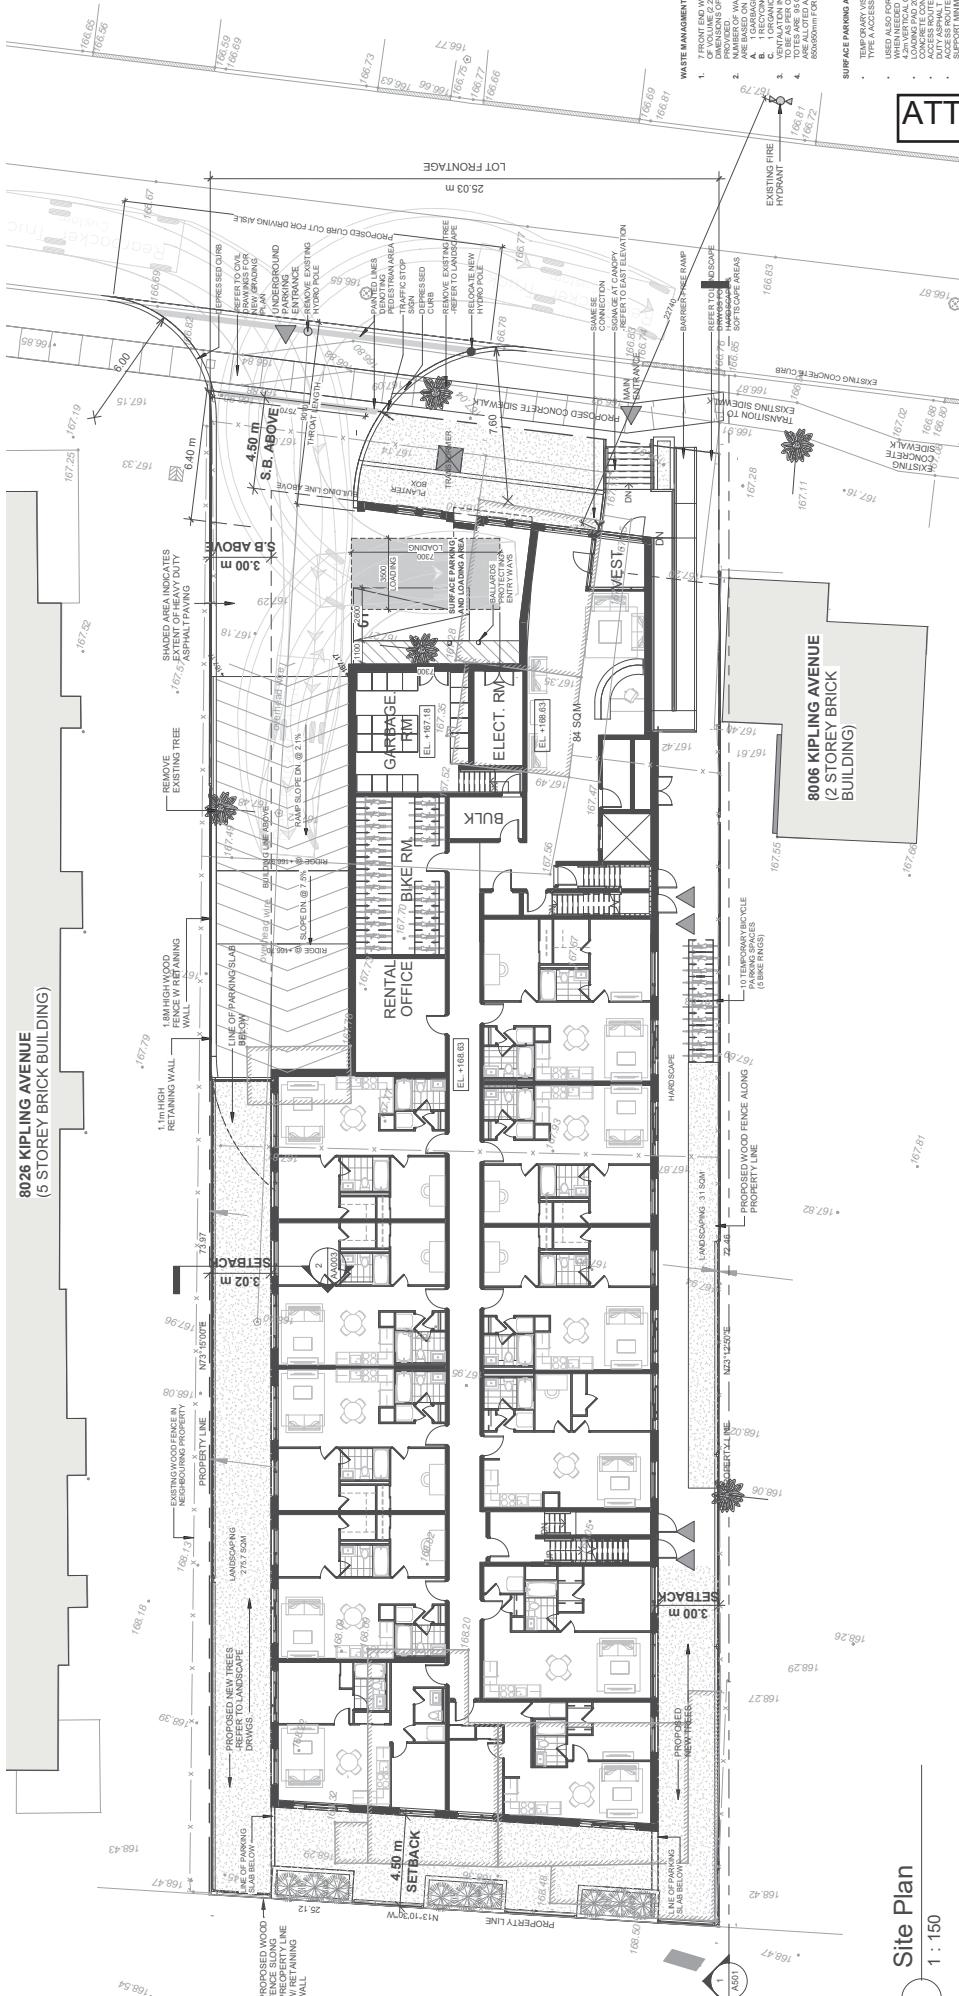KIPLING, AVENUE
WOODBRIDGE, ON

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DRAWING LIST

Sheet No.	Sheet Name
2000	Cover Sheet
2000	Architectural & Site Plan
2000	Plot Plan
2000	Construction Phase
2000	Roof & Elevation
2000	Architectural Details
2000	Landscaping Plan
2000	Soil Test Results
2000	Architectural Details
2000	Architectural Details

CLIENT
FIRST AVENUE
architects +
planners inc.
100, 600, 1000
Project North



architects +
planners inc.

ATTACHMENT #5



ISSUED FOR SPA: JANUARY 11, 2019

Cover Page

TRAFFIC CONSULTANT

NEXTTRANS
15280 YONGE STREET
SUITE 204
AURORA, ONTARIO
L4N 1N4
TEL: 905-503-2563

ENVIRONMENTAL ENGINEER

RUBIDIUM ENVIRONMENTAL INC.
845 CITYVIEW BLVD
SUITE 204/205
UNIT 200B
BURLINGTON, ONTARIO
L7N 3P3
TEL: 905-635-4063

LIGHTING ENGINEER:

E.LUMEN INTERNATIONAL INC.
595 CITYVIEW BLVD
SUITE 204/205
MISSISSAUGA, ONTARIO
L4W 1Y1
TEL: 905-528-4044

NOISE ENGINEER:

HGC ENGINEERING
2000 ARGENTIA ROAD
SUITE 203
MISSISSAUGA, ONTARIO
L4W 1Y1
TEL: 416-756-7769

HERITAGE CONSULTANT:

MW HALL CORPORATION
21 SCOLIARD STREET
TORONTO, ONTARIO
M5R 1G1
TEL: 416-920-8105

ARCHITECT & PLANNERS:

KFA ARCHITECTS + PLANNERS INC.
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TORONTO, ONTARIO
M5T 2C8
TEL: 416-533-9226
FAX: 416-531-5353

Drawn by:
AA

Drawing Number
Drawing Title


Project No: 17064
Scale: _____
Date: 01/10/2019

8010

KIPLING, AVENUE
WOODBRIDGE, ON

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No.	Description	Date
5521-005	Site Plan	05/07/2019
5521-006	Architectural	05/07/2019

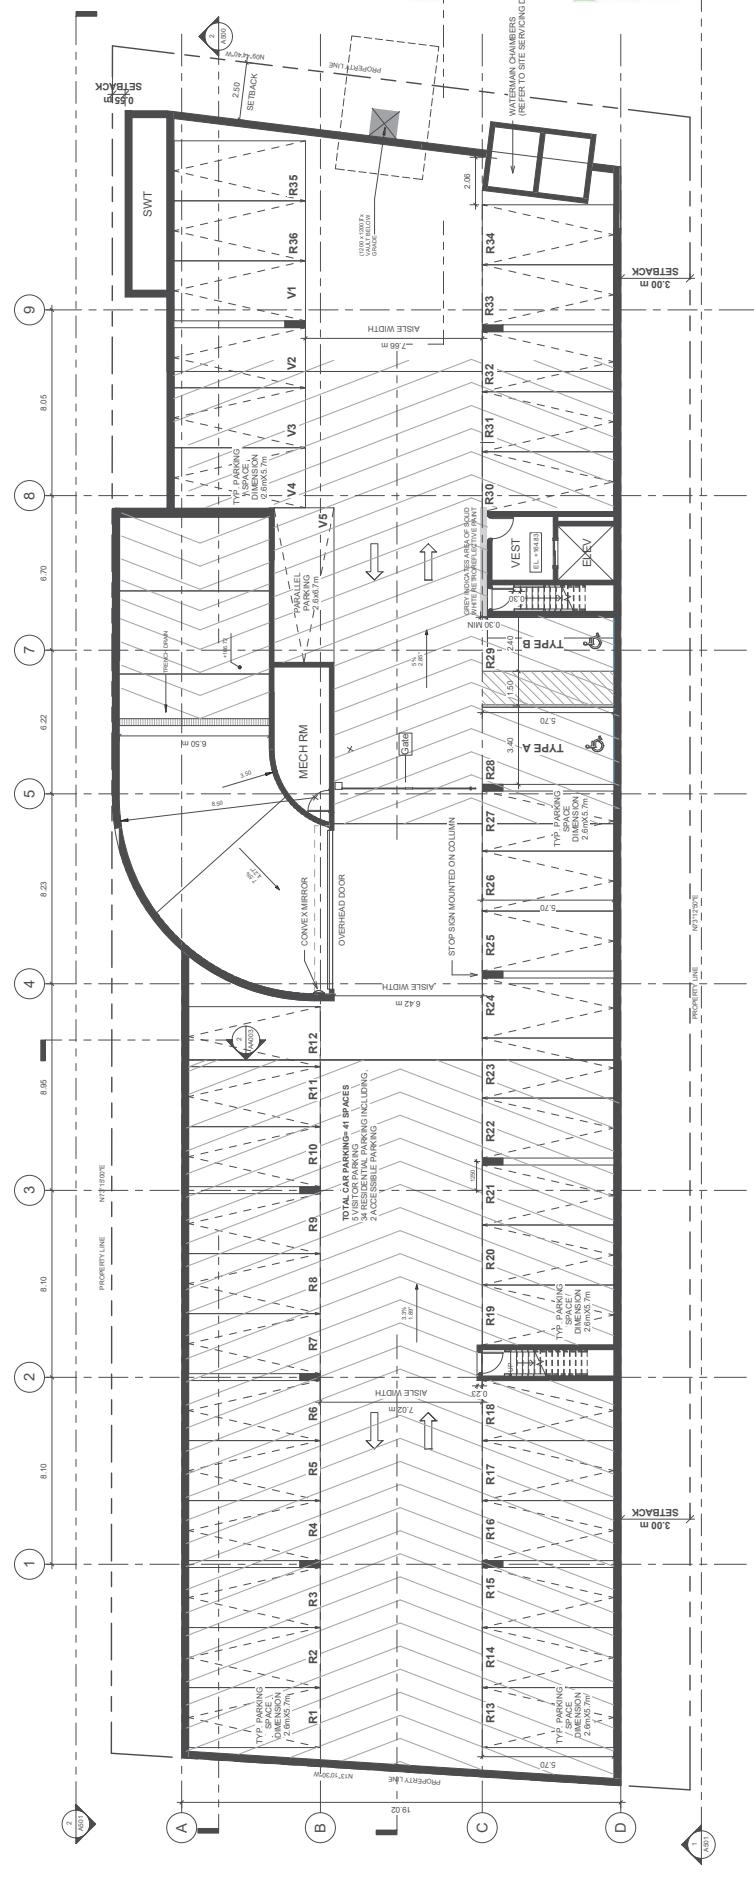

ATTACHMENT #6

Project North
N
Drawing Number
P1 Parking Level
Drawing Title
Author
Date: 01/10/2019
Scale: 1:100
Project No.: 17864
Drawn by:

A200
Drawing Number
P1 Parking Level
Drawing Title
Author
Date: 01/10/2019
Scale: 1:100
Project No.: 17864
Drawn by:

A200

8010

KIPLING, AVENUE
WOODBRIDGE, ON

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No.	Description	Date
1	MAIN FLOOR PLAN	05/07/2019
2	SECTION A-A1	05/07/2019

Project North



FIRST
AVENUE
A SUBDIVISION OF FIRST AVENUE INC.
10,000 SQ.FT.
100% LEASABLE AREA
100% LEASABLE AREA
100% LEASABLE AREA

architects +
planners inc.

ATTACHMENT #7

A201

Drawing Number

Ground Floor Plan

Drawn by:

Drawing Title

Project No:

Scale:

Date:

01/10/2019

F.S.



Main Level
1 : 100

8010

KIPLING, AVENUE
WOODBRIDGE, ON

8026 KIPLING AVENUE

(3 STOREY BRICK BUILDING)

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Engineering of A. A. Associates Inc. and/or Project No. 17864

Date: 05/10/2019

No.	Description	Date
1	8026 KIPLING 8026 KIPLING AVENUE	05/10/2019



Project No.: 17864
Scale: 1 : 100
Date: 05/10/2019
Drawn by:
Drawing Title
Author

Level 02 & 03 (TYP.)
Drawing Number

A202

ATTACHMENT #8

8006 KIPLING AVENUE
(2 STOREY BRICK BUILDING)

1 Level 2
1 : 100

8010

KIPLING, AVENUE
WOODBRIDGE, ON


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No.	Description	Date
1	Master Site Plan	2020-07-08
2	Site Plan	2020-07-08

CLIENT
FIRST AVENUE
Architects + Planners Inc.
10,000 sq ft office space
Project North



ATTACHMENT #9

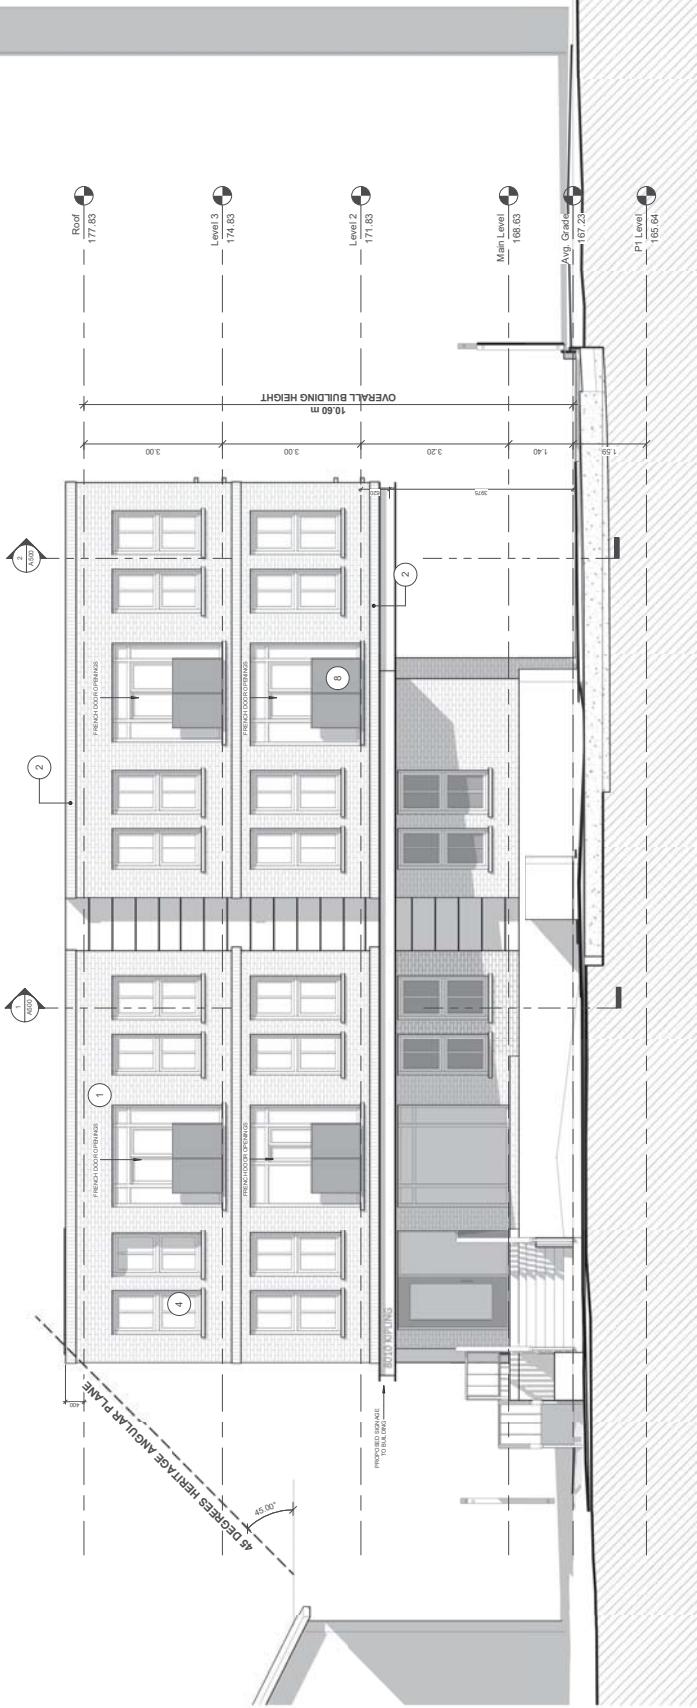

East Elevation
(1) 1 : 50

East Elevation

Project No: 17064

Scale: 1 : 50

Date: 01/10/2019

Drawn by:

Author

Drawing Number


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8010KIPING, AVENUE
WOODBRIDGE, ON


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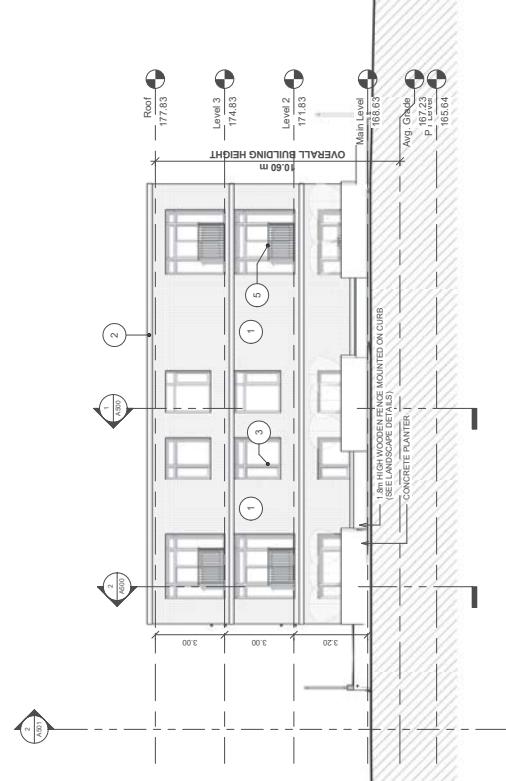
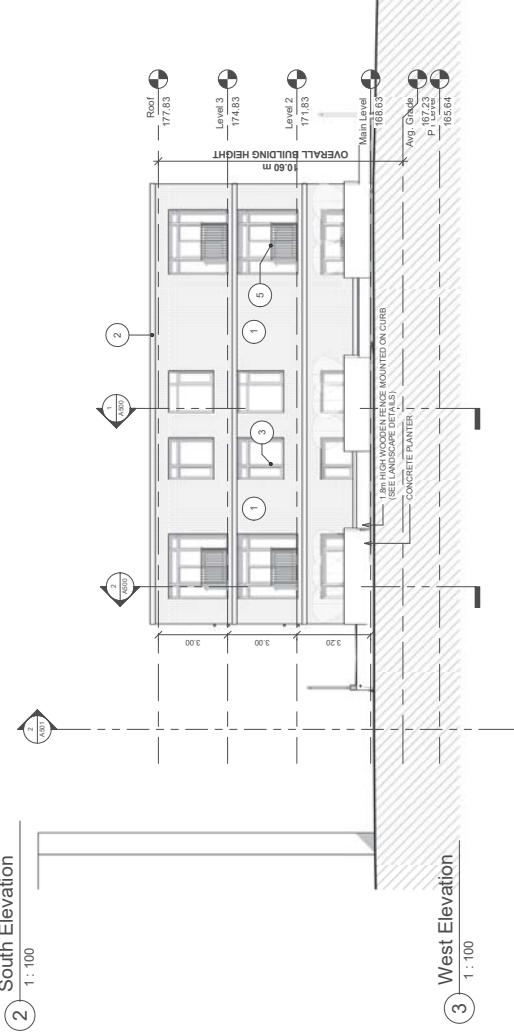
No. Description Date
1 8010-AVNE 30/07/2018
2 8010-AVNE 30/07/2018



1 North Elevation 1:100

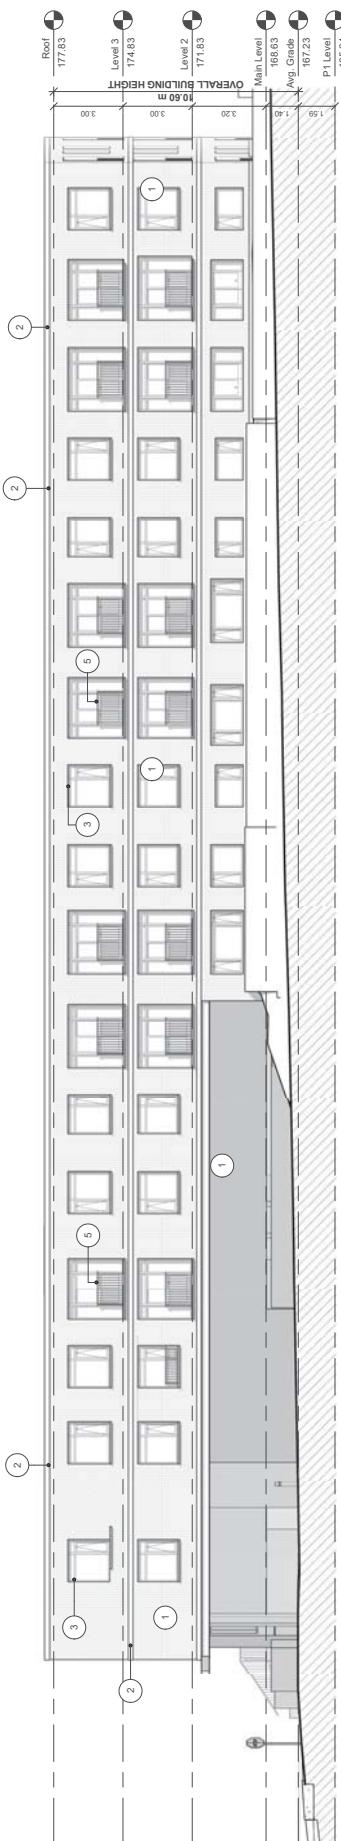

2 South Elevation 1:100

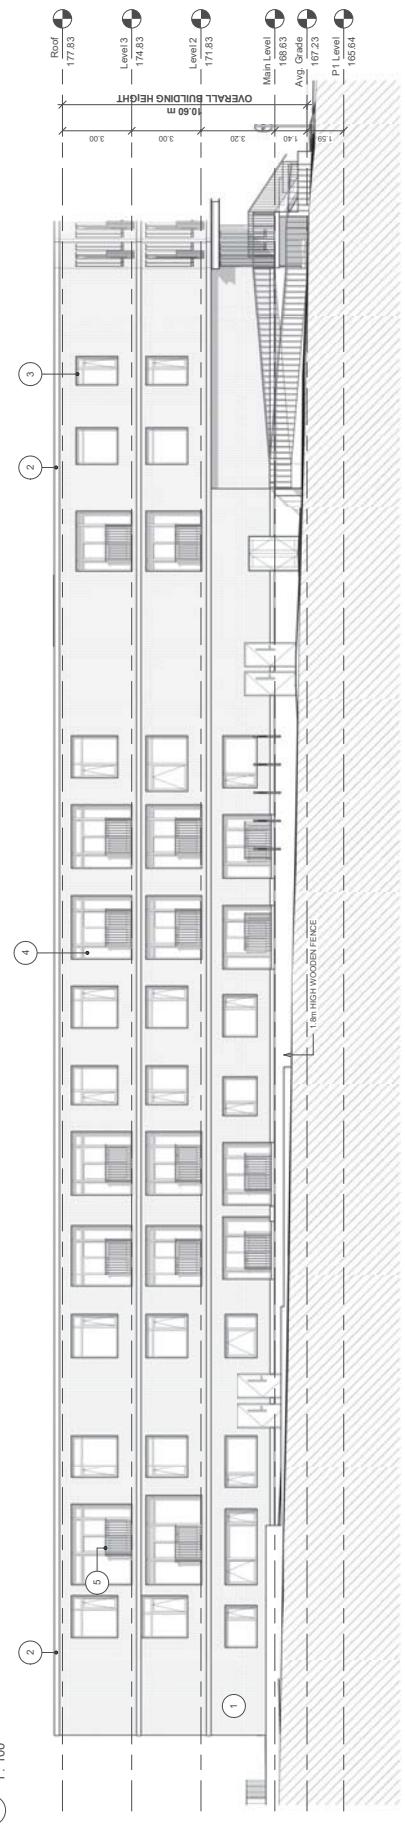

MATERIAL LEGEND	
TYPE	DESCRIPTION
(1)	MASONRY - ECLIPIC REGULAR NORMA CHAMFERED CROWN
(2)	WINDOW WALL SYSTEM CLEAR GLAZING
(3)	Glass railings - sandon asf ted CLEAR FINISH
(4)	DIRECT GALVANIZED STEEL RAILINGS
(5)	CANOPY - STEEL URETHANE PAINTED ASSEMBLED SANDON ASF TED
(6)	CANOPY - STEEL URETHANE PAINTED CHARCOAL GREY
(7)	PHENOLIC CLADDING - CHARCOAL GREY

ATTACHMENT #10


Project No: 17064
Scale: As indicated
Date: 01/10/2019
Drawn by:
Author:

Drawing Title
North, South & West Elevation
Drawing Number

A401

8010KIPLING, AVENUE
WOODBRIDGE, ON

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No.	Description	Date
1	MAIN DOOR	05/07/2019
2	REAR DOOR	05/07/2019




1 MASONRY
RED BRICK, REGULAR NORMA SIZE, RUNNING BOND,
COLOUR AS SHOWN IN IMAGE




2 MASONRY
YELLOW BRICK, REGULAR NORMA SIZE, VERTICALLY
STACKED BOND, COLOUR AS SHOWN IN IMAGE



3 CLADDING
PREFINISHED ALUMINUM CLADDING, COLOR CHARCOAL GREY

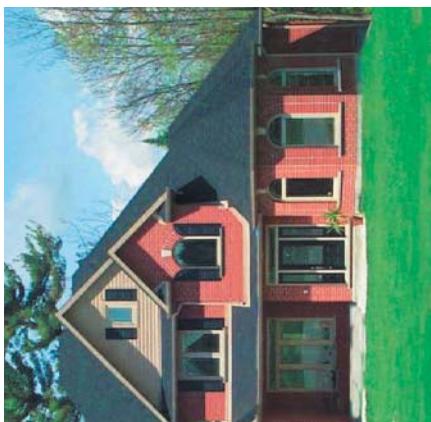

4 WINDOW WALL SYSTEM
WINDOW WALL SYSTEM WITH CHARCOAL GREY MULLIONS
AND CLEAR GLAZING

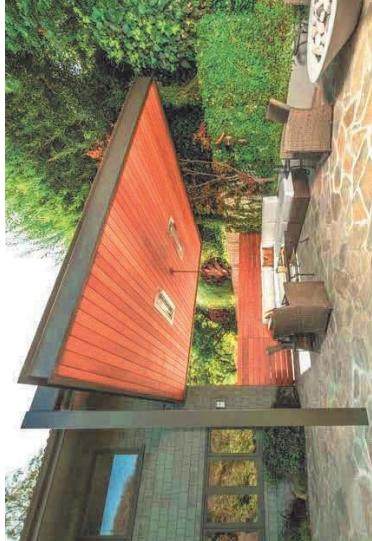**ATTACHMENT #11**

**5 GALVANIZED
STEEL RAILINGS**

HOT DIPPED GALVANIZED STEEL
RAILINGS, CLEAR FINISH

6 CANOPY I BEAM
CANOPY STEEL I-BEAM PAINTED
CHARCOAL GREY

STAINED WOOD FINISH CEILING
AND WOOD PANELS, PRODEMA,
OR EQUIVALENT

7 CANOPY CEILING

HOT DIPPED GALVANIZED STEEL
RAILINGS, CLEAR FINISH

**8 SANDBLASTED GLASS AND
ALUMINUM RAILING**

GLASS AND ALUMINUM RAILING WITH SANDBLAST GLAZING

9 ARCHITECTURAL CONCRETE FINISH

Drawn by:
Drawing Title
Architectural
Materials
Drawing Number

CLIENT
FIR
ST AVENUE
Architects +
planners inc.
10, 6000 10th Avenue
Project North
17/04

KFA
architects +
planners inc.
10, 6000 10th Avenue
Project North
17/04

Author
Drawing No:
Scale:
Date:
01/10/2019

A600

8010

KIPLING AVENUE
WOODBRIDGE, ON




LANDSCAPE LEGEND

	SOD (34 m²)
	UNIT PAVERS (26 m²)
	CONCRETE SIDEWALK (132 m²)
	NEW TREE
	EXIST. TREE TO BE REMOVED (dotted)
	SHRUB PLANTING, AS PER PLAN
	SHRUB PLANTING, AS PER PLAN
	PROPERTY BOUNDARY
	NEW FENCE



Project North

ATTACHMENT #12a

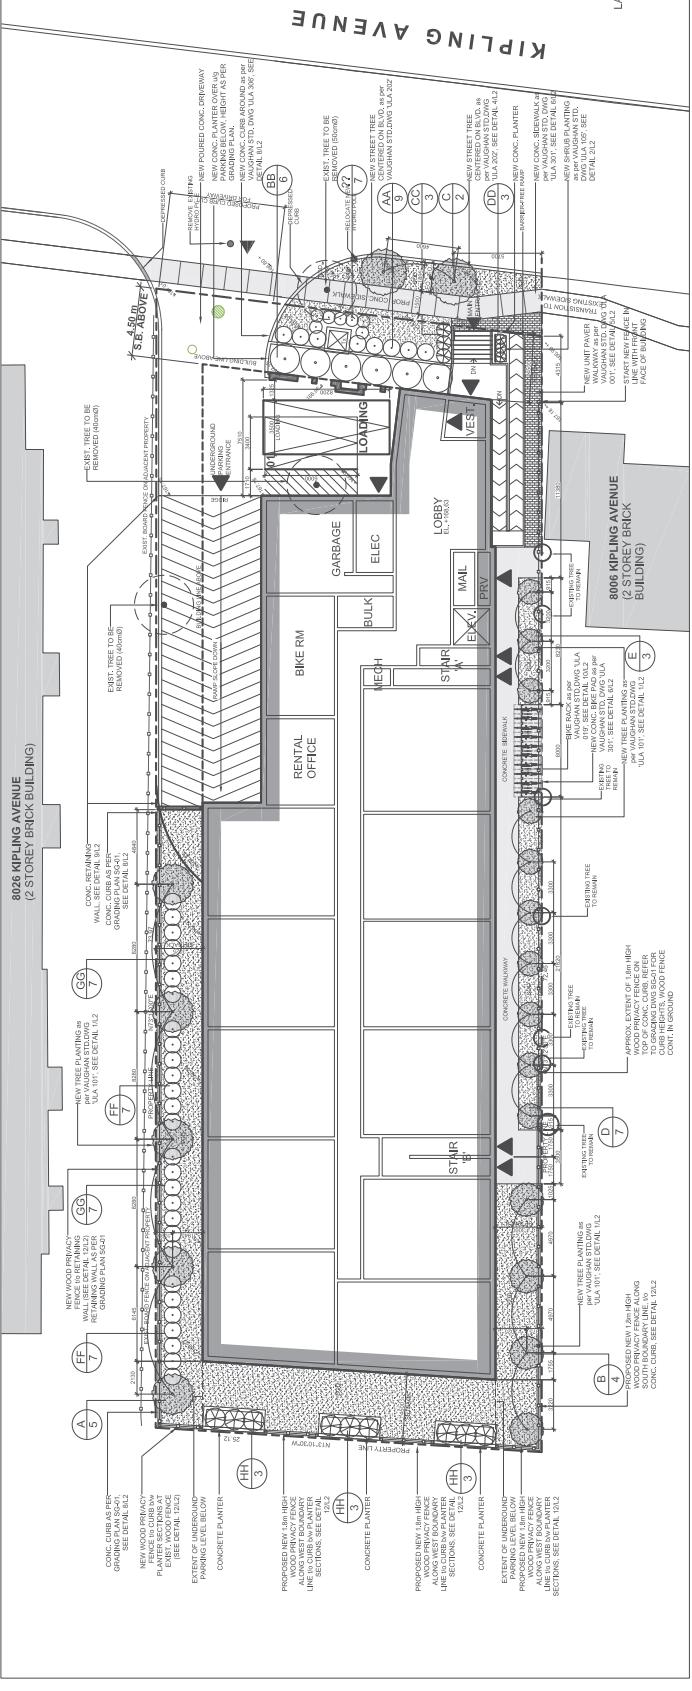

LANDSCAPE PLAN
(1) SCALE 1:150

GENERAL PLANTING NOTES:

1. TREES SHALL BE PLANTED WITHIN ONE YEAR OF THE ISSUANCE OF THE TREE REMOVAL PERMIT.
2. TREES SHALL BE PROPOSED IN ACCORDANCE WITH MUNICIPAL STANDARDS.
3. ALL LANDSCAPING SHALL BE INSTALLED IN ACCORDANCE WITH THE CITY OF VAUGHAN STANDARDS, AND IN ACCORDANCE WITH THE EXECUTED SITE PLAN AGREEMENT.
4. SPECIES SHALL MEET THE HIGHEST HORTICULTURAL STANDARDS OF THE CANADIAN NURSERY TRADES ASSOCIATION WITH RESPECT TO GRAZING AND QUALITY AND SHALL BE IN STRICT ACCORDANCE WITH THE APPROVED PLANT LIST AND SPECIFICATIONS.
5. ALL PLANTS SHALL BE TRUE TO NAME, SIZE, CONDITION AND QUANTITY AS PER PLAN AND PLANT LIST SPECIFICATIONS.
6. ALL PLANTS SHALL BE HEALTHY, VIGOROUS PLANTS, FREE FROM DEFECTS, DECAY, DISFIGURING ROOTS, SUN-SCALD INJURIES, BARK ABRASIONS, PLANT DISEASES AND PESTS AND ALL FORMS OF INFESTATIONS OR OBJECTIONABLE DEFORMITIES.
7. ALL PITS, TRENCHES AND/OR PLANTING BEDS TO HAVE A TOPSOIL LAYER GREATER THAN 60cm WITH AN ORGANIC MATTER CONTENT OF 10% TO 15% BY DRY WEIGHT AND A pH OF 5.0 TO 8.0.
8. THE SUBSOIL SHALL HAVE A TOTAL UNCOMPACTED SOIL DEPTH OF 90cm.
9. THERE SHALL BE A MINIMUM SOIL VOLUME OF 30 CUBIC METRES PER TREE.

(2) MASTER PLANT LIST
(1) SCALE 1:150

KEY	QTY.	BOTANICAL NAME	COMMON NAME	SIZE / SPACING	WIRE BASKET
A	5	ACER PLATANOIDES 'CRIMSON SENTRY'	CRIMSON SENTRY MAPLE	70mm caliper	WIRE BASKET
B	4	GYMNOCLADUS DIOICUS	YELLOW BUCKEYE	60mm caliper	WIRE BASKET
C	2	OSTRIA VIRGINIANA	KENTUCKY COFFEE TREE	70mm caliper	WIRE BASKET
D	7	PYRUS CALLERYANA 'REDSPIRE'	REDSPIRE ORNAMENTAL PEAR	70mm caliper	WIRE BASKET
E	3	DEUTZIA GRACILIS	SLENDER DEUTZIA	80cm height, plant at 100cm O.C.	CONTAINER
AA	9	BUXUS SEMPERVIRENS 'VERIEGATA'	VERIGATED BOXWOOD	100cm spread, plant at 200cm O.C.	CONTAINER
BB	6	JUNIPERUS SCOPULORUM 'BLUE ARROW'	BLUE ARROW JUNIPER	80cm height, plant at 100cm O.C.	CONTAINER
CC	3	TAXUS MEDIA 'NICHII'	HICKS YEW	80cm height, plant at 60cm O.C.	CONTAINER
DD	2	JUNIPERUS CHINENSIS 'RAMLOSA'	RAMLOSA JUNIPER	80cm height, plant at 80cm O.C.	CONTAINER
EE	4	VIBURNUM CARLESII	WITHEROD	60cm height, plant at 100cm O.C.	CONTAINER
FF	14	JUNIPERUS SABINA 'TAMARISCIFOLIA'	TAMARISK JUNIPER	60cm spread, plant at 90cm O.C.	CONTAINER
GG	9	PINUS SYLVESTRIS 'FASTIGATA' 'GLAUCA'	COLUMNAR SCOTS PINE		

LANDSCAPE PLAN & DETAILS

SCALE AS SHOWN

8010 Apartments

Landscaping Architect	John A. Russo, OALA, CSLA
Site Plan Preparer	By Fred Almon, Professional Land Surveyor
Address	8010 Kipling Avenue
Municipality	Richmond Hill, ON
Lot No.	L40 839
Phone No.	(416) 435-2641
Date	Sept 12, 2010
Revised Date	Sept 12, 2010
Approved Date	Sept 12, 2010
Approved By	John A. Russo, OALA, CSLA
Permit No.	100-10000000000000000000000000000000
Date Issued	Sept 12, 2010
Permit Expired	Sept 12, 2011

100-10000000000000000000000000000000

2010-09-12

2011-09-12

2010-09-12

2011-09-12

2010-09-12

2011-09-12

2010-09-12


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8010


KIPLING AVENUE
WOODBRIDGE, ON




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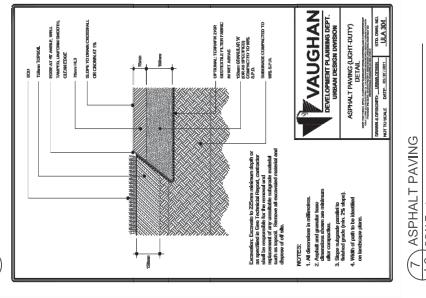
(4) TYP. BOULEVARD TREE PLANTING
12 SCALE: mts

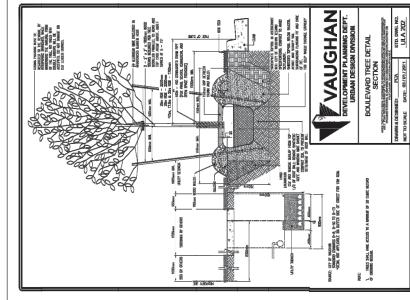


(9) CONCRETE RETAINING WALL
12 SCALE: mts

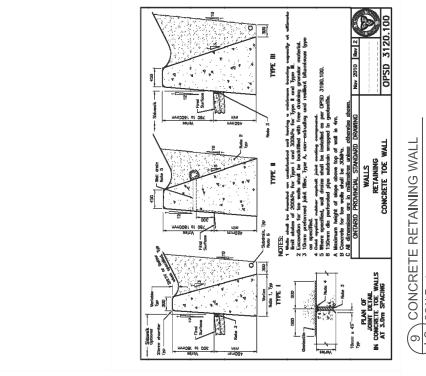


(3) TYP. PERENNIAL PLANTING
12 SCALE: mts

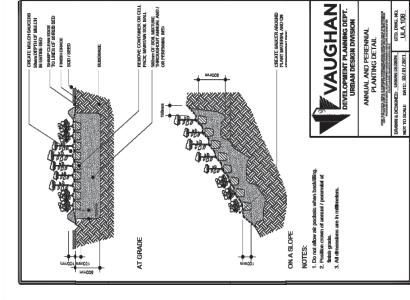


(7) ASPHALT PAVING
12 SCALE: mts

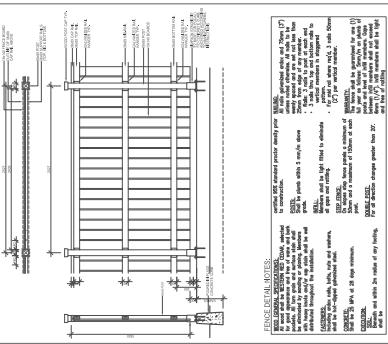


(12) WOOD PRIVACY FENCE - ON CURB
12 SCALE: mts

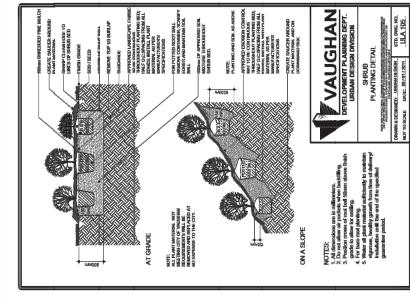


(1) TYP. DECIDUOUS TREE PLANTING
12 SCALE: mts

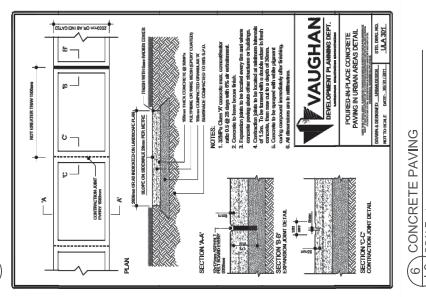


(6) CONCRETE PAVING
12 SCALE: mts

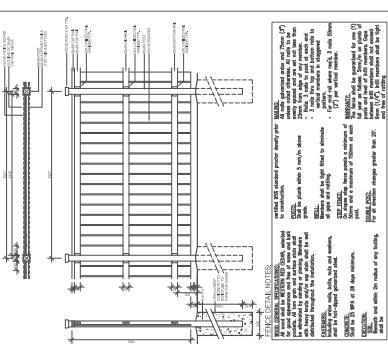

(11) WOOD PRIVACY FENCE - IN GROUND
12 SCALE: mts

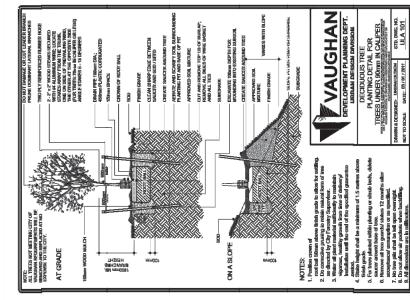

(5) UNIT PAVING
12 SCALE: mts

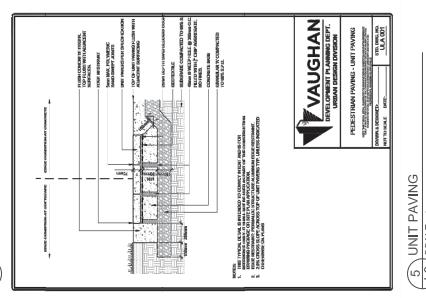

(10) BIKE RACK
12 SCALE: mts

REF ID: 8010_KIPLING_AVENUE_001	DATE: 06/22/2018	REV: A
REF ID: 8010_KIPLING_AVENUE_002	DATE: 06/22/2018	REV: A
REF ID: 8010_KIPLING_AVENUE_003	DATE: 06/22/2018	REV: A
REF ID: 8010_KIPLING_AVENUE_004	DATE: 06/22/2018	REV: A
REF ID: 8010_KIPLING_AVENUE_005	DATE: 06/22/2018	REV: A

PARKED NO. 12
DATE: March 1, 2018
REV: A

PARKED NO. 12
DATE: March 1, 2018
REV: A