ITEM: 6.2

# COMMITTEE OF ADJUSTMENT REPORT SUMMARY MINOR VARIANCE APPLICATION FILE NUMBER A025/23 153 POLO CRESCENT, WOODBRIDGE

# THIS REPORT CONTAINS COMMENTS FROM THE FOLLOWING DEPARTMENTS & AGENCIES:

\*Please see **Schedule B** of this report for a copy of Development Planning and Agency correspondence.

Additional comments from departments and agencies may be received after the publication of the Staff Report. These comments will be processed as an addendum and posted on the City's Website.

DEPARTMENTS	Circulated	Comments Received	Conditions	Nature of Comments
Committee of Adjustment				General Comments
Building Standards (Zoning Review)	$\boxtimes$	$\boxtimes$		General Comments
Building Inspection (Septic)	$\boxtimes$			No Comments Received to Date
Development Planning	$\boxtimes$		$\boxtimes$	Recommend Approval w/Conditions
Development Engineering			$\boxtimes$	Recommend Approval w/Conditions
Parks, Forestry and Horticulture Operations				General Comments
By-law & Compliance, Licensing & Permits				No Comments Received to Date
Development Finance	$\boxtimes$			General Comments
Real Estate				
Fire Department	$\boxtimes$			No Comments Received to Date
AGENCIES	Circulated	Comments Received	Conditions	Nature of Comments
TRCA	$\boxtimes$			No Comments Received to Date
Ministry of Transportation (MTO)				
Region of York	$\boxtimes$	$\boxtimes$		General Comments
Alectra	$\boxtimes$	$\boxtimes$		General Comments
Bell Canada	$\boxtimes$			No Comments Received to Date
YRDSB				
YCDSB				
CN Rail				
CP Rail				
TransCanada Pipeline	$\boxtimes$			No Comments Received to Date
Metrolinx				
	t			
Propane Operator				

#### **PUBLIC & APPLICANT CORRESPONDENCE**

\*Please see **Schedule C** of this report for a copy of the public & applicant correspondence listed below.

The deadline to submit public comments is noon on the last business day prior to the scheduled hearing date.

Comments and written public submissions received after the publication of this Staff Report will be processed as an addendum and posted on the City's Website.

All personal information collected because of this public meeting (including both written and oral submissions) is collected under the authority of the Municipal Act, the Municipal Freedom of Information and Protection of Privacy Act (MFIPPA), the Planning Act and all other relevant legislation, and will be used to assist in deciding on this matter. All personal information (as defined by MFIPPA), including (but not limited to) names, addresses, opinions and comments collected will become property of the City of Vaughan, will be made available for public disclosure (including being posted on the internet) and will be used to assist the Committee of Adjustment and staff to process this application.

Correspondence Type	Name	Address	Date Received (mm/dd/yyyy)	Summary
None				

PREVIOUS COA DECISIONS ON THE SUBJECT LAND		
*Please see <b>Schedule D</b> for a copy of the Decisions listed below		
File Number Date of Decision Decision Outcome		

PREVIOUS COA DECISIONS ON THE SUBJECT LAND			
	*Please see Schedule D for	a copy of the Decisions listed below	
	MM/DD/YYYY		
None			

ADJOURNMENT HISTORY	
* Previous hearing dates where this application was adjourned by the Committee and public notice issued.	
None	



## COMMITTEE OF ADJUSTMENT REPORT MINOR VARIANCE APPLICATION A025/23

#### 153 POLO CRESCENT, WOODBRIDGE

ITEM NUMBER: 6.2	CITY WARD #: 3
APPLICANT:	Angela Coluccio and Fabio Oliveira
AGENT:	Robert Pasutto
PROPERTY:	153 Polo Crescent, Woodbridge
ZONING DESIGNATION:	See Below
VAUGHAN OFFICIAL PLAN	Vaughan Official Plan 2010 ('VOP 2010'): "Low-Rise Residential"
(2010) DESIGNATION:	
RELATED DEVELOPMENT	None
APPLICATIONS:	
PURPOSE OF APPLICATION:	Relief from the Zoning By-law is being requested to permit the
	construction of a proposed pavilion, an existing shed and reduced landscaping requirements in the rear yard.

The following variances have been requested from the City's Zoning By-law:

The subject lands are zoned R1A(EN) – First Density Residential Zone (Established Neighbourhood) under Zoning By-law 001-2021, as amended.

#	Zoning By-law 001-2021	Variance requested
1	A minimum side yard setback of 2.4m is required to the proposed residential accessory structure. [4.1.2.b]	To permit a minimum side yard setback of 1.0m to the proposed residential accessory structure.
2	A minimum interior side yard setback of 1.5m is required to the existing residential structure (storage shed).  [Table 7-3]	To permit a minimum side yard setback of 0.39m is required to the existing residential structure (storage shed).
3	A maximum height of 3.0m is permitted for the proposed residential accessory structure. [4.1.4.1]	To permit a maximum residential accessory structure height of 3.20m.
4	In the R1A Zone, any portion of a yard in excess of 135 m2 shall be comprised of a minimum of 60% soft landscape. [4.19.1.1].	To permit a minimum of 41.53% 54.3% of the area of the rear yard in excess of 135 sq. m. to be comprised of soft landscaping. *Landscaping % increased, variance confirmed by applicant using Zoning Review Waiver

#### **HEARING INFORMATION**

DATE OF MEETING: Thursday, June 1, 2023

**TIME:** 6:00 p.m.

**MEETING LOCATION:** Vaughan City Hall, Woodbridge Room (2<sup>nd</sup> Floor), 2141 Major Mackenzie Drive

LIVE STREAM LINK: Vaughan.ca/LiveCouncil

#### **PUBLIC PARTICIPATION**

If you would like to speak to the Committee of Adjustment at the meeting, either remotely or in person, please complete the Request to Speak Form and submit to cofa@vaughan.ca

If you would like to submit written comments, please quote file number above and submit by mail or email to:

Email: cofa@vaughan.ca

**Mail:** City of Vaughan, Office of the City Clerk, Committee of Adjustment, 2141 Major Mackenzie Drive, Vaughan, ON, L6A 1T1

#### **HEARING INFORMATION**

To speak electronically, pre-registration is required by completing the Request to Speak Form on-line and submitting it to cofa@vaughan.ca no later than NOON on the last business day before the meeting.

THE DEADLINE TO REGISTER TO SPEAK ELECTRONICALLY OR SUBMIT WRITTEN COMMENTS ON THE ABOVE NOTED FILE(S) IS <u>NOON</u> ON THE LAST BUSINESS DAY BEFORE THE MEETING.

#### INTRODUCTION

Staff and Agencies act as advisory bodies to the Committee of Adjustment. The comments contained in this report are presented as recommendations to the Committee.

Section 45(1) of the Planning Act sets the criteria for authorizing minor variances to the City of Vaughan's Zoning By-law. Accordingly, review of the application may consider the following:

That the general intent and purpose of the by-law will be maintained.

That the general intent and purpose of the official plan will be maintained.

That the requested variance(s) is/are acceptable for the appropriate development of the subject lands.

That the requested variance(s) is/are minor in nature.

Public written and oral submissions relating to this application are taken into consideration by the Committee of Adjustment as part of its deliberations and final decision on this matter.

COMMITTEE OF ADJUSTMENT COMMENTS		
Date Public Notice Mailed:	May 18, 2023	
Date Applicant Confirmed Posting of Sign:	May 15, 2023	
Applicant Justification for Variances: *As provided by Applicant in Application Form	The pavilion that I would like to build is allowed under the by-law. I would like can have some shade in the backyard enjoy. Underneath the pavilion we will room for a bathroom for our guests an area to serve our guests.	to build a pavilion so I for my family to be adding a closed
Adjournment Requests (from staff):  *Adjournment requests provided to applicant prior to issuance of public notice	On May 12, 2023, Development Plann following:	ing provided the
	Development Planning has now completed Minor Variance application. Our Urban also provided the attached comments addressed. Development Planning is resupport he variance for the proposed regard soft landscaping. We believe that 41.5% soft landscaping is not consider Please explore the possibility of retaining landscaping throughout the yard. Som retaining more soft landscaping west of increasing the softscape areas adjaced. We also support the recommendation plantings between the cabana and the	Design division has that must be not in a position to reduction to the rear the proposal for red minor in this case. Ing more soft e options include of the pool and not to the dwelling.
	assist in mitigating the impact the caba neighbouring property.	_
	On May 23, 2023 the applicant provide submission increasing the soft landsca 54.3% to address Planning recommen	aping from 41.53% to
Was a Zoning Review Waiver (ZRW) Form	n submitted by Applicant:	Yes
*ZRW Form may be used by applicant in instances where a revised submission is made, and zoning staff do not have an opportunity to review and confirm variances prior to the issuance of public notice.		
*A revised submission may be required to addre part of the application review process.	ss staff / agency comments received as	
*Where a zoning review has not been completed provided to the applicant to adjourn the proposal		
Adjournment Fees:		

#### COMMITTEE OF ADJUSTMENT COMMENTS

In accordance with Procedural By-law 069-2019, an Adjournment Fee is applicable to reschedule an application after the issuance of public notice where a request for adjournment has been provided to the applicant prior to the issuance of public notice.

An Adjournment Fee can only be waived in instances where adjournment of an application is requested by the Committee or staff after the issuance of public notice.

**Committee of Adjustment Comments:** 

Should the application require adjournment from the June 1 hearing, an adjournment fee in the amount of \$591.00 is required to reschedule the application.

Committee of Adjustment Recommended None

**Conditions of Approval:** 

#### **BUILDING STANDARDS (ZONING) COMMENTS**

\*\*See Schedule B for Building Standards (Zoning) Comments

**Building Standards Recommended Conditions of Approval:** 

None

# **DEVELOPMENT PLANNING COMMENTS**

\*\*See Schedule B for Development Planning Comments.

**Development Planning Recommended Conditions of Approval:** 

That the final Landscape Plan be approved to the satisfaction of the Development Planning Department.

#### DEVELOPMENT ENGINEERING COMMENTS

Link to Grading Permit Link to Pool Permit Link to Curb Curt Permit Link Culvert Installation

As the proposed structures in the subject property is more than 10 m<sup>2</sup> (in-ground pool is 50.16 m<sup>2</sup> and pavilion is 32.52 m²), the Owner / Applicant needs to obtain a Lot Grading Permit from Development Inspection and Lot Grading Division of the City's Development Engineering Department. Please note any in-ground structure over 10 m² requires a Grading Permit. Please contact the Development Engineering Reviewer after receiving the Grading Permit to clear the condition. (Condition attached)

The Owner / Applicant shall apply for a Pool Grading Permit with the Development Engineering (DE) Department. Please visit the grading permits page at City of Vaughan website to learn how to apply for the Pool Permit. If you have any question about Pool Grading Permit, please contact the Development Engineering Department through email at DEPermits@vaughan.ca.

The proposed work by the Owner / Applicant is increasing the lot coverage on the subject property. The added hardscape may have impacts on the City's Storm Water management system. Development Engineering strongly encourages the Owner / Applicant introduce Low-Impact Development (LID) measures (e.g., bioswales, permeable pavers, rain gardens, rain barrels etc.) to reduce the impacts to the stormwater system. Should further information be required, please contact the Development Engineering COA reviewer.

The Development Engineering Department does not object to the Minor Variance application A025/23, subject to the following condition(s):

**Development Engineering Recommended Conditions of** Approval:

The Owner / Applicant shall submit the final Lot Grading and/or Servicing Plan to the Development Inspection and Lot Grading Division of the City's Development Engineering Department for final Lot Grading and/or Servicing Permit prior to any work being undertaken on the property. Please visit the Grading Permit page at City of Vaughan website to learn how to apply for the Grading Permit. If you have any questions about Grading Permit, please contact the Development Engineering Department by email at DEPermits@vaughan.ca.

#### PARKS, FORESTRY & HORTICULTURE (PFH) COMMENTS

Homeowner has acknowledged they will install tree protection for the front city tree at a site meeting May 5th 2023 10:20 a.m.

**PFH Recommended Conditions of** Approval:

None

#### **DEVELOPMENT FINANCE COMMENTS**

No comment no concerns

DEVELOPMENT FINANCE COMMENTS	
Development Finance Recommended Conditions of Approval:	None

BY-LAW AND COMPLIANCE, LICI	ENSING AND PERMIT SERVICES COMMENTS	
No comments received to date.		
BCLPS Recommended Conditions of Approval:	None	

BUILDING INSPECTION (SEPTIC) COMMENTS	
No comments received to date.	
Building Inspection Recommended Conditions of Approval:	None

FIRE DEPARTMENT COMMENTS	
No comments received to date.	
Fire Department Recommended Conditions of Approval:	None

	SCHEDULES TO STAFF REPORT  *See Schedule for list of correspondence
Schedule A	Drawings & Plans Submitted with the Application
Schedule B	Staff & Agency Comments
Schedule C (if required)	Correspondence (Received from Public & Applicant)
Schedule D (if required)	Previous COA Decisions on the Subject Land

Should the Committee find it appropriate to approve this application in accordance with request and the sketch submitted with the application, as required by Ontario Regulation 200/96, the following conditions have been recommended:

#### SUMMARY OF RECOMMENDED CONDITIONS OF APPROVAL All conditions of approval, unless otherwise stated, are considered to be incorporated into the approval "if required". If a condition is no longer required after an approval is final and binding, the condition may be waived by the respective department or agency requesting conditional approval. A condition cannot be waived without written consent from the respective department or agency. **DEPARTMENT / AGENCY CONDITION(S) DESCRIPTION** # **Development Planning** That the final Landscape Plan be approved to Joshua.cipolletta@vaughan.ca the satisfaction of the Development Planning Department. 2 **Development Engineering** The Owner / Applicant shall submit the final Rex.bondad@vaughan.ca Lot Grading and/or Servicing Plan to the Development Inspection and Lot Grading Division of the City's Development Engineering Department for final Lot Grading and/or Servicing Permit prior to any work being undertaken on the property. Please visit the Grading Permit page at City of Vaughan website to learn how to apply for the Grading Permit. If you have any questions about Grading Permit, please contact the **Development Engineering Department by** email at DEPermits@vaughan.ca.

#### **IMPORTANT INFORMATION - PLEASE READ**

**CONDITIONS:** It is the responsibility of the owner/applicant and/or authorized agent to obtain and provide a clearance letter from respective department and/or agency (see condition chart above for contact). This letter must be provided to the Secretary-Treasurer to be finalized. All conditions must be cleared prior to the issuance of a Building Permit.

#### **IMPORTANT INFORMATION - PLEASE READ**

**APPROVALS:** Making any changes to your proposal after a decision has been made may impact the validity of the Committee's decision.

An approval obtained from the Committee of Adjustment, where applicable, is tied to the building envelope shown on the plans and drawings submitted with the application and subject to the variance approval.

A building envelope is defined by the setbacks of the buildings and/or structures shown on the plans and drawings submitted with the application, as required by Ontario Regulation 200/96. Future development outside of an approved building envelope, where a minor variance was obtained, must comply with the provisions of the City's Zoning By-law.

Elevation drawings are provided to reflect the style of roof (i.e. flat, mansard, gable etc.) to which a building height variance has been applied. Where a height variance is approved, building height is applied to the style of roof (as defined in the City's Zoning By-law) shown on the elevation plans submitted with the application.

Architectural design features that are not regulated by the City's Zoning By-law are not to be considered part of an approval unless specified in the Committee's decision.

**DEVELOPMENT CHARGES:** That the payment of the Regional Development Charge, if required, is payable to the City of Vaughan before issuance of a building permit in accordance with the Development Charges Act and the Regional Development Charges By-law in effect at the time of payment.

That the payment of the City Development Charge, if required, is payable to the City of Vaughan before issuance of a building permit in accordance with the Development Charges Act and the City's Development Charges By-law in effect at the time of payment.

That the payment of the Education Development Charge if required, is payable to the City of Vaughan before issuance of a building permit in accordance with the Development Charges Act and the Boards of Education By-laws in effect at the time of payment

That the payment of Special Area Development charge, if required, is payable to the City of Vaughan before issuance of a building permit in accordance with the Development Charges Act and The City's Development Charge By-law in effect at the time of Building permit issuance to the satisfaction of the Reserves/Capital Department.

**NOTICE OF DECISION:** If you wish to be notified of the decision in respect to this application or a related Ontario Land Tribunal (OLT) hearing you must complete a Request for Decision form and submit to the Secretary Treasurer (ask staff for details). In the absence of a written request to be notified of the Committee's decision you will **not** receive notice.

# **SCHEDULE A: DRAWINGS & PLANS**

153 Polo Crescent, Woodbridge

# **NOTIFICATION MAP - A025/23**

Disclaimer:




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Created By: Infrastructure Delivery NAD 83 UTM Zone Department May 8, 2023 10:40 AM




By Christine Vigneault at 1:33 pm, May 24, 2023




153 POLO CRESCENT WOODBRIDGE ON LOT # 21

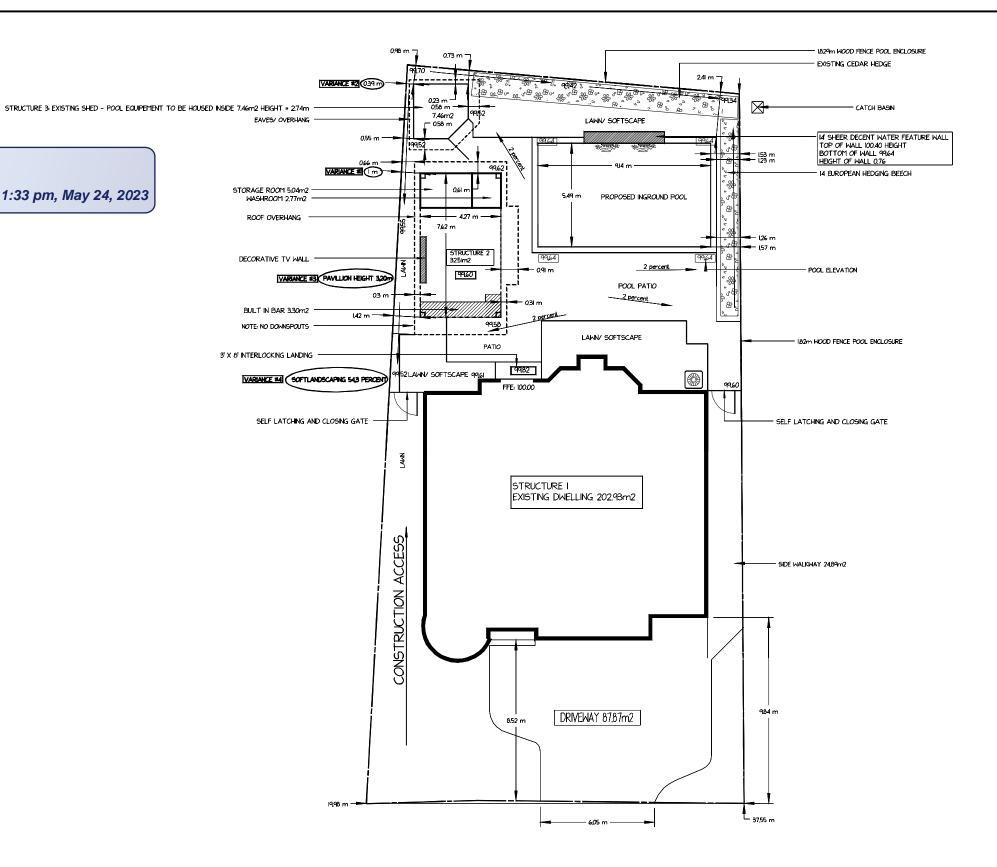NOTES:
FULL LOT 720,12m2
STRUCTURE 1: 202,93m2
STRUCTURE 2: 32,51m2
STRUCTURE 3: 7,46m2
REAR LOT: 289,82112 = 100 PERCENT
MINUS PERMIABLE ALLOWANCE 135m2 = 154,82m
REAR SOFT = 84,08 m2 = 54,3 PERCENT
REAR HARD = 70.73 m2 = 45.7 PERCENT
PROPOSED POOL = 50,16m2

NOTES:
-NO GRADE CHANGES OR
HARDSCAPING WITHIN 0.6m
OF THE PROPERTY LINE WILL
BE MADE
- ALL STRUCTURES INCLUDE EVES

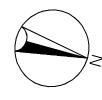

SCALE: 1:200 DATE: 2023-05-23 DESIGN: POOL PERMIT PLAN

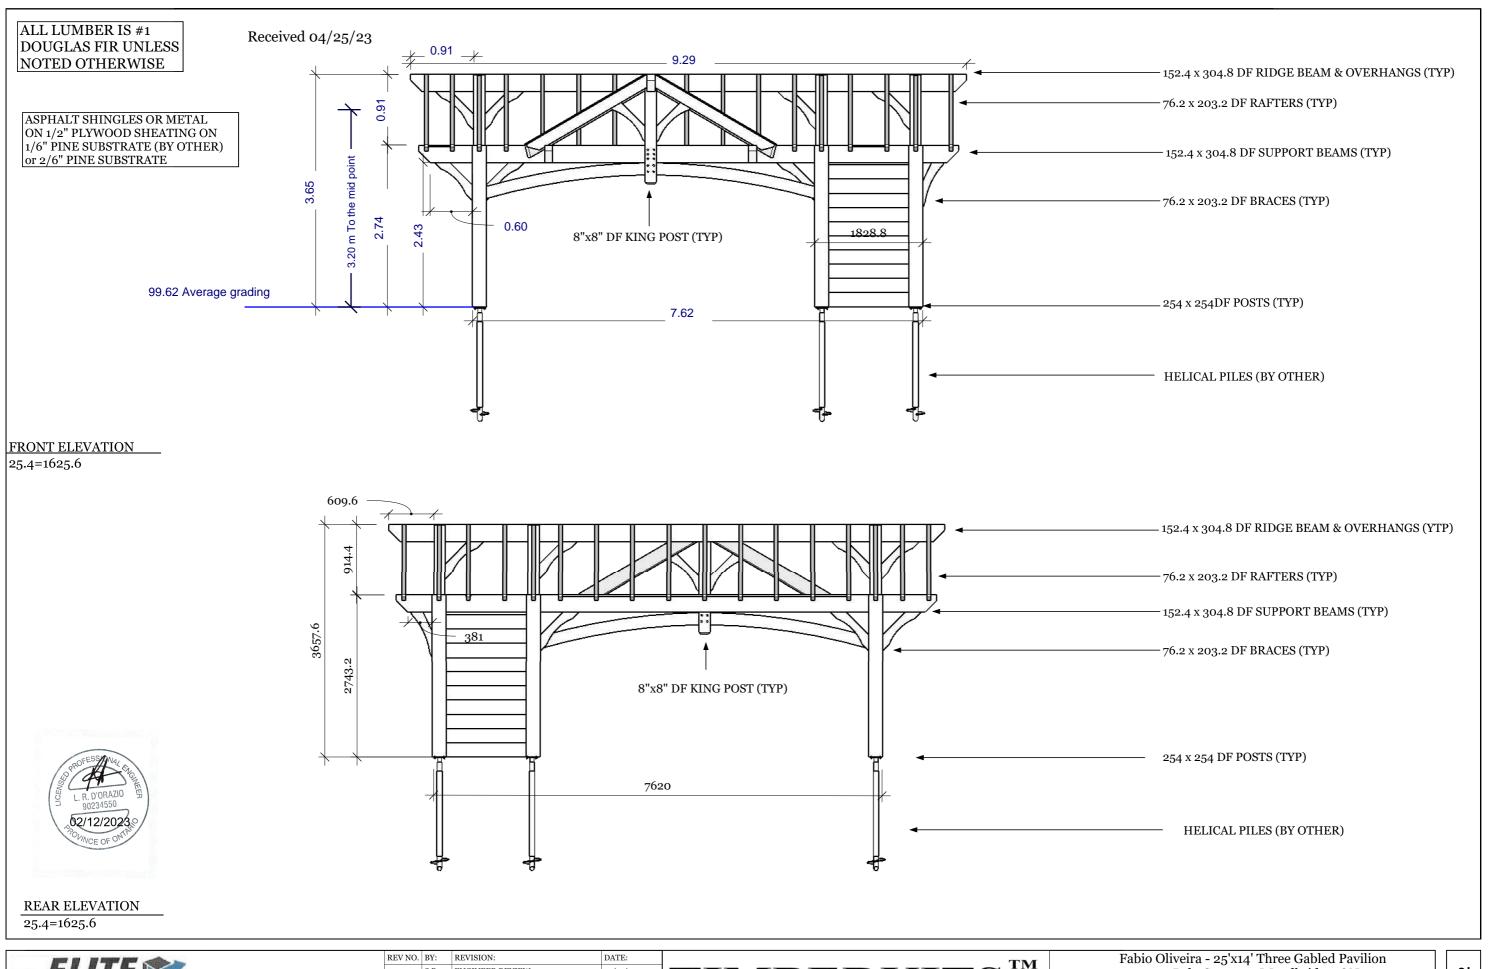

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E	NGINEERING GROUP Inc.
	58 ROSSITER ROAD
1	NGERSOLL, ONTARIO - N5C 4E1
	519.280.5384
	www.eliteengineeringgroup.com


REV NO.	BY:	REVISION:	DATE:
1	S.B	ENGINEER REVIEW	01/14/23
2	S.B	ENGINEER REVIEW	02/03/23

TIMBERKITS TM
by Country Log Homes


Fabio Oliveira - 25'x14' Thre 153 Polo Crescent, Woo					
	DRAWING NAME:	E	levations		
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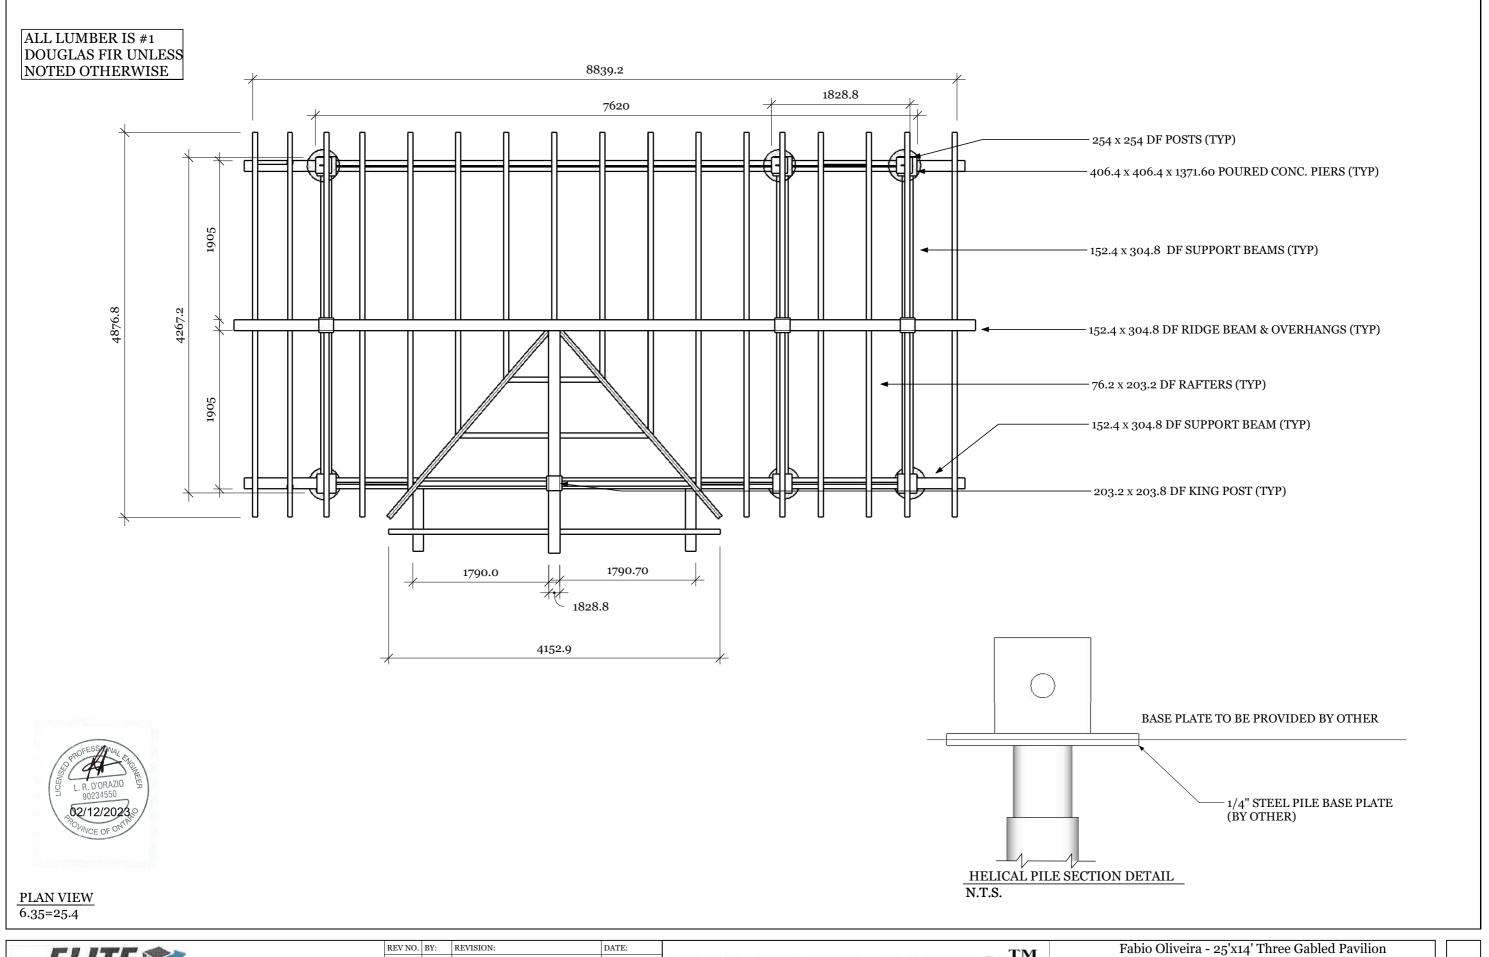


By Christine Vigneault at 9:29 am, May 17, 2023

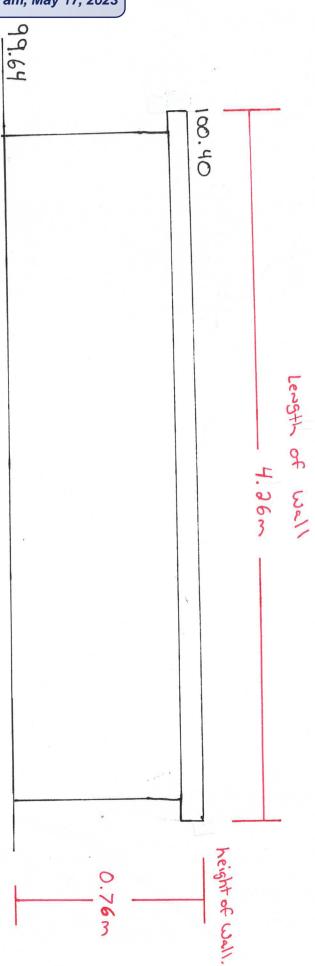

Waterfeator wall



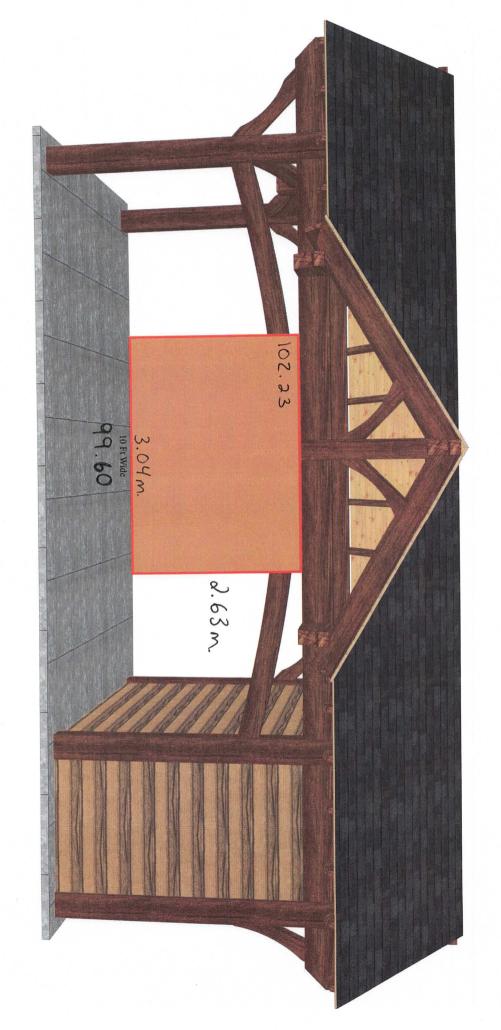


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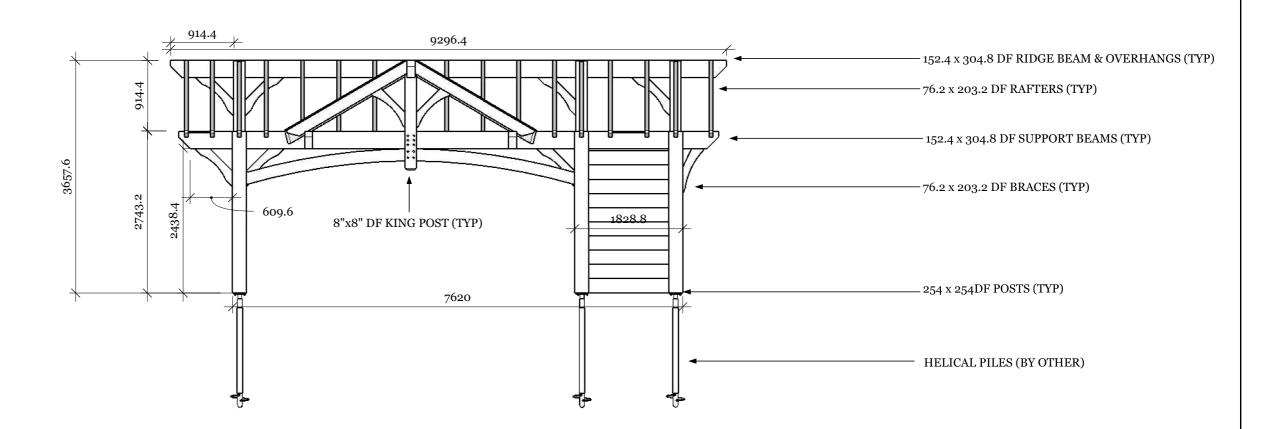
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1	S.B	ENGINEER REVIEW	01/14/23
2	S.B	ENGINEER REVIEW	02/03/23

TIMBERKITS "
by Country Log Homes

Fabio Oliveira - 25'x14' Three Gabled Pavilion 153 Polo Crescent, Woodbridge, ON					
	DRAWING NAME:	Plan & Pi	er Footing D	etails	
	DRAWN BY:	CHECKED BY:	SCALE:	DATE:	PROJECT NO.:
	S.B	S.K	As Shown	01/14/23	

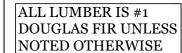


ASPHALT SHINGLES OR METAL ON 1/2" PLYWOOD SHEATING ON 1/6" PINE SUBSTRATE (BY OTHER) or 2/6" PINE SUBSTRATE



#### FRONT ELEVATION

25.4=1625.6

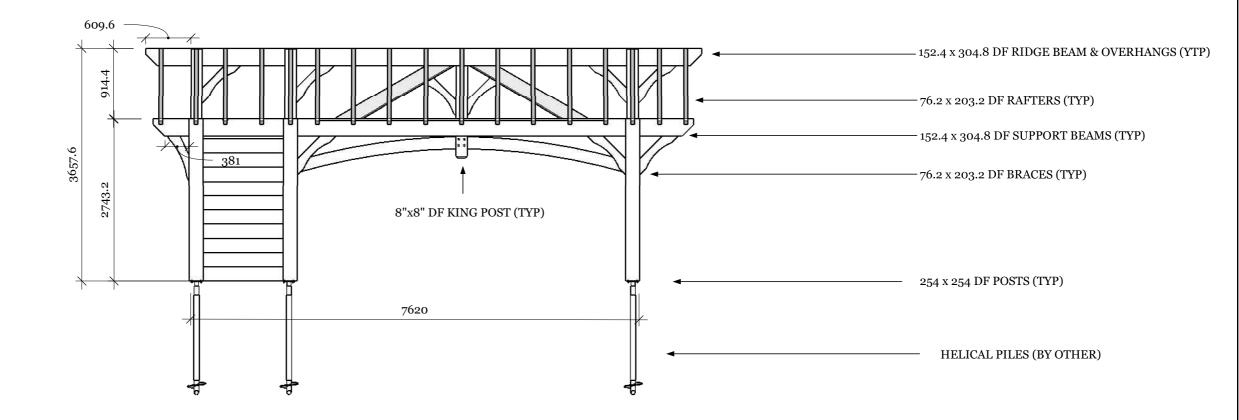



REAR ELEVATION

25.4=1625.6


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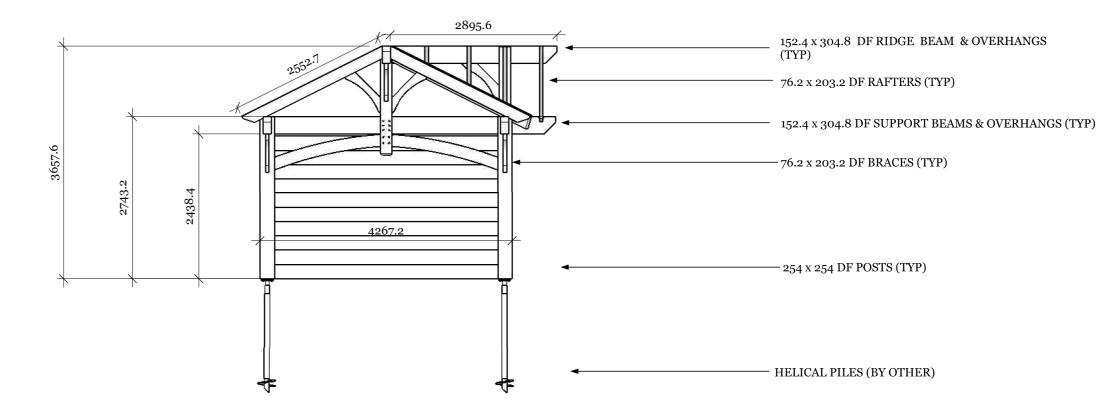
TIMBERKITS TM
by Country Log Homes

I	Fabio Oliveira - 25'x14' Three Gabled Pavilion 153 Polo Crescent, Woodbridge, ON					
	DRAWING NAME: Elevations					
	DRAWN BY:	CHECKED BY:	SCALE:	DATE:	PROJECT NO.:	
	S.B	S.K	As Shown	01/14/23		
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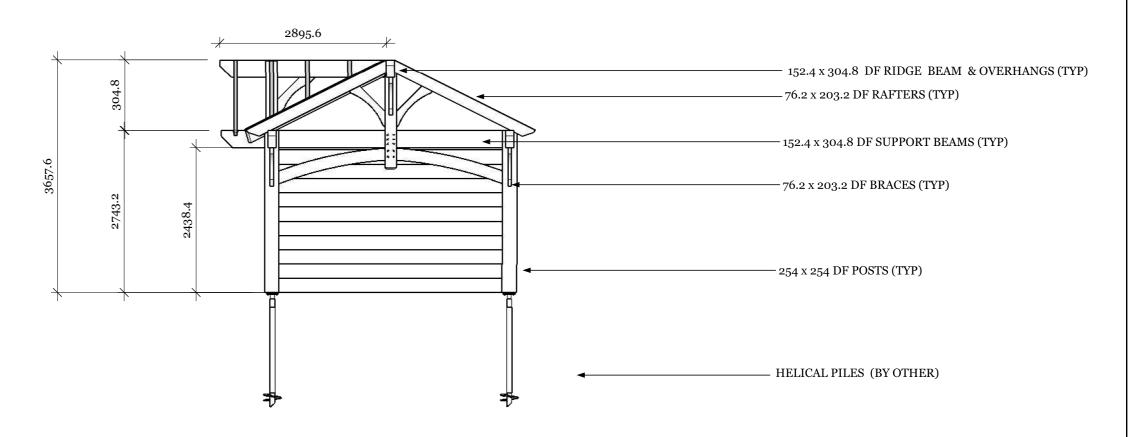


ASPHALT SHINGLES OR METAL ON 1/2" PLYWOOD SHEATING ON 1/6" PINE SUBSTRATE (BY OTHER) or 2/6" PINE SUBSTRATE



#### SIDE ELEVATION

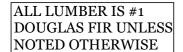25.4=1625.6





SIDE ELEVATION

25.5=1625.6


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	19.280.5384
www.elitee	engineeringgroup.com

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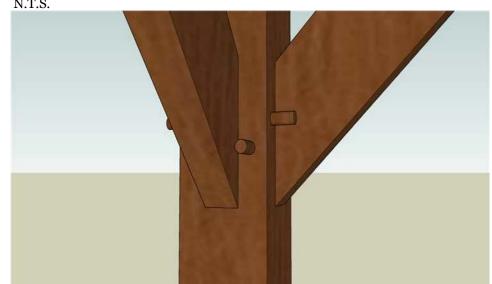
$\frac{1}{2}$	TIMBERKITS
	by Country Log Homes

RAWING NAME: Elevations			
CHECKED BY:	SCALE:	DATE:	PROJECT NO.:
S.K	As Shown	01/14/23	
	153 Polo Cr	153 Polo Crescent, Wood  Elevations  CHECKED BY: SCALE:	CHECKED BY: SCALE: DATE:




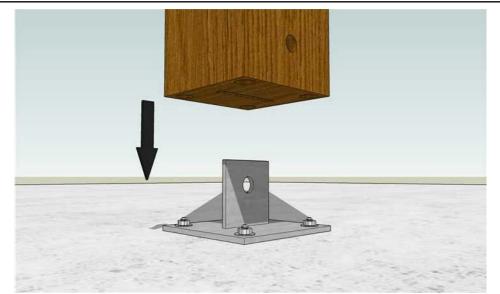


POST/ANCHOR PLATE CONNECTION N.T.S.



MORTICE BRACE/POST CONNECTION N.T.S. (Straight tenon connection secured with 1" x 11 1/2" oak dowel)

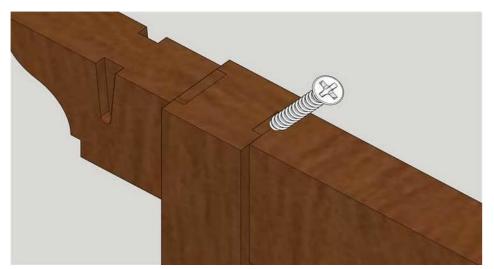

KING POST/RIDGE BEAM CONNECTION (DOVETAIL CONNECTION)
N.T.S. (6" Timber screws as additional reinforcement)

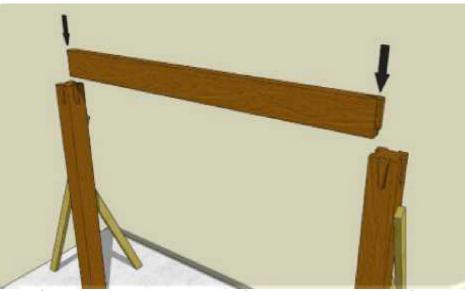


POST/SUPPORT BEAM CONNECTION (DOVE TAIL CONNECTION) N.T.S. (6" Timber screws as additional reinforcement)



KING POST/SUPPORT BEAM CONNECTION N.T.S.




N.T.S.

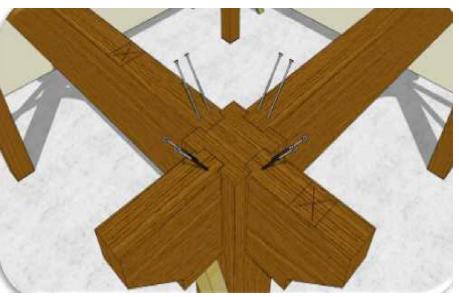

POST/OVERHANG CONNECTION (DOVETAIL CONNECTION)
N.T.S. (6" Timber screws as additional reinforcement)



KING POST/RIDGE BEAM CONNECTION (DOVETAIL CONNECTION) N.T.S

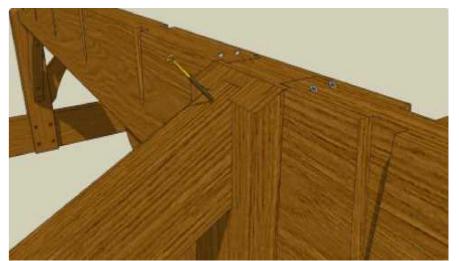

QUEEN RAFTER/SUPPORT BEAM CONNECTION (DOVETAIL CONNECTION) N.T.S. (6" timber screw used for additional reinforcement)



REV NO.	BY:	REVISION:	DATE:
1	S.B	ENGINEER REVIEW	01/14/23

TIMBERKITS TM
by Country Log Homes

Fabio Oliveira - 25'x14' Three Gabled Pavilion 153 Polo Crescent, Woodbridge, ON				ilion	
General Connection Details					
DRAWN BY:	CHECKED BY:	SCALE:	DATE:	PROJECT NO.:	
S.B	S.K	As Shown	01/14/23		






QUEEN RAFTER/OVERHANG CONNECTION N.T.S. (11" timber screw threw queen rafter to post overhang)




QUEEN BRACES/QUEEN RAFTER CONNECTION N.T.S. (11" timber screw threw queen brace to king post)

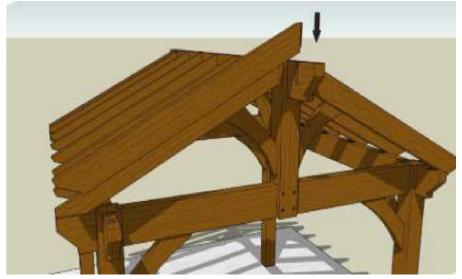

RAFTERS/RIDGE BEAM CONNECTION (DOVETAIL CONNECTION)
N.T.S.




SUPPORT BEAM/RAFTER CONNECTION
N.T.S. (11" timber screw for additional reinforcement)

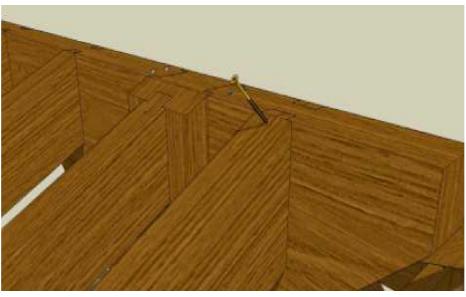


RIDGE BEAM OVERHANG/RAFTER CONNECTION N.T.S. (6" timber screw for additional reinforcement)



T&G ROOFING MATERIAL (1x6 or 2x6) 285.75 MORTISE BRACE DETAIL 19.05=25.4

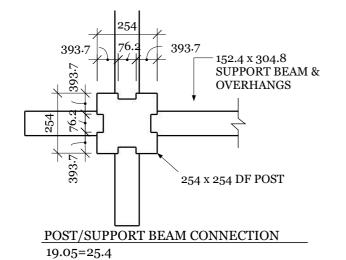

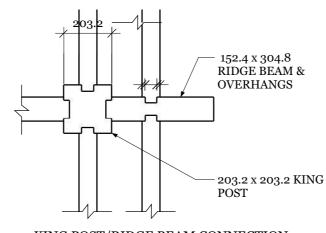

KING POST/RIDGE BEAM CONNECTION 19.05=25.4




REV NO.	BY:	REVISION:	DATE:
1	S.B	ENGINEER REVIEW	01/14/23

TIMBERKITS
by Country Log Homes

N.T.S.

[	Fabio Oliveira - 25'x14' Three Gabled Pavilion 153 Polo Crescent, Woodbridge, ON				
	DRAWING NAME:	Doveta	ail Details		
	DRAWN BY:	CHECKED BY:	SCALE:	DATE:	PROJECT NO.:
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	519.280.5384
ı	www.eliteengineeringgroup.com

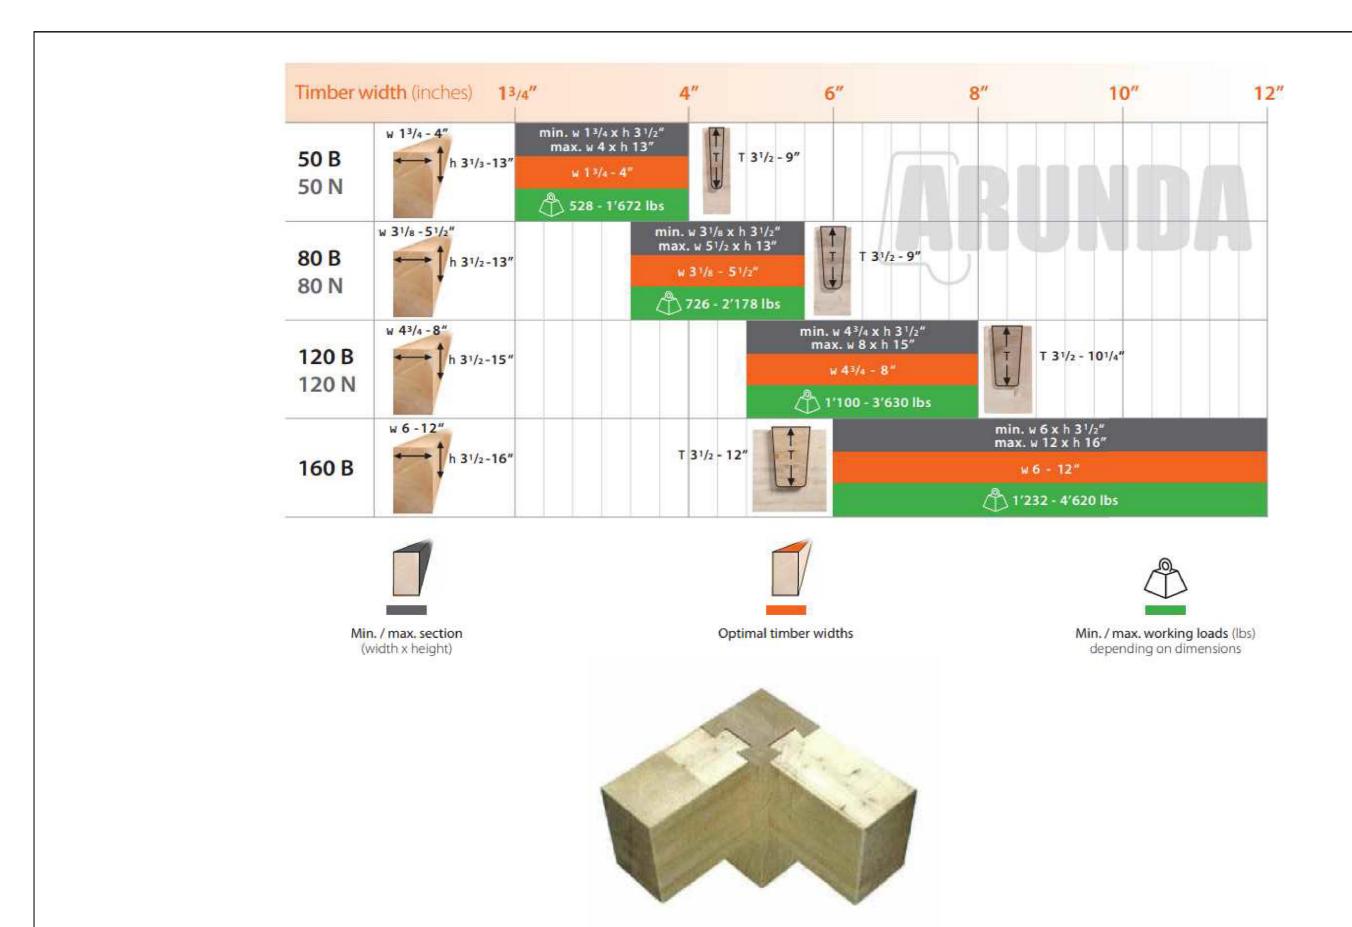
REV NO.	BY:	REVISION:	DATE:
1	S.B	ENGINEER REVIEW	01/14/23



[	Fabio Oliveira - 25'x14' Three Gabled Pavilion 153 Polo Crescent, Woodbridge, ON							
Drawing name:  Dovetail Details								
	DRAWN BY: CHECKED BY: SCALE: DATE: PROJECT NO.:							
	S.B	S.K	As Shown	01/14/23				
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#### ASSY 4.0 WHII TS RW40 ZN M8X100 177.580100



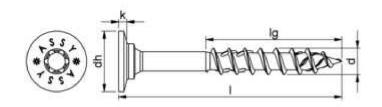

Nominal diameter (d)	8 mm
Length (I)	100 mm
Thread length (lg)	60 mm
Head type	Washer head II
Head diameter (d <sub>h</sub> )	18.4 mm
Head height (k)	2.5 mm
Internal drive	RW40
Thread type	Wood screw thread
Thread design	Partial thread
End milling cutter	Yes
Thread format	Coarse thread
Core diameter	5.3 mm
Shape of tip	Tip with hilltop milling cutter
Angle of the tip	34 Degree
Material	Hardened steel
Surface	Zinc plated
Colour	Silver
Max. screw-in angle	90 Degree
Min. screw-in angle	0 Degree
Suitable for use in the following materials	Wood
	Derived timber product
	Softwood
	Board ply wood (BSP)
	Hardwood
	LVL
Area of application	Structural woodwork
	On rafter insulation
	Element construction
	Timber construction
	Timber panel construction
	Roof
Additional accessory	Bit lock
Approval	ETA-11/0190
RoHS-compliant	Yes



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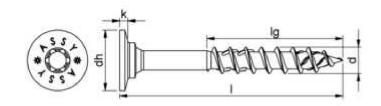
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1	S.B	ENGINEER REVIEW	01/14/23



Fabio Oliveira - 25'x14' Three Gabled Pavilion 153 Polo Crescent, Woodbridge, ON									
Dovetail Details									
DRAWN BY:	DRAWN BY: CHECKED BY: SCALE: DATE: PROJECT NO.:								
S.B	S.K	As Shown	01/14/23						



#### ASSY 4.0 WHII TS RW40 ZN M8x160 177.580160





Nominal diameter (d)	8 mm
Length (I)	160 mm
Thread length (lg)	80 mm
Head type	Washer head II
Head diameter (d <sub>h</sub> )	18.4 mm
Head height (k)	2.5 mm
Internal drive	RW40
Thread type	Wood screw thread
Thread design	Partial thread
End milling cutter	Yes
Thread format	Coarse thread
Core diameter	5.3 mm
Shape of tip	Tip with hilltop milling cutter
Angle of the tip	34 Degree
Material	Hardened steel
Surface	Zinc plated
Colour	Silver
Max. screw-in angle	90 Degree
Min. screw-in angle	0 Degree
Suitable for use in the following materials	Wood
	Derived timber product
	Softwood
	Board ply wood (BSP)
	Hardwood
	LVL
Area of application	Structural woodwork
	On rafter insulation
	Element construction
	Timber construction
	Timber panel construction
	Roof
Additional accessory	Bit lock
Approval	ETA-11/0190
RoHS-compliant	Yes




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[	Fabio Oliveira - 25'x14' Three Gabled Pavilion 153 Polo Crescent, Woodbridge, ON								
	Dovetail Details								
	DRAWN BY: CHECKED BY: SCALE: DATE: PROJECT NO.:								
	S.B S.K As Shown 01/14/23								

#### ASSY 4.0 WHII TS RW40 ZN M8X300 177.580300





Nominal diameter (d)	8 mm
Length (I)	300 mm
Thread length (lg)	100 mm
Head type	Washer head II
Head diameter (d <sub>h</sub> )	18.4 mm
Head height (k)	2.5 mm
Internal drive	RW40
Thread type	Wood screw thread
Thread design	Partial thread
End milling cutter	Yes
Thread format	Coarse thread
Core diameter	5.3 mm
Shape of tip	Tip with hilltop milling cutter
Angle of the tip	34 Degree
Material	Hardened steel
Surface	Zinc plated
Colour	Silver
Max. screw-in angle	90 Degree
Min. screw-in angle	0 Degree
Suitable for use in the following materials	Wood
	Derived timber product
	Softwood
	Board ply wood (BSP)
	Hardwood
	LVL
Area of application	Structural woodwork
	On rafter insulation
	Element construction
	Timber construction
	Timber panel construction
	Roof
Additional accessory	Bit lock
Approval	ETA-11/0190
RoHS-compliant	Yes

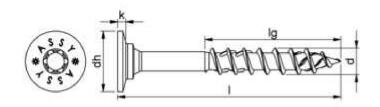


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1	S.B	ENGINEER REVIEW	01/14/23



Fabio Oliveira - 25'x14' Three Gabled Pavilion 153 Polo Crescent, Woodbridge, ON				
DRAWING NAME:				
DRAWN BY:	CHECKED BY:	SCALE:	DATE:	PROJECT NO.:
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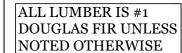


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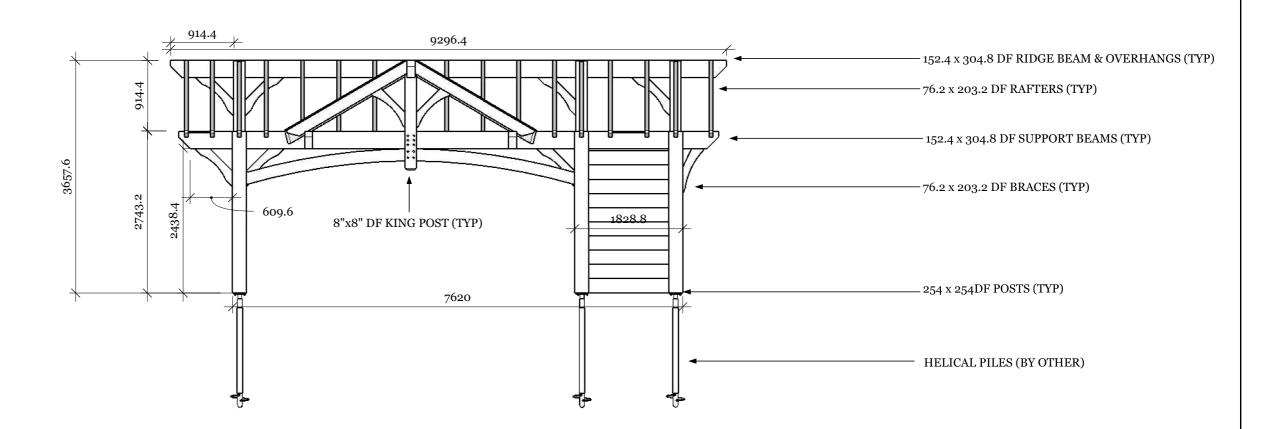
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1	S.B	ENGINEER REVIEW	01/14/23
2	S.B	ENGINEER REVIEW	02/03/23

TIMBERKITS "
by Country Log Homes

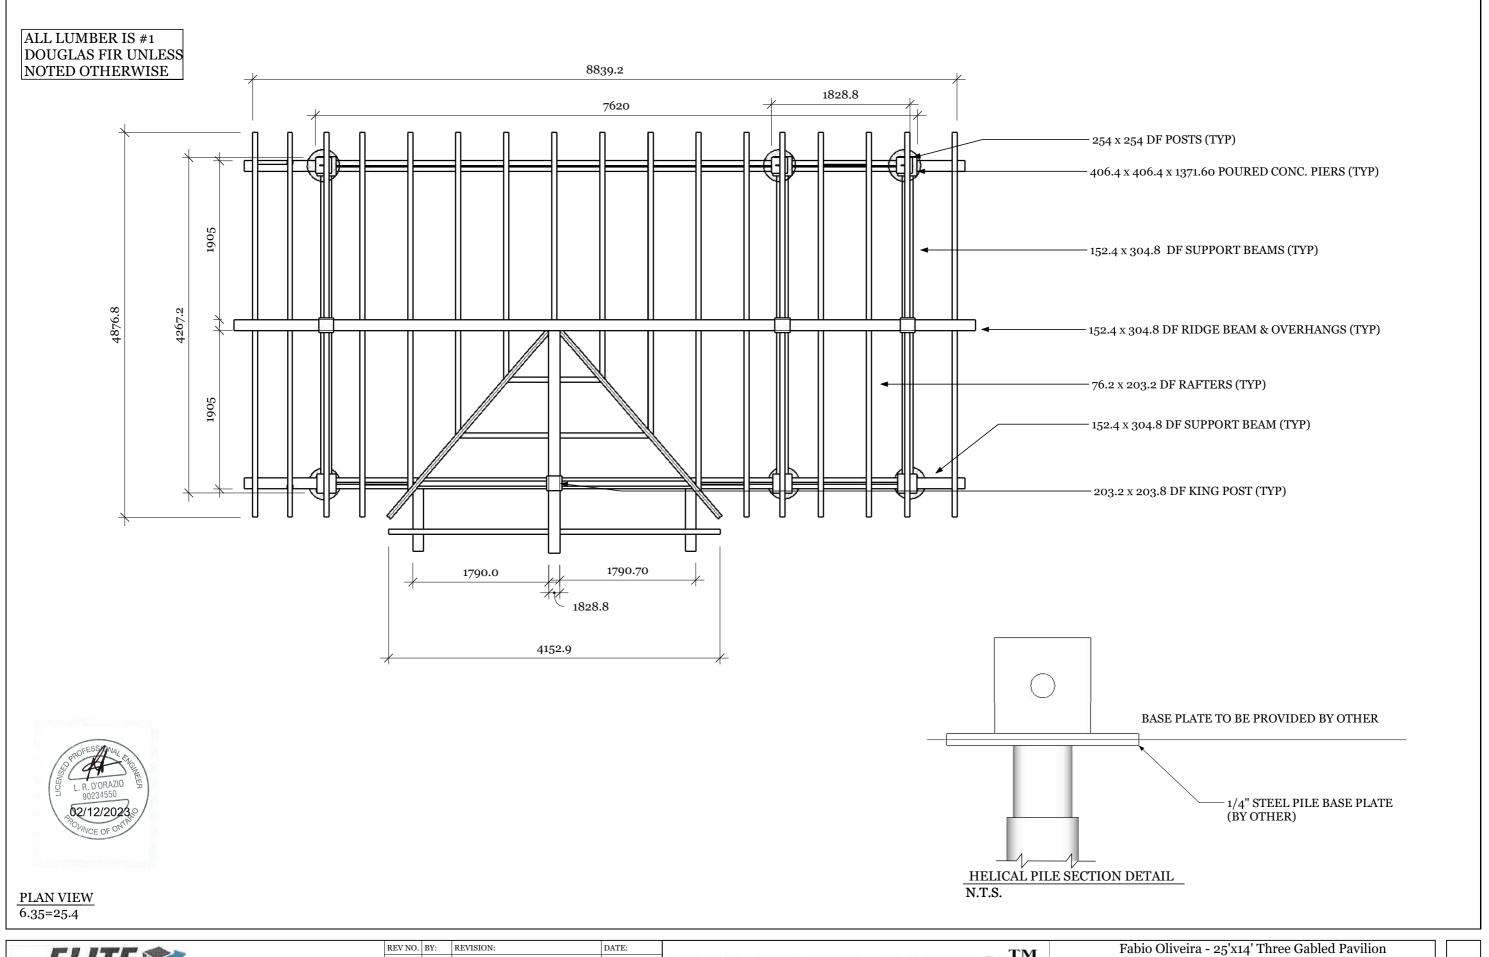]	Fabio Oliveira - 25'x14' Three Gabled Pavilion 153 Polo Crescent, Woodbridge, ON					
DRAWING NAME: Plan & Pier Footing Details						
	DRAWN BY: CHECKED BY: SCALE: DATE: PROJECT NO.:					
	S.B	S.K	As Shown	01/14/23		




ASPHALT SHINGLES OR METAL ON 1/2" PLYWOOD SHEATING ON 1/6" PINE SUBSTRATE (BY OTHER) or 2/6" PINE SUBSTRATE



#### FRONT ELEVATION

25.4=1625.6

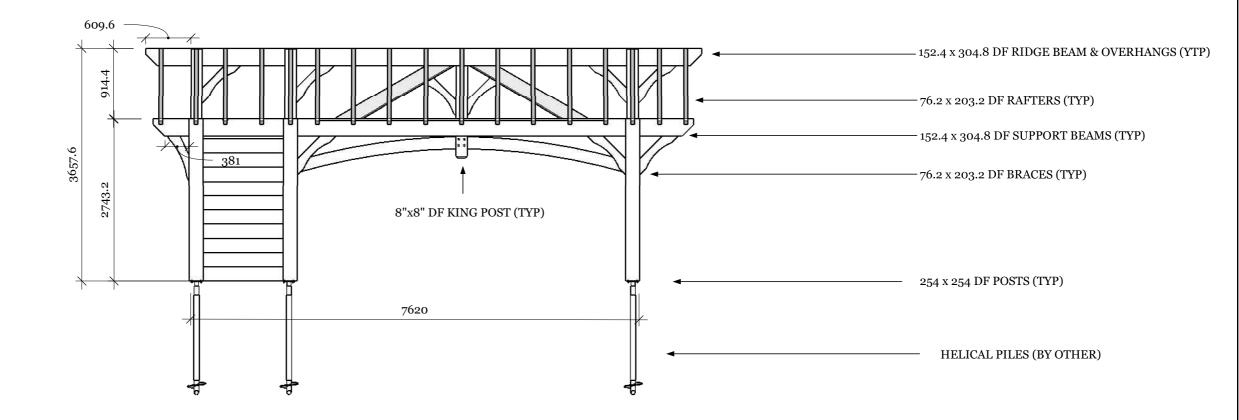



REAR ELEVATION

25.4=1625.6


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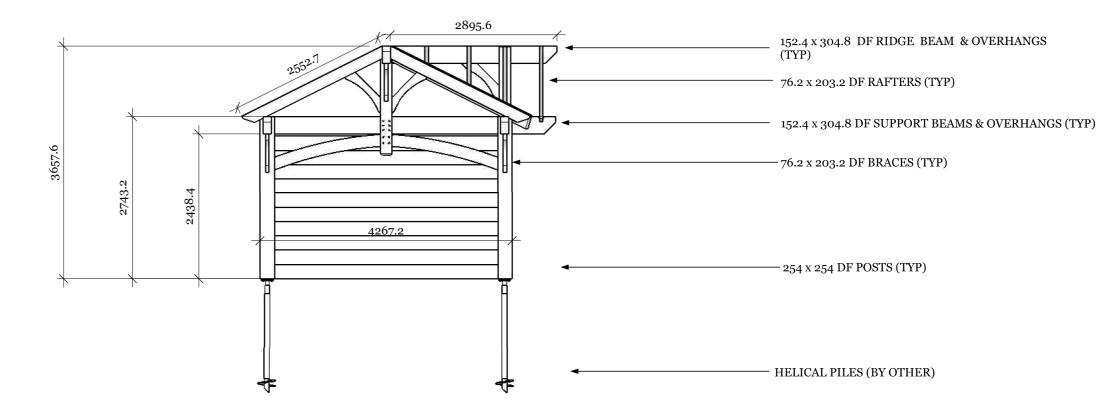
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I	Fabio Oliveira - 25'x14' Three Gabled Pavilion 153 Polo Crescent, Woodbridge, ON					
	DRAWING NAME:	E	levations			
	DRAWN BY: CHECKED BY: SCALE: DATE: PROJECT NO.:					
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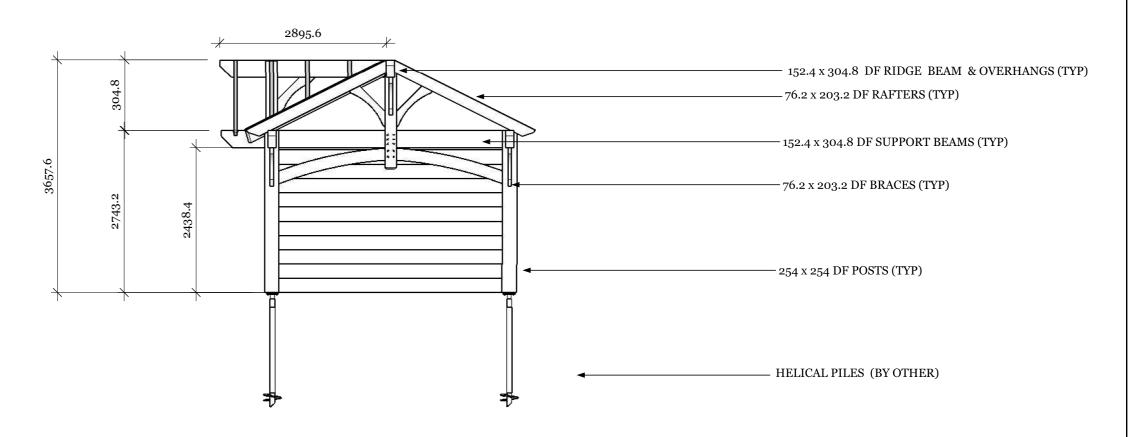


ASPHALT SHINGLES OR METAL ON 1/2" PLYWOOD SHEATING ON 1/6" PINE SUBSTRATE (BY OTHER) or 2/6" PINE SUBSTRATE



#### SIDE ELEVATION

25.4=1625.6

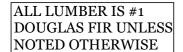



SIDE ELEVATION

25.5=1625.6


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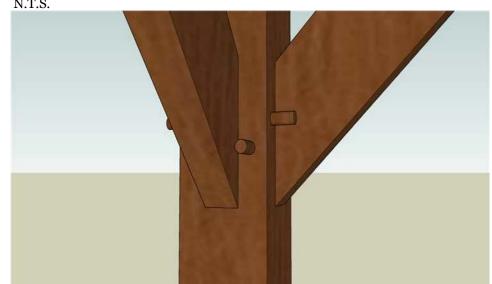
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]	Elevations		
CHECKED BY:	SCALE:	DATE:	PROJECT NO.:
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	153 Polo Cr	153 Polo Crescent, Wood  Elevations  CHECKED BY: SCALE:	CHECKED BY: SCALE: DATE:







POST/ANCHOR PLATE CONNECTION N.T.S.

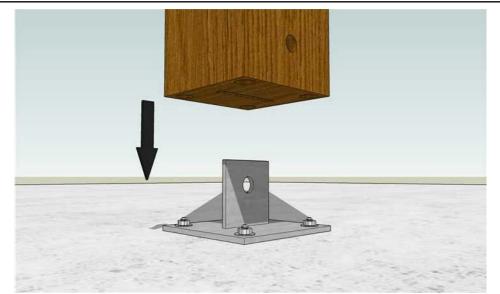

MORTICE BRACE/POST CONNECTION N.T.S. (Straight tenon connection secured with 1" x 11 1/2" oak dowel)

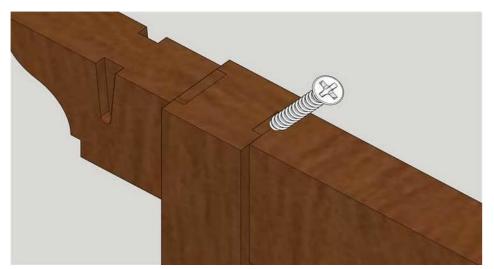

KING POST/RIDGE BEAM CONNECTION (DOVETAIL CONNECTION)
N.T.S. (6" Timber screws as additional reinforcement)

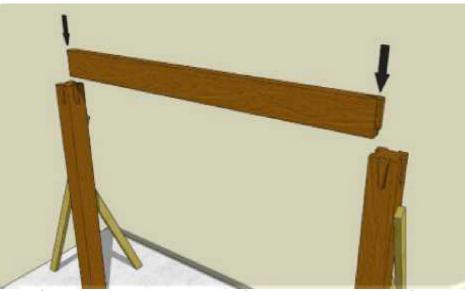


POST/SUPPORT BEAM CONNECTION (DOVE TAIL CONNECTION) N.T.S. (6" Timber screws as additional reinforcement)



KING POST/SUPPORT BEAM CONNECTION N.T.S.




N.T.S.

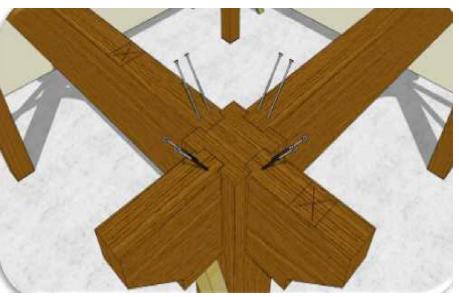

POST/OVERHANG CONNECTION (DOVETAIL CONNECTION)
N.T.S. (6" Timber screws as additional reinforcement)



KING POST/RIDGE BEAM CONNECTION (DOVETAIL CONNECTION) N.T.S

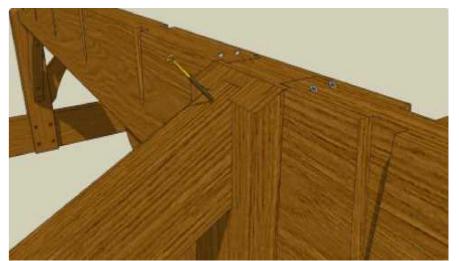

QUEEN RAFTER/SUPPORT BEAM CONNECTION (DOVETAIL CONNECTION) N.T.S. (6" timber screw used for additional reinforcement)



REV NO.	BY:	REVISION:	DATE:
1	S.B	ENGINEER REVIEW	01/14/23

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Fab	io Oliveira - 2 153 Polo Cr	25'x14' Three escent, Wood		ilion
General Connection Details				
DRAWN BY:	CHECKED BY:	SCALE:	DATE:	PROJECT NO.:
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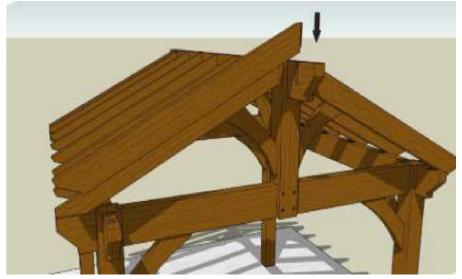




QUEEN RAFTER/OVERHANG CONNECTION N.T.S. (11" timber screw threw queen rafter to post overhang)




QUEEN BRACES/QUEEN RAFTER CONNECTION N.T.S. (11" timber screw threw queen brace to king post)



RAFTERS/RIDGE BEAM CONNECTION (DOVETAIL CONNECTION)
N.T.S.




SUPPORT BEAM/RAFTER CONNECTION
N.T.S. (11" timber screw for additional reinforcement)

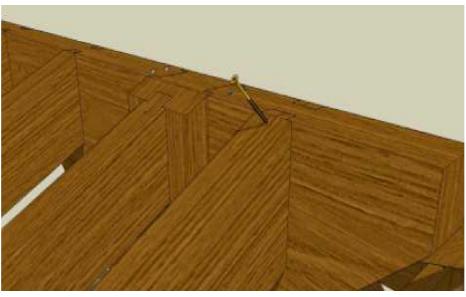


RIDGE BEAM OVERHANG/RAFTER CONNECTION N.T.S. (6" timber screw for additional reinforcement)



T&G ROOFING MATERIAL (1x6 or 2x6) 285.75 MORTISE BRACE DETAIL 19.05=25.4

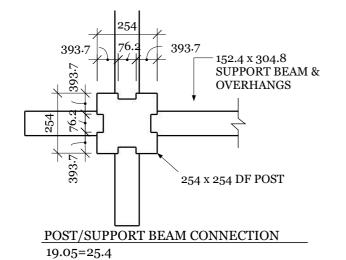

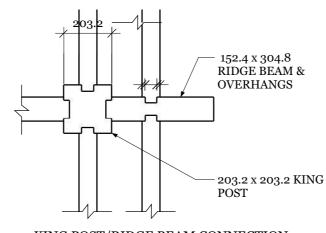

KING POST/RIDGE BEAM CONNECTION 19.05=25.4




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1	S.B	ENGINEER REVIEW	01/14/23

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	DRAWING NAME:	Doveta	ail Details		
	DRAWN BY:	CHECKED BY:	SCALE:	DATE:	PROJECT NO.:
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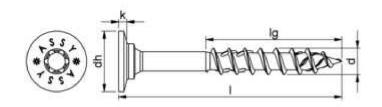
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1	S.B	ENGINEER REVIEW	01/14/23



[	Fabio Oliveira - 25'x14' Three Gabled Pavilion 153 Polo Crescent, Woodbridge, ON					
	Drawing name:  Dovetail Details					
	DRAWN BY:	CHECKED BY:	SCALE:	DATE:	PROJECT NO.:	
	S.B	S.K	As Shown	01/14/23		
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#### ASSY 4.0 WHII TS RW40 ZN M8X100 177.580100

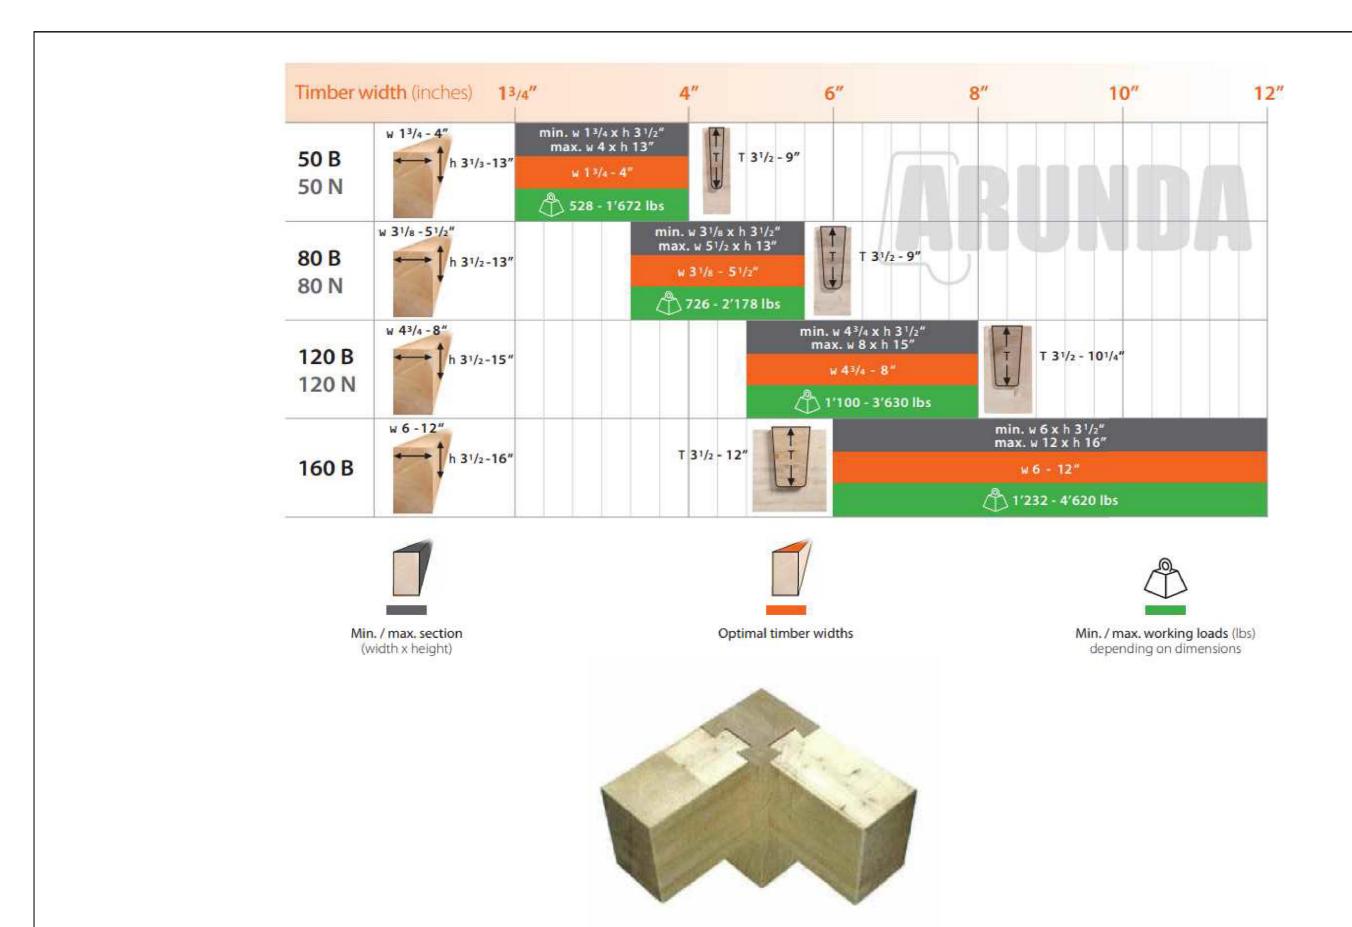



Nominal diameter (d)	8 mm
Length (I)	100 mm
Thread length (lg)	60 mm
Head type	Washer head II
Head diameter (d <sub>h</sub> )	18.4 mm
Head height (k)	2.5 mm
Internal drive	RW40
Thread type	Wood screw thread
Thread design	Partial thread
End milling cutter	Yes
Thread format	Coarse thread
Core diameter	5.3 mm
Shape of tip	Tip with hilltop milling cutter
Angle of the tip	34 Degree
Material	Hardened steel
Surface	Zinc plated
Colour	Silver
Max. screw-in angle	90 Degree
Min. screw-in angle	0 Degree
Suitable for use in the following materials	Wood
	Derived timber product
	Softwood
	Board ply wood (BSP)
	Hardwood
	LVL
Area of application	Structural woodwork
	On rafter insulation
	Element construction
	Timber construction
	Timber panel construction
	Roof
Additional accessory	Bit lock
Approval	ETA-11/0190
RoHS-compliant	Yes



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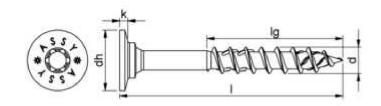
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Fabio Oliveira - 25'x14' Three Gabled Pavilion 153 Polo Crescent, Woodbridge, ON							
	DRAWING NAME:	Dovetail Details					
	DRAWN BY:	CHECKED BY:	SCALE:	DATE:	PROJECT NO.:		
	S.B	S.K	As Shown	01/14/23			



#### ASSY 4.0 WHII TS RW40 ZN M8x160 177.580160





Nominal diameter (d)	8 mm
Length (I)	160 mm
Thread length (lg)	80 mm
Head type	Washer head II
Head diameter (d <sub>h</sub> )	18.4 mm
Head height (k)	2.5 mm
Internal drive	RW40
Thread type	Wood screw thread
Thread design	Partial thread
End milling cutter	Yes
Thread format	Coarse thread
Core diameter	5.3 mm
Shape of tip	Tip with hilltop milling cutter
Angle of the tip	34 Degree
Material	Hardened steel
Surface	Zinc plated
Colour	Silver
Max. screw-in angle	90 Degree
Min. screw-in angle	0 Degree
Suitable for use in the following materials	Wood
	Derived timber product
	Softwood
	Board ply wood (BSP)
	Hardwood
	LVL
Area of application	Structural woodwork
	On rafter insulation
	Element construction
	Timber construction
	Timber panel construction
	Roof
Additional accessory	Bit lock
Approval	ETA-11/0190
RoHS-compliant	Yes




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1	S.B	ENGINEER REVIEW	01/14/23
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TIMBERKITS TM
by Country Log Homes

[	Fabio Oliveira - 25'x14' Three Gabled Pavilion 153 Polo Crescent, Woodbridge, ON					
Dovetail Details						
	DRAWN BY:	CHECKED BY:	SCALE:	DATE:	PROJECT NO.:	
	S.B	S.K	As Shown	01/14/23		

#### ASSY 4.0 WHII TS RW40 ZN M8X300 177.580300



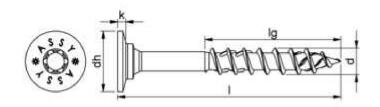

Nominal diameter (d)	8 mm
Length (I)	300 mm
Thread length (lg)	100 mm
Head type	Washer head II
Head diameter (d <sub>h</sub> )	18.4 mm
Head height (k)	2.5 mm
Internal drive	RW40
Thread type	Wood screw thread
Thread design	Partial thread
End milling cutter	Yes
Thread format	Coarse thread
Core diameter	5.3 mm
Shape of tip	Tip with hilltop milling cutter
Angle of the tip	34 Degree
Material	Hardened steel
Surface	Zinc plated
Colour	Silver
Max. screw-in angle	90 Degree
Min. screw-in angle	0 Degree
Suitable for use in the following materials	Wood
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	Softwood
	Board ply wood (BSP)
	Hardwood
	LVL
Area of application	Structural woodwork
	On rafter insulation
	Element construction
	Timber construction
	Timber panel construction
	Roof
Additional accessory	Bit lock
Approval	ETA-11/0190
RoHS-compliant	Yes



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Fabio Oliveira - 25'x14' Three Gabled Pavilion 153 Polo Crescent, Woodbridge, ON					
Dovetail Details					
DRAWN BY:	CHECKED BY:	SCALE:	DATE:	PROJECT NO.:	
S.B	S.K	As Shown	01/14/23		
	DRAWING NAME: DRAWN BY:	DRAWING NAME:  DOV  DRAWN BY:   CHECKED BY:	DRAWING NAME:  Dovetail Details  DRAWN BY:  CHECKED BY:  SCALE:	153 Polo Crescent, Woodbridge, ON  DRAWING NAME:  Dovetail Details  DRAWN BY:   CHECKED BY:   SCALE:   DATE:	



SCHEDULE B: STAFF & AGENCY COMMENTS						
DEPT/AGENCY	Circulated	Comments Received	Conditions	Nature of Comments		
TRCA *Schedule B	Х			No Comments Received to Date		
Ministry of Transportation (MTO) *Schedule B				No Comments Received to Date		
Region of York *Schedule B	Х	X		General Comments		
Alectra *Schedule B	Х	X		General Comments		
Bell Canada *Schedule B	Х			No Comments Received to Date		
YRDSB *Schedule B						
YCDSB *Schedule B						
CN Rail *Schedule B						
CP Rail *Schedule B						
TransCanada Pipeline *Schedule B	Х			No Comments Received to Date		
Metrolinx *Schedule B						
Propane Operator *Schedule B						
Development Planning	Х	Х	Х	Recommend Approval/with conditions		
Building Standards (Zoning)	Х	Х		General Comments-*Zoning Review Waiver Submitted		



**Date:** May 8<sup>th</sup> 2023

Attention: Christine Vigneault

**RE:** Request for Comments

File No.: A025-23

**Related Files:** 

Applicant Angela Coluccio and Fabio Oliveira

**Location** 153 Polo Crescent



#### **COMMENTS:**

	We have reviewed the proposed Variance Application and have no comments or objections to its approval.
X	We have reviewed the proposed Variance Application and have no objections to its approval, subject to the following comments (attached below).
	We have reviewed the proposed Variance Application and have the following concerns (attached below).

Alectra Utilities (formerly PowerStream) has received and reviewed the proposed Variance Application. This review, however, does not imply any approval of the project or plan.

All proposed billboards, signs, and other structures associated with the project or plan must maintain minimum clearances to the existing overhead or underground electrical distribution system as specified by the applicable standards, codes and acts referenced.

In the event that construction commences, and the clearance between any component of the work/structure and the adjacent existing overhead and underground electrical distribution system violates the Occupational Health and Safety Act, the customer will be responsible for 100% of the costs associated with Alectra making the work area safe. All construction work will be required to stop until the safe limits of approach can be established.

In the event construction is completed, and the clearance between the constructed structure and the adjacent existing overhead and underground electrical distribution system violates the any of applicable standards, acts or codes referenced, the customer will be responsible for 100% of Alectra's cost for any relocation work.

#### References:

- Ontario Electrical Safety Code, latest edition (Clearance of Conductors from Buildings)
- Ontario Health and Safety Act, latest edition (Construction Protection)
- Ontario Building Code, latest edition (Clearance to Buildings)
- PowerStream (Construction Standard 03-1, 03-4), attached
- Canadian Standards Association, latest edition (Basic Clearances)

If more information is required, please contact either of the following:

Mr. Stephen Cranley, C.E.T

Supervisor, Distribution Design, ICI & Layouts (North)

**Phone**: 1-877-963-6900 ext. 31297

**E-mail**: stephen.cranley@alectrautilities.com

Mitchell Penner

Supervisor, Distribution Design-Subdivisions

**Phone**: 416-302-6215

Email: Mitchell.Penner@alectrautilities.com




Power Stream 1

### Construction Standard

03-1

	SYSTEM VOLTAGE				
LOCATION OF WIRES, CABLES OR CONDUCTORS	SPAN GUYS AND COMMUNICATIONS WIRES		4.16/2.4kV TO 27.6/16kV (SEE NOTE 1)	44kV	
	MINIMUM	VERTICAL CLEA	ARANCES (SEE	NOTE 2)	
OVER OR ALONGSIDE ROADS, DRIVEWAYS OR LANDS ACCESSIBLE TO <u>VEHICLES</u>	442cm	442cm	480cm	520cm	
OVER GROUND ACCESSIBLE TO PEDESTRIANS AND BICYCLES ONLY	250cm	310cm	340cm	370cm	
ABOVE TOP OF RAIL AT RAILWAY CROSSINGS	730cm	730cm	760cm	810cm	

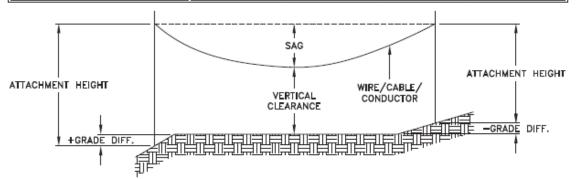

MINIMUM ATTACHMENT HEIGHT = MAXIMUM SAG

- + MINIMUM VERTICAL CLEARANCE (FROM ABOVE TABLE)
  ± GRADE DIFFERENCE

- + 0.3m (VEHICLE OR RAILWAY LOCATION) + SNOW DEPTH (PEDESTRIAN LOCATION, SEE NOTE 3)

#### NOTES:

- THE MULTIGROUNDED SYSTEM NEUTRAL HAS THE SAME CLEARANCE AS THE 600V SYSTEM.
- 2. THE VERTICAL CLEARANCES IN THE ABOVE TABLE ARE UNDER  $\underline{\text{MAXIMUM SAG}}$  CONDITIONS.
- 3. REFER TO CSA STANDARD C22.3 No.1, ANNEX D FOR LOCAL SNOW DEPTH
- 4. ALL CLEARANCES ARE IN ACCORDANCE TO CSA STANDARD C22.3.

<u>\G</u>	340cm	11'-4"				
	310cm	10'-4"				
VALUES.	250cm	8'-4"				
VALUES.						
REFERENCES						
SAGS AND T	FNSIONS 1	SECTION 02				

METRIC

810cm

760cm 730cm

520cm 480cm

442cm 370cm

CONVERSION TABLE

IMPERIAL (APPROX)

27'-0" 25'-4"

24'-4" 17'-4"

15'-5" 12'-4"

# MINIMUM VERTICAL CLEARANCES OF WIRES, CABLES AND CONDUCTORS ABOVE GROUND OR RAILS


ORIGINAL ISSUE DATE: 2010-DEC-24 REVISION NO: R1 REVISION DATE: 2012-JAN-09


Certificate of Approval This construction Standard meets the safety requirements of Section 4 of Regulation 22/04		
Joe Crozier, P.Eng. 2012-JAN-09 Name Date		
P Fng. Approval By:	Ine Crozier	



#### Construction Standard

03 - 4

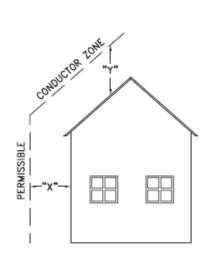

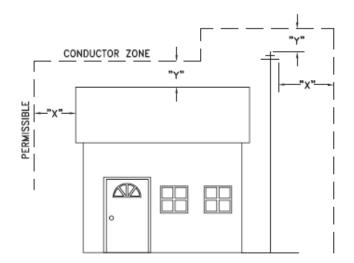

VOLTAGE	MINIMUM HORIZONTAL CLEARNACE UNDER MAXIMUM SWING CONDITIONS DIMENSION "X" (SEE NOTES 1, 3 & 4)	MINIMUM VERTICAL CLEARANCE UNDER MAXIMUM DESIGN SAG CONDITIONS DIMENSION "Y" (SEE NOTES 1, 2, 4 & 5)
0-600V AND NEUTRAL	100cm	250cm
4.16/2.4 TO 44kV	300cm	480cm

#### NOTES

- UNDER NO CIRCUMSTANCES SHALL A CONDUCTOR BE PERMITTED TO PENETRATE THE ENVELOPE SHOWN BY THE DOTTED LINE.
- 2. THE VERTICAL CLEARANCES ARE UNDER CONDITIONS OF MAXIMUM DESIGN SAG.
- THE HORIZONTAL CLEARANCES ARE UNDER CONDITIONS OF MAXIMUM SWING. WHERE THE CONDUCTOR SWING IS NOT KNOWN A HORIZONTAL CLEARANCE OF 480CM SHALL BE USED.
- 4. BUILDINGS THAT EXCEED 3 STOREYS OR 15M IN HEIGHT, THE MINIMUM HORIZONTAL CLEARANCE OF THE SECONDARY CONDUCTORS SHOULD BE INCREASED TO 300cm WHERE IT IS NECESSARY TO ALLOW FOR THE RAISING OF LADDERS BY LOCAL FIRE DEPARTMENTS.
- IN SITUATIONS SUCH AS MULTI-LEVEL GARAGES, WHERE ROOFS ARE NORMALLY USED BY PERSONS AND VEHICLES, THE VERTICAL CLEARANCES OF POWERSTREAM STANDARD 03-1 SHALL APPLY.
- 6. DISTRIBUTION LINES CONSTRUCTED NEAR BUILDINGS SHALL BE BUILT TO AVOID OVERHANG WHEREVER POSSIBLE. WHERE LINES MUST BE CONSTRUCTED OVER OR ADJACENT TO BUILDINGS THE APPLICABLE HORIZONTAL AND VERTICAL CLEARANCES SHALL BE AT CONDITIONS OF MAXIMUM CONDUCTOR SWING AND MAXIMUM SAG. THE ABOVE CLEARANCES ARE DESIGNED TO PREVENT PERSONS ON OR IN BUILDINGS AS WELL AS EXTERNAL MACHINERY USED IN CONJUCTION WITH A BUILDING TO COME IN CONTACT WITH CONDUCTORS. EFFORTS SHOULD BE MADE TO INCREASE THESE CLEARANCES WHERE POSSIBLE.
- 7. ALL CLEARANCES ARE IN ACCORDANCE TO CSA C22.3 NO.1-06 (TABLE-9).

CONVERSION TABLE			
IMPERIAL			
(APPROX)			
16'-0"			
10'-0"			
8'-4"			
3'-4"			

#### MINIMUM VERTICAL & HORIZONTAL CLEARANCES OF CONDUCTORS FROM BUILDINGS OR OTHER PERMANENT STRUCTURES (CONDUCTORS NOT ATTACHED TO BUILDINGS)

ORIGINAL ISSUE DATE: 2010—MAY—05 REVISION NO: REVISION DATE:
PEgystem Planning and Standards/Standard Design/PowerStream Standards/soundard working (lighter/Seedlan 3/3-4/c/wg d3-4 Ro May 5, 2010, s/wg, 3/3/2010 8/2/202 AM, Adobe POF



To: Committee of Adjustment

From: Faegheh Gholami, Building Standards Department

**Date:** May 04, 2023

Applicant: Angela Coluccio and Fabio Oliveira

**Location:** 153 Polo Crescent

PLAN 65M3625 Lot 21

**File No.(s):** A025/23

#### **Zoning Classification:**

The subject lands are zoned R1A(EN) – First Density Residential Zone (Established Neighbourhood) under Zoning By-law 001-2021, as amended.

#	Zoning By-law 001-2021	Variance requested
1	A minimum side yard setback of 2.4m is required to the proposed residential accessory structure.  [4.1.2.b]	Topermit a minimum side yard seback of 1.0m to the proposed residential accessory structure.
2	A minimum interior side yard setback of 1.5m is required to the existing residential structure (storage shed).  [Table 7-3]	To permit a minimum side yard setback of 0.39m is required to the existing residential structure (storage shed).
3	A maximum height of 3.0m is permitted for the proposed residential accessory structure. [4.1.4.1]	To permit a maximum residential accessory structure height of 3.20m.
4	In the R1A Zone, any portion of a yard in excess of 135 m2 shall be comprised of a tolerimum of 60% soft landscape. [4.19.1.1].	To permit a minimum of 41.53% of the area of the rear yard in excess of 135 sq. m. to be comprised of soft landscaping.

The subject large are zoned R1 – Residential under Zoning By-law 1-88, as amended.

	Zor.iog მy-law 1-88	Variance requested
1	R	

#### **Staff Comments:**

#### Stop Work Order(s) and Order(s) to Comply:

There are no outstanding Orders on file

#### **Building Permit(s) Issued:**

A Building Permit has not been issued. The Ontario Building Code requires a building permit for structures that exceed 10m2

#### **Other Comments:**

# General Comments The applicant shall be advised that additional variances may be required upon review of detailed drawing for building permit/site plan approval.

#### **Conditions of Approval:**



If the committee finds merit in the application, the following conditions of approval are recommended.

 $^{\star}$  Comments are based on the review of documentation supplied with this application.

Replaced with Zoning Review Waiver

#### **ZONING REVIEW WAIVER**

l,

Name of authorized owner or agent

Agree to proceed with an application(s) to the Committee of Adjustment without the benefit of having my revised submission reviewed by a Zoning Examiner within the City of Vaughan Building Standards Department, for the purposes of confirming the variances required to facilitate my proposal.

I assume full responsibility for identifying, correctly and completely, all variances associated with my proposal/application.

I also recognize and acknowledge that any errors may result in:

- a) a potential delay in the processing of my application(s);
- b) an inability to obtain a building permit;
- c) the need for additional application(s) to the Committee of Adjustment; and
- d) additional fees (adjournment/recirculation).

Date:

Signature: Robert Pasudto

#### **IMPORTANT**

By completing this Zoning Review Waiver, you are conducting a zoning review of your revised submission and assuming responsibility for identifying <u>all</u> variances required to facilitate your proposed development. If you would like zoning staff to conduct this review your file will require adjournment to a future hearing date.

#### **Helpful Tips:**

Review your original zoning report provided by your file manager. This report may be used as a tool to complete your review on the next page.

You may want to consider copying and pasting the variances, confirmed in your zoning report, into the charts on the next page as a starting point and update as required.

If new variances are required, you will need to review the applicable By-law to determine requirements. If you are submitting a Zoning Review Waiver Form, staff cannot assist you with completing your review.

Ensure that **all** variances are included in the charts below, even variances that are not changing from the zoning report must be included. The omission of a variance may result in delays in processing, inability to obtain a building permit after approval, requirement of additional applications and fees.

See next page to complete your review.

# REVISED SUBMISSION - ZONING REVIEW (WAIVER SUBMITTED)

In the chart below, identify all variances required under Zoning By-law 001-2021:

**By-law Requirement** 

\*Quote actual provision of By-law

**ZONING BY-LAW 001-2021** 

Variance Requested

Completed By:

Date:

#

2

3

4

File No.(s):

**Property:** 

5		
6		
7		
8		
9		
10		
In the	e chart below, identify <u>all</u> variances require	
#	By-law Requirement *Quote actual provision of By-law	Variance Requested
1	Quote actual provision of by-law	
2		
3		
4		
5		
6		
7		
8		
9		
10		

Zoning Review Waivers can only be submitted if your application has received an initial zoning review. Staff cannot be consulted to complete your Zoning Review Waiver. The owner/ agent can obtain a zoning review of their revised application, through the Committee of Adjustment submission process in accordance with the Committee of Adjustment internal deadlines. Should an applicant/agent/representative wish to proceed to a hearing without a revised submission being reviewed by a zoning examiner they must complete this waiver to assume full responsibility for identifying required variances.





**To:** Christine Vigneault, Committee of Adjustment Secretary Treasurer

From: Nancy Tuckett, Director of Development Planning

**Date:** May 24, 2023

Name of Owners: Angela Coluccio and Fabio Oliveira

Location: 153 Polo Crescent

File No.(s): A025/23

#### Proposed Variance(s) (By-law 001-2021):

- 1. To permit a minimum side yard setback of 1.0 m to the proposed residential accessory structure.
- 2. To permit a minimum side yard setback of 0.39 m is required to the existing residential structure (storage shed).
- 3. To permit a maximum residential accessory structure height of 3.20 m.
- 4. To permit a minimum of 54.3% of the area of the rear yard in excess of 135 m<sup>2</sup> to be comprised of soft landscaping.

#### By-Law Requirement(s) (By-law 001-2021):

- 1. A minimum side yard setback of 2.4 m is required to the proposed residential accessory structure.
- 2. A minimum interior side yard setback of 1.5 m is required to the existing residential structure (storage shed).
- 3. A maximum height of 3.0 m is permitted for the proposed residential accessory structure.
- 4. In the R1A Zone, any portion of a yard in excess of 135 m<sup>2</sup> shall be comprised of a minimum of 60% soft landscape.

#### Official Plan:

City of Vaughan Official Plan 2010 ('VOP 2010'): "Low-Rise Residential"

#### Comments:

The Owners are requesting relief to permit the existing shed, the construction of a cabana and the addition of rear yard hard landscaping, with the above noted variances.

The Development Planning Department has no objection to Variances 1 and 3 for the proposed cabana. The cabana is a partially open structure with an enclosed room on the west side and a wall segment abutting the south interior lot line. The cabana, as a partially open structure, presents less mass overall relative to a fully enclosed structure and the south wall presents minimal mass to the abutting property. The minimum interior side yard setback is measured at a pinch-point that expands to 1.42 m at its greatest extent. The 0.2 m increase in height for the cabana is minor in nature and not anticipated to pose adverse use or massing impacts to the neighbouring properties. As such, the cabana will not pose adverse massing and privacy impacts to the neighbouring properties and provides an appropriate area for maintenance access.

The Development Planning Department has no objection to Variance 2 for the shed. The reduction to the interior side yard setback is measured at a pinch point that expands to approximately 0.55 m at its greatest extent. The shed also complies with the height requirements in the Zoning By-law. As such, the shed will not pose adverse massing and privacy impacts to the neighbouring properties and an appropriate area for maintenance access is maintained.

The Owners have revised their application to provide additional rear yard soft landscaping upon recommendations from the Development Planning Department. The Development Planning Department has no objection to Variance 4 for the revised rear yard soft landscaping. The reduction in soft landscaping is minor in nature and will maintain an appropriate balance of soft landscaping to facilitate drainage, reduce urban heat island effects, and facilitate the establishment of vegetation. The Development Engineering Department has also reviewed the proposal and is satisfied that drainage in the rear yard will be maintained.

### memorandum



In support of the application, the Owners have submitted an Arborist Report prepared by Al Miley & Associates, dated October 13, 2022. The report inventoried one tree, which is proposed to be removed. Urban Design staff have reviewed the report and concur with its recommendations.

Accordingly, the Development Planning Department can support the requested variances and is of the opinion that the proposal is minor in nature, maintains the general intent and purpose of the Official Plan and Zoning By-law, and is desirable for the appropriate development of the land.

#### **Recommendation:**

The Development Planning Department recommends approval of the application, subject to the following condition:

#### **Condition of Approval:**

If the Committee finds merit in the application, the following condition of approval is recommended:

1. That the final Landscape Plan be approved to the satisfaction of the Development Planning Department.

#### **Comments Prepared by:**

Joshua Cipolletta, Planner I David Harding, Senior Planner From: Development Services
To: Christine Vigneault
Cc: Committee of Adjustment

Subject: [External] RE: A025/23 (153 Polo Crescent) - REQUEST FOR COMMENTS, CITY OF VAUGHAN

**Date:** Thursday, May 11, 2023 5:23:18 PM

Attachments: image001.pnq

image003.png

Hi Christine,

The Regional Municipality of York has completed its review of the above minor variance and has no comment.

Many thanks,

Our working hours may be different. Please do not feel obligated to reply outside of your scheduled working hours. Let's work together to help foster healthy work-life boundaries.

**Niranjan Rajevan**, **M.Pl.** | Associate Planner, Programs and Process Improvement, Planning and Economic Development, Corporate Services

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The Regional Municipality of York | 17250 Yonge Street | Newmarket, ON L3Y 6Z1 1-877-464-9675 ext. 71521 | niranjan.rajevan@york.ca | www.york.ca

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# SCHEDULE C: PUBLIC & APPLICANT CORRESPONDENCE

None