**ITEM: 6.6** 

# COMMITTEE OF ADJUSTMENT REPORT SUMMARY MINOR VARIANCE APPLICATION FILE NUMBER A046/23 138 THORNRIDGE DRIVE, THORNHILL

# THIS REPORT CONTAINS COMMENTS FROM THE FOLLOWING DEPARTMENTS & AGENCIES:

\*Please see Schedule B of this report for a copy of Development Planning and Agency correspondence.

Additional comments from departments and agencies may be received after the publication of the Staff Report. These comments will be processed as an addendum and posted on the City's Website.

			General Comments General Comments
$\boxtimes$			
			No Comments Received to Date
X	_		Application Under Review
		$\boxtimes$	Recommend Approval w/Conditions
$\boxtimes$		$\boxtimes$	General Comments w/condition
$\boxtimes$			No Comments Received to Date
$\boxtimes$			General Comments
$\boxtimes$			No Comments Received to Date
rculated	Comments Received	Conditions	Nature of Comments
$\boxtimes$			No Comments Received to Date
$\boxtimes$	$\boxtimes$		General Comments
$\boxtimes$	$\boxtimes$		General Comments
$\boxtimes$			No Comments Received to Date
$\boxtimes$			No Comments Received to Date
	X		

# **PUBLIC & APPLICANT CORRESPONDENCE**

\*Please see **Schedule C** of this report for a copy of the public & applicant correspondence listed below.

The deadline to submit public comments is noon on the last business day prior to the scheduled hearing date.

Comments and written public submissions received after the publication of this Staff Report will be processed as an addendum and posted on the City's Website.

All personal information collected because of this public meeting (including both written and oral submissions) is collected under the authority of the Municipal Act, the Municipal Freedom of Information and Protection of Privacy Act (MFIPPA), the Planning Act and all other relevant legislation, and will be used to assist in deciding on this matter. All personal information (as defined by MFIPPA), including (but not limited to) names, addresses, opinions and comments collected will become property of the City of Vaughan, will be made available for public disclosure (including being posted on the internet) and will be used to assist the Committee of Adjustment and staff to process this application.

Correspondence Type	Name	Address	Date Received (mm/dd/yyyy)	Summary
None				

PREVIOUS COA DECISIONS ON THE SUBJECT LAND		
*Please see <b>Schedule D</b> for a copy of the Decisions listed below		
File Number	Date of Decision	Decision Outcome
	MM/DD/YYYY	

PREVIOUS COA DECISIONS ON THE SUBJECT LAND  *Please see Schedule D for a copy of the Decisions listed below		
None		

ADJOURNMENT HISTORY		
* Previous hearing dates where this application was adjourned by the Committee and public notice issued.		
None		



# COMMITTEE OF ADJUSTMENT REPORT MINOR VARIANCE APPLICATION A046/23

# 138 THORNRIDGE DRIVE, THORNHILL

ITEM NUMBER: 6.6	CITY WARD #: 5
APPLICANT:	Liangyan Shui
AGENT:	Frank Feng
PROPERTY:	138 Thornridge Drive, Thornhill
ZONING DESIGNATION:	See below
VAUGHAN OFFICIAL PLAN (2010) DESIGNATION:	Vaughan Official Plan 2010 ('VOP 2010'): "Low-Rise Residential"
RELATED DEVELOPMENT APPLICATIONS:	None
PURPOSE OF APPLICATION:	Relief from the Zoning By-law is being requested to permit a proposed addition to the existing dwelling.

The following variances have been requested from the City's Zoning By-law:

The subject lands are zoned R1E(EN) – First Density Residential Zone (Established Neighbourhood) and subject to the provisions of Exception 14.403 under Zoning By-law 001-2021, as amended.

#	Zoning By-law 001-2021	Variance requested
1	The maximum permitted lot coverage is 23%.	To permit a maximum lot coverage
	[Section 7.2.2. Table 7-3, Footnote (2)]	of 25.86%.

# **HEARING INFORMATION**

**DATE OF MEETING:** Thursday, May 11, 2023

**TIME:** 6:00 p.m.

MEETING LOCATION: Vaughan City Hall, Woodbridge Room (2<sup>nd</sup> Floor), 2141 Major Mackenzie Drive

LIVE STREAM LINK: Vaughan.ca/LiveCouncil

# **PUBLIC PARTICIPATION**

If you would like to speak to the Committee of Adjustment at the meeting, either remotely or in person, please complete the Request to Speak Form and submit to cofa@vaughan.ca

If you would like to submit written comments, please quote file number above and submit by mail or email to:

Email: cofa@vaughan.ca

**Mail:** City of Vaughan, Office of the City Clerk, Committee of Adjustment, 2141 Major Mackenzie Drive, Vaughan, ON, L6A 1T1

To speak electronically, pre-registration is required by completing the Request to Speak Form on-line and submitting it to cofa@vaughan.ca no later than NOON on the last business day before the meeting.

THE DEADLINE TO REGISTER TO SPEAK ELECTRONICALLY OR SUBMIT WRITTEN COMMENTS ON THE ABOVE NOTED FILE(S) IS <u>NOON</u> ON THE LAST BUSINESS DAY BEFORE THE MEETING.

# INTRODUCTION

Staff and Agencies act as advisory bodies to the Committee of Adjustment. The comments contained in this report are presented as recommendations to the Committee.

Section 45(1) of the Planning Act sets the criteria for authorizing minor variances to the City of Vaughan's Zoning By-law. Accordingly, review of the application may consider the following:

That the general intent and purpose of the by-law will be maintained.

That the general intent and purpose of the official plan will be maintained.

# INTRODUCTION

That the requested variance(s) is/are acceptable for the appropriate development of the subject lands. That the requested variance(s) is/are minor in nature.

Public written and oral submissions relating to this application are taken into consideration by the Committee of Adjustment as part of its deliberations and final decision on this matter.

COMMITTEE OF ADJUSTMENT COMMENTS		
Date Public Notice Mailed:	April 27, 2032	
Date Applicant Confirmed Posting of Sign:	April 18, 2023	
Applicant Justification for Variances: *As provided by Applicant in Application Form	The Maximum Lot Coverage is 23% re By-law. The proposed lot coverage is proposed addition to the existing build	25.86% as the
Adjournment Requests (from staff):  *Adjournment requests provided to applicant prior to issuance of public notice  N/A		
Was a Zoning Review Waiver (ZRW) For	rm submitted by Applicant:	No
*ZRW Form may be used by applicant in instances where a revised submission is made, and zoning staff do not have an opportunity to review and confirm variances prior to the issuance of public notice.		
*A revised submission may be required to address staff / agency comments received as part of the application review process.		
*Where a zoning review has not been completed on a revised submission, an opportunity is provided to the applicant to adjourn the proposal prior to the issuance of public notice.		
Adjournment Fees: In accordance with Procedural By-law 069-2019, an Adjournment Fee is applicable to reschedule an application		

An Adjournment Fee can only be waived in instances where adjournment of an application is requested by the

issuance of public notice.

after the issuance of public notice where a request for adjournment has been provided to the applicant prior to the

Committee of staff after the issuance of public he	dice.
Committee of Adjustment Comments:	None
Committee of Adjustment Recommended Conditions of Approval:	None

BUILDING STANDARDS (ZONING) COMMENTS	
**See Schedule B for Building Standards (Zoning) Comments	
Building Standards Recommended Conditions of Approval:  None	

DEVELOPMENT PLANNING COMMENTS	
**See Schedule B for Development Planning Comments.	
Development Planning Recommended Conditions of Approval:	TBD

# DEVELOPMENT ENGINEERING COMMENTS

<u>Link to Grading Permit</u> <u>Link to Pool Permit</u> <u>Link to Curb Curt Permit</u> <u>Link Culvert Installation</u>
As the proposed addition to existing residence is 71.57 m² in the subject property, the Owner / Applicant needs to obtain a Lot Grading Permit from Development Inspection and Lot Grading Division of the City's Development Engineering Department. Please note any in-ground structure over 10 m<sup>2</sup> requires a Grading Permit. Please contact the Development Engineering Reviewer after receiving the Grading Permit to clear the condition. (Condition attached)

The proposed work by the Owner / Applicant is increasing the lot coverage on the subject property. The added hardscape may have impacts on the City's Storm Water management system. Development Engineering strongly encourages the Owner / Applicant introduce Low-Impact Development (LID) measures (e.g., bioswales, permeable pavers, rain gardens, rain barrels etc.) to reduce the impacts to the stormwater system. Should further information be required, please contact the Development Engineering COA reviewer.

The Development Engineering Department does not object to the Minor Variance application A046/23, subject to the following condition(s):

# Link to Grading Permit Link to Pool Permit Link to Curb Curt Permit Link Culvert Installation Development Engineering Recommended Conditions of Approval: The Owner / Applicant shall submit the final Lot Grading and/or Servicing Plan to the Development Inspection and Lot Grading Division of the City's Development Engineering Department for final Lot Grading and/or Servicing Permit prior to any work being undertaken on the property. Please visit the Grading Permit page at City of Vaughan website to learn how to apply for the Grading Permit. If you have any questions about Grading Permit, please contact the Development Engineering Department by email at DEPermits@vaughan.ca.

PARKS, FORESTRY & HORTICULTURE (PFH) COMMENTS		
Recommended condition of approval.		
PFH Recommended Conditions of Approval:	Obtain a tree removal/protection permit from the forestry division	

DEVELOPMENT FINANCE COMMENTS		
No comment no concerns		
Development Finance Recommended Conditions of Approval:  None		

BY-LAW AND COMPLIANCE, LICENSING AND PERMIT SERVICES COMMENTS		
No comments received to date.		
BCLPS Recommended Conditions of Approval:  None		

BUILDING INSPECTION (SEPTIC) COMMENTS		
No comments received to date.		
Building Inspection Recommended None Conditions of Approval:		

FIRE DEPARTMENT COMMENTS		
No comments received to date.		
Fire Department Recommended None Conditions of Approval:		

SCHEDULES TO STAFF REPORT  *See Schedule for list of correspondence		
Schedule A	Drawings & Plans Submitted with the Application	
Schedule B	Staff & Agency Comments	
Schedule C (if required)	Correspondence (Received from Public & Applicant)	
Schedule D (if required)	Previous COA Decisions on the Subject Land	

Should the Committee find it appropriate to approve this application in accordance with request and the sketch submitted with the application, as required by Ontario Regulation 200/96, the following conditions have been recommended:

CUMMA DV OF DECOMMENDED CONDITIONS OF A DDDOVAL

	SUMMARY OF RECOMMENDED CONDITIONS OF APPROVAL				
requi the re	All conditions of approval, unless otherwise stated, are considered to be incorporated into the approval "if required". If a condition is no longer required after an approval is final and binding, the condition may be waived by the respective department or agency requesting conditional approval. A condition cannot be waived without written				
conse	consent from the respective department or agency.				
#	DEPARTMENT / AGENCY	CONDITION(S) DESCRIPTION			
1	Development Planning	TBD			
	roberto.simbana@vaughan.ca				
2	Development Engineering	The Owner / Applicant shall submit the final			
	Rex.bondad@vaughan.ca	Lot Grading and/or Servicing Plan to the			
		Development Inspection and Lot Grading			
		Division of the City's Development Engineering			
		Department for final Lot Grading and/or			
		Servicing Permit prior to any work being			

	SUMMARY OF RECOMMENDED CONDITIONS OF APPROVAL				
	All conditions of approval, unless otherwise stated, are considered to be incorporated into the approval "if				
	<b>required</b> ". If a condition is no longer required after an approval is final and binding, the condition may be waived by the respective department or agency requesting conditional approval. A condition cannot be waived without written				
	consent from the respective department or agency.				
	undertaken on the property. Please visit the				
	Grading Permit page at City of Vaughan				
	website to learn how to apply for the Grading				
	Permit. If you have any questions about				
	Grading Permit, please contact the				
	Development Engineering Department by				
	email at DEPermits@vaughan.ca.				
3	Parks, Forestry and Horticulture Operations	Obtain a tree removal/protection permit from			
	zachary.guizzetti@vaughan.ca	the forestry division			

# **IMPORTANT INFORMATION – PLEASE READ**

**CONDITIONS:** It is the responsibility of the owner/applicant and/or authorized agent to obtain and provide a clearance letter from respective department and/or agency (see condition chart above for contact). This letter must be provided to the Secretary-Treasurer to be finalized. All conditions must be cleared prior to the issuance of a Building Permit.

**APPROVALS:** Making any changes to your proposal after a decision has been made may impact the validity of the Committee's decision.

An approval obtained from the Committee of Adjustment, where applicable, is tied to the building envelope shown on the plans and drawings submitted with the application and subject to the variance approval.

A building envelope is defined by the setbacks of the buildings and/or structures shown on the plans and drawings submitted with the application, as required by Ontario Regulation 200/96. Future development outside of an approved building envelope, where a minor variance was obtained, must comply with the provisions of the City's Zoning By-law.

Elevation drawings are provided to reflect the style of roof (i.e. flat, mansard, gable etc.) to which a building height variance has been applied. Where a height variance is approved, building height is applied to the style of roof (as defined in the City's Zoning By-law) shown on the elevation plans submitted with the application.

Architectural design features that are not regulated by the City's Zoning By-law are not to be considered part of an approval unless specified in the Committee's decision.

**DEVELOPMENT CHARGES:** That the payment of the Regional Development Charge, if required, is payable to the City of Vaughan before issuance of a building permit in accordance with the Development Charges Act and the Regional Development Charges By-law in effect at the time of payment.

That the payment of the City Development Charge, if required, is payable to the City of Vaughan before issuance of a building permit in accordance with the Development Charges Act and the City's Development Charges By-law in effect at the time of payment.

That the payment of the Education Development Charge if required, is payable to the City of Vaughan before issuance of a building permit in accordance with the Development Charges Act and the Boards of Education By-laws in effect at the time of payment

That the payment of Special Area Development charge, if required, is payable to the City of Vaughan before issuance of a building permit in accordance with the Development Charges Act and The City's Development Charge By-law in effect at the time of Building permit issuance to the satisfaction of the Reserves/Capital Department.

**NOTICE OF DECISION:** If you wish to be notified of the decision in respect to this application or a related Ontario Land Tribunal (OLT) hearing you must complete a Request for Decision form and submit to the Secretary Treasurer (ask staff for details). In the absence of a written request to be notified of the Committee's decision you will **not** receive notice.

# **SCHEDULE A: DRAWINGS & PLANS**

**NOTIFICATION MAP - A046/23** 

Disclaimer:



Scale: 1: 4,514 0.07 km 



Created By: Infrastructure Delivery Department April 20, 2023 11:45 AM

NAD 83 UTM Zone

# **CONSTRUCTION NOTES**

ALL CONSTRUCTION TO BE CARRIED OUT IN

- THE ONTARIO BUILDING CODE - ALL OTHER APPLICABLE CODES AND REQUIREMENTS OF AUTHORITIES HAVING

## EXCAVATION AND BACKFILL

- 1. EXCAVATION SHALL BE UNDERTAKEN IN SUCH A
- EXCAVATION SHALL BE UNDERTRIKEN IN SUCH A MANIER SO AS TO PREVENT DAMAGE TO EXISTING STRUCTURES, ADJACENT PROPERTY AND UTILITIES. THE TOPSOIL AND VEGETABLE WANTER IN UNEXCAVATED AREAS UNDER A BUILDING SHALL BE REMOVED. THE BOTTOM OF EXCAVATIONS FOR FOUNDATIONS SHALL BE FREE OF ALL ORGANIC MATERIAL
- MATERAL.

  MITERAL

  ITERMITES ARE KNOWN TO EXIST, ALL STUMPS, ROOTS
  AND WOOD DEBRIS SHALL BE REMOVED TO A MINIMUM
  DEPTH OF 300mm (12") IN EXCAVATED AREAS UNDER A
  BUILDING, AND THE CLEARANCE BETWEEN UNTER ATE
  STRUCTURAL WOOD BLEMENTS AND THE GROUND
  SHALL BEN OLESS THAN 450mm (18").

  BACKFILL WITHIN 600mm (24") OF THE FOUNDATION
  WALLS SHALL BE FREE OF DELITERIOUS DEBRIS AND
  BOULDERS OVER 250mm (10") IN DIAMETER.

## DAMPPROOFING AND DRAINAGE

- IN NORMAL SOIL CONDITIONS. THE EXTERIOR SURFACES
- OF FOUNDATION WALLS ENCLOSING BASEMENT SHALL BE DAMPPROCED. WHERE HYDROSTATIC PRESSURE OCCURS, A WATERPROOFING SYSTEM IS REQUIRED. 100mm (47) DIA FOUNDATION DRAINS SHALL BE LAID ON LEVEL, LINDISTURBED GROUND ADJACENT TO THE FOOTINGS AT OR BELOW THE TOP OF THE BASEMENT SHALL BE COVERED WITH CRUSHED STOME. FOUNDATION DRAINS SHALL DRAIN TO STORM WATER FOUNDATION DRAINS SHALL DRAIN TO STORM WATER SEMES
- 3. CONCRETE SLABS IN ATTACHED GARAGES SHALL BE
- CONCRETE SUBJECT TO DRAIN TO THE EXTERIOR.
   INCHED TO DRAIN TO THE EXTERIOR.
   THE BUILDING SITE SHALL BE GRADED SO THAT SURFACE, SUMP AND ROOF DRAINAGE WILL NOT ACCUMULATE AT OR NEAR THE BUILDING AND WILL NOT ADVERSELY AFFECT ADJACENT PROPERTIES.
- AUVERSELT AFFECT ADJACENT PROPERTIES
  DOWNSPOTUS SHALL HAVE EXTENSIONS TO CARRY
  WATER AWAY FROM THE BUILDING, AND PROVISIONS
  SHALL BE MADE TO PREVENT SOIL EROSION.
  MASONRY FOUNDATION WILLS SHALL BE PARGED WITH
  14" OF MORTAR COVED OVER THE FOOTING PRIOR TO
  DAMPBROFORMS
- DAMPPROOFING .
  7. WINDOW WELLS SHALL BE DRAINED TO THE FOOTING

# WOOD FRAME CONSTRUCTION REFER TO STRUCTURAL DRAWINGS

1. ALL LUMBER SHALL BE SPRUCE-PINE-FIR NO. 1 & 2. AND

- SHALL BE IDENTIFIED BY A GRADE STAMI MAXIMUM MOISTURE CONTENT 19% AT TIME OF
- INSTALLATION. INSTALLATION.

  3. WOOD FRAMING MEMBERS WHICH ARE SUPPORTED ON CONCRETE IN DIRECT CONTACT WITH SOIL SHALL BE SEPARATED FROM THE CONCRETE WITH 0.05mm POLYETHYLENE

# CONCRETE SLABS

ALL FILL OTHER THAN COARSE CLEAN MATERIAL PLACED BENEATH CONCRETE SLABS SHALL BE COMPACTED TO PROVIDE UNIFORM SUPPORT.

# FLOORS

# F FLOORS

-19mm (3/4") T&G PLYWOOD SUBFLOOR -FLOOR JOISTS REFER TO ARCH. PLANS -13mm GYPSUM BOARD

UNLESS INDICATED ON STRUCTURAL DRAWINGS.

- 1. HEADER JOISTS BETWEEN 1200mm AND 3200mm IN LENGTH SHALL BE DOUBLED. HEADER JOISTS EXCEEDING 3200mm SHALL BE SIZED BY CALCULATIONS. TRIMMER JOISTS SHALL BE DOUBLED WHEN SUPPORTED HEADER IS BETWEEN 800mm AND 2000mm.
- TRIMMER JOISTS SUPPORTED HEADER EXCEEDS 000mm SHALL BE SIZED BY CALCULATIONS 38X38mm CROSS BRIDGING REQUIRED NOT MORE THAN m FROM EACH SUPPORT AND FROM OTHER ROWS
- 4 JOISTS SHALL BE SUPPORTED ON JOIST HANGERS AT
- JUIST STALL BE SUPPORTED ON JUIST HANGERS AT ALL FLUSH BEAMS, TRIMMERS, AND HEADERS. NON-LOADBEARING PARTITIONS SHALL BE SUPPORTED ON A JOIST OR ON BLOCKING BETWEEN JOISTS.

# GENERAL PARTITION NOTES

- ALL GYPSUM BOARD PARTITIONS ARE DIMENSIONED TO

- 1. ALL GYPSUM BOARD PARTITIONS ARE DIMENSIONED TO ONE FACE UNESS OTHERWISE NOTED.
  2. ALL MASONRY & CONCRETE WALLS ARE DIMENSIONED TO THE FACE OF THE MASONRY OR CONCRETE.
  3. ALL CONCRETE BLOCK (CMU) WALLS EXTEND FULL HEIGHT TO THE UNDERSIDE OF THE STRUCTURE UNLESS OTHERWISE NOTED.
  4. PROVIDE DEFLECTION JOINT AND LATERAL RESTRAINTS AT TOP OF WALLS AS REQUIRED, TYPICAL.
  5. ALL FIRE RATED OR SOUND INSULATED GYPSUM BOARD PARTITIONS EXTEND FULL HEIGHT TO THE UNDERSIDE OF THE STRUCTURE.
  6. GYPSUM BOARD IS TYPICALLY 13mm NOM. (12.7mm ACTUAL) THICKNESS UNLESS OTHERWISE INDICATED.
  FIRE RATED WALL TYPES ARE INDICATED.
  FIRE RATED WALL TYPES ARE INDICATED.
  FIRE RATED WALL TYPES ARE INDICATED. WHERE GWB IS USED IN FIRE RATED WALLS, USE ONLY
- DESIGNATED TYPES PER PARTITION SCHEDULE OF APPROVED EQUALS.
  ALL PERIMETER JOINTS OR PENETRATIONS THROUGH SOUND INSULATED OR FIRE RATED PARTITIONS SHALL
- BE SEALED TO CONFORM TO MANUFACTURER'S RECOMMENDATIONS AND ALL APPLICABLE CODES W.R.T AUTHORITIES HAVING JURISDICTION. GYPSUM BOARD COVERING CONCRETE OR MASONRY
- WALLS SHALL EXTEND TO 100 mm ABOVE THE CELLING LINE, WHERE APPLICABLE.

  10. INSTALL SLIP JOINTS AT TOPS OF ALL WALLS ABUTTING
- STRUCTURE.
- CONTRACTOR TO VERIFY AND PROVIDE STUD SIZES AND STEEL THICKNESS ADEQUATE FOR HEIGHTS OF PARTITIONS, TYPICAL.

  12. ALL PIPE CHASES ARE TO BE ACOUSTICALLY ISOLATED.
- 3. PROVIDE BLOCKING AS REQUIRED, REFER TO
- SPECIFICATIONS SPECIFICATIONS.

  14. EXPOSED CMU WALL TERMINATIONS TO HAVE "BULL"
- 15. USE 16mm IMPACT RESISTANT BOARD IN LIFU OF 16mm GWB WHERE NOTED
- VERIFY ALL VENT SIZES AND LOCATIONS WITH MECHANICAL DRAWINGS. 17 REFER TO SPECIFICATIONS FOR GENERAL CONSTRUCTION REQUIREMENT FOR PARTITION WALLS.

# ROOF

# SLOPE ROOF (R60)

-3-TAP ARCHITECTURAL ASPHALT SHINGLES -13 mm (1/2") PLYWOOD SHEATHING -ENG. ROOF TRUSSES -PROVIDE TWO ROWS OF PEEL AND STICK ICE AND WATER SHIELD ALONG EAVES REMAINDER OF ROOF TO BE PROTECTED W/ NON-PERFORATED #15 ASPHALT ROOFING FEL<sup>®</sup> -ALL VALLEYS TO BE PROTECTED WITH PEEL AND STICK ICE AND WATER SHIELD UNDER PRE-FINISHED METAL VALLEY FLASHING -PRE-ENGINEERED TRUSSES -R60 INSULATION -13mm DRYWALL

- FASTENERS FOR ROOFING SHALL BE CORROSION RESISTANT, ROOFING NAILS SHALL PENETRATE THROUGH OR AT LEAST 13mm (1/2") INTO ROOF 2. EVERY ASPHALT SHINGLE SHALL BE FASTENED WITH AT
- EAST 4 NAILS FOR 1000mm WIDE SHINGLE (OR 6 OR 1mm STAPLES). 3 OPEN VALLEYS SHALL BE FLASHED WITH 2 LAYERS OF
- ROLLING ROOFING, OR 1 LAYER OF SHEET METAL MIN. 600mm (24") WIDE.
  SHEET METAL FLASHING SHALL CONSIST OF NOT LESS
- STEAT INSTALL OF A STEEL O.35mm COPPER 0.35
  ZINC OR 0.48 ALUNINUM.
  ZINC OR 0.48 ALUNINUM.
  ZINC OR 0.48 ALUNINUM.
  ZINC OR 0.49 ALUNINUM.
  ZINC OR 0.49 ALUNINUM.
  ZINC OR 0.49 ALUNINUM.
  ZINC OR 0.49 ALUNINUM.
  ZINC OR 0.40 ALUNINUM.
  Z

# NOTCHING & DRILLING OF TRUSSES, JOIST AND RAFTERS

- HOLES IN FLOOR, ROOF AND CEILING MEMBERS TO BE NOT LARGER THAN 1/4 THE ACTUAL DEPTH OF MEMBER AND NOT LESS THAN 50mm (2") FROM EDGES. NOTCHES IN FLOOR, ROOF AND CEILING MEMBERS TO
- BE LOCATED ON TOP OF THE MEMBER WITHIN ACTUAL THE 1/2 DEPTH FROM THE EDGE OF BEARING AND NOT GREATER THAN 1/3 THE JOIST DEPTH.
  WALL STUDS MAY BE NOTCHED OR DRILLED PROVIDED
- THAT NO LESS THAN 2/3 THE DEPTH OF THE STUD REMAINS F LOAD BEARING, AND 40mm IF NON-LOAD BEARING. ROOF TRUSS MEMBERS SHALL NOT BE NOTCHED,
- DRILLED OR WEAKENED UNLESS ACCOMMODATED IN

# COLUMNS, BEAMS AND LINTELS

REFER TO STRUCTURAL DRAWINGS

# STAIRS, HANDRAILS AND GUARDS

- A. INTERIOR AND EXTERIOR STAIRS MAXIMUM RISE 200mm (7-7/8")
   MINIMUM RUN 210mm (8-1/4") MINIMUM TREAD 235mm (9-1/4" MAXIMUM NOSING 25mm (1") MIN. RUN 150mm (6")
- MIN. AVERAGE RUN 200mm (7-7/8") B. STAIR WIDTH:
- -INTERIOR: 860mm (2'-10") BTW. WALL FACES. -EXTERIOR: 900mm (3'-0") BTW. WALL FACES. L LANDINGS AS WIDE AND LONG AS WIDTH OF STAIRS. HEAD ROOM:
- -INTERIOR 1950mm (6'-5") MINIMUM -EXTERIOR 2050mm (6'-9") MINIMUM
- 1. CURVED STAIRS SHALL HAVE A MIN. RUN OF 150mm (6") AT ANY POINT AND A MINIMUM AVERAGE RUN OF 200mn
- WINDERS WHICH CONVERGE TO A POINT IN STAIRS MUST TURN THROUGH AN ANGLE OF NO MORE THAN 90°, WITH NO LESS THAN 30° OR MORE THAN 45° PER TREAD. SETS OF WINDERS MUST BE SEPARATED BY 3 11" ALONG THE RUN OF THE STAIR. A LANDING MINIMUM 900mm (2'-11") IN LENGTH IS AT THE
- TOP OF ANY STAIR LEADING TO THE PRINCIPAL REQUIRED ENTRANCE TO A DWELLING, AND OTHER ENTRANCES WITH MORE THAN 3 RISERS
- EXTERIOR CONCRETE STAIRS WITH MORE THAN 2

# HANDRAILS AND GUARDS

-32" MIN. AND 36" MAX. ABOVE NOSING.

B. GUARDS: FINISHED NON-CLIMBABLE GUARD 100mm-890mm (4"-35") ABOVE FINISHED FLOOR W/ 100mm (4") MAXIMUM SPACING BTW. PICKETS. -INTERIOR: MIN. 900mm (36") HIGH AROUND LANDINGS AND FLOOR AREAS OF MORE THAN TWO RISERS. -EXTERIOR: MIN. 1050mm (42") HIGH WHEN

- LEVEL DIFFERENCE > 1800mm (6'-0") MIN. 900mm (36") HIGH WHEN LEVEL DIFFERENCE > 1800mm (6'-0") A HANDRAIL IS REQUIRED FOR INTERIOR STAIRS
- CONTAINING MORE THAN 2 RISERS AND EXTERIOR STAIRS CONTAINING MORE THAN 3 RISERS. GUARDS ARE REQUIRED AROUND EVERY ACCESSIBLE SURFACE WHICH IS MORE THAN 600mm (2') ABOVE THE

# RAMPS

MAXIMUM SLOPE FOR PEDESTRIAN RAMP 1:10

ADJACENT LEVEL.

# INSULATION & WEATHERPROFING

CEILING WITH ATTIC SPACE ROOF WITHOUT ATTIC SPACE EXTERIOR WALL (NEW) BASEMENT WALL EXPOSED FLOOR SLABS ON GRADE (HEATED OR </= 600mm (24") BELOW GRADE) WINDOW AND SLIDING GLASS DOORS 0.28 (U-VALUE) SUPPLY DUCTS IN UNHEATED SPACE R12

- 1 INSULATION SHALL BE PROTECTED WITH GYPSLIM BOARD OR AN FOLITIVALENT INTERIOR FINISH EXCEPT FOR LINEINISHED BASEMENTS WHERE 0.15mm POLY IS SUFFICIENT FOR FIRREGLASS TYPE INSULATIONS
- MADE AIRTIGHT WITH TAPE OR SEALANT.
  CAULKING SHALL BE PROVIDED FOR ALL EXTERIOR
  DOORS AND WINDOWS BETWEEN THE FRAME AND THE
  EXTERIOR CLADDING DUCTS PASSING THROUGH UNHEATED SPACE SHALL BE
- EXTERIOR CLADDING.
  WEATHERSTRIPPING SHALL BE PROVIDED ON ALL DOORS AND ACCESS HATCHES TO THE EXTERIOR. EXCEPT DOORS FROM A GARAGE TO THE EXTERIOR EXTERIOR MALL. SCILINGS AND FLOORS SHALL BE CONSTRUCTED SO AS TO PROVIDE A CONTINUOUS BARRIER TO THE PASSAGE OF WATER VAPOUR FROM THE INTERIOR AND TO THE LEAKAGE OF AIR FROM THE EXTERIOR.
- EXTERIOR.

  EXTERIOR HOUSE DOORS AND WINDOWS WITHIN 6' 7"
  FROM GRADE SHALL BE CONSTRUCTED TO RESIST
  FORCED ENTRY. DOORS SHALL HAVE A DEADBOLT
- LOCK.
  THE PRINCIPAL ENTRY DOOR SHALL HAVE EITHER A
  DOOR VIEWER, TRANSPARENT GLAZING OR A SIDELIGHT.

# ACCESS TO ATTIC SAPCE AND CRAWL SPACE

- ACCESS HATCH MIN. 545 X 588mm TO BE PROVIDED TO EVERY ROOF SPACE WHICH IS 10 SQM OR MORE IN AREA
  - AND MORE THAN 600mm IN HEIGHT.
    ACCESS HATCH MINIMUM 500 X 700mm TO BE PROVIDED O EVERY CRAWL SPACE.

# CAULKING AND SEALING

THE WALLS AND CEILING OF AN ATTACHED GARAGE SHALL BE CONSTRUCTED AND SEALED SO AS TO PROVIDE AN EFFECTIVE BARRIER TO EXHAUST FUNGS. ALL PLUMBING AND OTHER PROTESTATIONS THROUGH THE WALLS AND CEILING SHALL BE CAULKED.

DOWN SETWEEN THE OWNELLING AND ATTACHED GARAGE MAY NOT OPEN INTO A BEDROOM AND SHALL BE WEATHERSTRIPPED AND HAVE A SELF-CLOSER.

# SMOKE ALARM AND CARBON MONOXIDE DETECTOR

- . AT LEAST ONE SMOKE ALARM SHALL BE INSTALLED ON OR NEAR THE CEILING ON EACH FLOOR AND BASEME LEVEL 900mm OR MORE ABOVE AN ADJACENT LEVEL. SMOKE ALARMS SHALL BE INTERCONNECTED AND LOCATED SUCH THAT ONE IS WITHIN 5mm OF EVERY BEDROOM DOOR AND NO MORE THAN 15M TRAVEL DISTANCE FROM ANY POINT ON A FLOOR.
- A CARBON MONOXIDE DETECTOR SHALL BE INSTALLED ADJACENT TO EVERY SLEEPING AREA FOR DWELLINGS WITH FUEL BURNING FIREPLACE OR STOVE, OR AN

# NATURAL VENTILATION

- 1. EVERY ROOF SPACE ABOVE AN INSULATED CEILING SHALL BE VENTILATED WITH UNOBSTRUCTED OPENINGS EQUAL TO NOT LESS THAN 1/300 OF THE INSULATED
- CEILING AREA.
  2. INSULATED ROOF SPACES NOT INCORPORATING AN ATTIC SHALL BE VENTILATED WITH UNOBSTRUCTED OPENINGS EQUAL TO NOT LESS THAN 1/150 OF THE
- INSULATED CEILING AREA.
  3. ROOF VENTS SHALL BE UNIFORMLY DISTRIBUTED WITH MIN. 25% AT TOP OF THE SPACE AND 25% AT BOTTOM OF THE SPACE DESIGNED TO PREVENT THE ENTRY OF RAIN, SNOW OR INSECTS.
  UNHEATED CRAWL SPACES SHALL BE PROVIDED WITH
- 0.1 SQM OF VENTILATION FOR EACH 50 SQM.
  5. MINIMUM NATURAL VENTILATION AREAS, WHERE MECHANICAL VENTILATION IS NOT PROVIDED. ARE OTHER ROOMS: 0.09 SQM (1SF) OTHER ROOMS: 0.28 SQM (3SF)
  UNFINISHED BASEMENT: 0.2% OF FLOOR AREA

# PLUMBING

- A FLOOR DRAIN SHALL BE INSTALLED IN THE BASEMENT, AND CONNECTED TO THE SANITARY SEWER WHERE GRAVITY DRAINAGE IS POSSIBLE. IN OTHER CASES, IT SHALL BE CONNECTED TO A SEWAGE EJECTION PUMP

# ELECTRICAL

- 1. AN EXTERIOR LIGHT CONTROLLED BY AN INTERIOR SWITCH IS REQUIRED AT EVERY ENTRANCE.
- A LIGHT CONTROLLED BY A SWITCH IS REQUIRED IN EVERY KITCHEN, BEDROOM, LIVING ROOM, UTILITY ROOM, LAUNDRY ROOM, DINING ROOM, BATHROOM, VESTIBULE, HALLWAY, GARAGE AND CARPORT, A SWITCHED RECEPTACLE MAY BE PROVIDED INSTEAD OF A LIGHT IN BEDROOMS AND LIVING ROOMS
- STAIRS SHALL BE LIGHTED, AND EXCEPT WHERE SERVING AN UNFINISHED BASEMENT SHALL BE CONTROLLED BY A 3 WAY SWITCH AT THE HEAD AND FOOT OF THE STAIRS
- 4 BASEMENTS REQUIRE A LIGHT FOR EACH 30 SOM CONTROLLED BY A SWITCH AT THE HEAD OF THE

# MECHANICAL VENTILATION

- 1 A MECHANICAL VENTILATION SYSTEM IS REQUIRED WITH A MECHANICAL VENTILATION 791EM IS REQUIRED WITH A TOTAL CAPACITY AT LEAST EQUAL TO THE SUM OF 10.0 US EACH FOR BASEMENT AND MASTER BEDROOM 5.0 LIS FOR EACH OTHER ROOM. A PRINCIPAL DWELLING EXHAUST FAN SHALL BE
- A PRINCIPAL DWELLING ENHAUST FAN SHALL BE INSTALLED AND CONTROLLED BY A CENTRALLY LOCATED SWITCH IDENTIFIED AS SUCH.

  SUPPLEMENTAL EXHAUST SHALL BE INSTALLED SO THAT THE TOTAL CAPACITY OF ALL KITCHEN, BATHROOM AND OTHER EXHAUSTS, LESS THE PRINCIPAL EXHAUSTS, IS NOT OTHER EXHAUSTS, LESS THE PRINCIPAL EXHAUSTS, IS NOT LESS THAN THE TOTAL REQUIRED CAPACITY.

  A HEAT RECOVERTY VENTLATOR MAY BE EMPLOYED IN LIEU OF EXHAUST TO PROVIDE VENTILATION. AN HRV IS REQUIRED IF ANY SOLD FUEL BURNING APPLIANCES ARE INSTALLED.

  SUPPLY AIR INTAKES SHALL BE LOCATED SO AS TO AVOID CONTAINMENT OF MOMENTAINSTON (EVENT).

# **GENERAL NOTES**

## A GENERAL

- 1. READ ARCHITECTURAL DRAWINGS IN CONJUNCTION WITH MECHANICAL DRAWINGS AND OTHER CONTRACT DOCUMENTS AS PROVIDED. READ ARCHITECT UPON LOWERINGS IN CONSIDERATION IN INCLINING AND ANALYMINES AND THE CONTRACT DOCUMENTS AND ATVICED.

  PROTECT EXISTING BUILDINGS, TREES, FENCING, UTILITY POLES, CABLES, ACTIVE UNDERGROUND SERVICES AND PAYANG ON THE SITE OR ANY ADJOINING PROPERTIES FROM MAGGE, ANY DAMAGE, AS WILLING FROM THIS CONSTRUCTION WORK SHALL BE MADE GOOD TO THE APPROVAL OF THE
- PRIOR TO CONSTRUCTION LOCATE AND NOTE EXISTING SERVICES AND EXISTING FACILITIES.

## B. REFERENCE STANDARDS.

- ONTARIO BUILDING CODE 2012.
- OMITATIO BUILDING CODE 2012.
  ALL CSA CODES AND ASTM STANDARDS REFERENCED BELOW REFER TO THOSE EDITIONS AND REVISIONS OF CODES/ STANDARDS. REFERENCED IN ONTARIO BUILDING CODE 2006.
- REFERENCED IN ONLARIO GUILDING CODE 2006.

  COMPLY WITH LOCAL BY-LAWS, CANADIAN CONSTRUCTION SAFETY CODE AND ALL REGULATIONS SET BY AUTHORITIES HAVING JURISDICTION. IN CASE OF CONFLICT OR DISCREPANCY, THE MORE STRINGENT REQUIREMENTS SHALL APPLY.

- NO SUBSTITUTIONS ARE PERMITTED
- NO SUBSTITUTIONS ARE PERMITTED. IN THE SPECIFIED PRODUCT, SUBJECT TO WRITTEN PERMISSION OBTAINED FROM ARCHITECTIENGINEER. CONTRACTOR ENSURES THAT SUBSTITUTIONS CAN BE BOTH PHYSICALLY AND DIMENSIONALLY INCORPORATED IN THE WORK WITH NO LOSS OF INTENDED PLUNCTION OR CONSTRUCTION TIME AND AT NO ADDITIONAL COST TO THE OWNER.
- THE CONTRACTOR REIMBURSES ALL PARTIES FOR ADDITIONAL TIME COSTS INVOLVED IN EXECUTING THE REVISIONS IN RECORD.

- 1. ALL CONCRETE MEMBERS ARE DESIGNED IN ACCORDANCE WITH A23.3 "CODE FOR THE DESIGN OF CONCRETE STRUCTURES FOR

- ALL CONCRETE WINDERD AND EXECUTIONED IN ALCORDANCE WITH AZES CODE FOR THE DESIGN OF CONCRETE STRUCTURES FOR BUILDINGS' USING LIMIT STATE DESIGN.
  ALL DESIGN LOADINGS GIVEN ON THE DRAWINGS ARE SPECIFIED WORKING LOADS.
  ALL EXPOSED METALWORK IS TO BE ETHER GALVANIZED OR STAINLESS STEEL OR DURABLE NON-FERROUS UNLESS SPECIFIED OTHERWISE.
  THE EXPOSED ENDS OF CUT GALVANIZED MATERIALS ARE TO BE PROPERLY TREATED TO PREVENT OXIDATION, DETERIORATION OR STAINING.

# E. EXISTING CONDITIONS, DEMOLITION, FOUNDATIONS AND RELATED WORK:

- 1. NOTIFY SPECIFIED DESIGN CONSULTANT IN ADVANCE OF THE TIME OF COMMENCEMENT OF EXCAVATION/DEMOLITION FOR HIS ATTENDANCE
- AND REVIEW.


  EXPOSED SURFACES OF REMOVED AREA TO BE DRY UNDISTURBED MATERIAL, LEVEL, FREE FROM LOOSE OR ORGANIC MATTER.
  PROTECT BOTTOMS OF EXPOSED AREAS FROM SOFTENING, DETERIORATION OR DEGRADATION DUE TO EXPOSURE OR OTHER
  CONSTRUCTION. TEMPORABILY PROTECT ALL EXPOSED ROOF AREAS AND ADJACENT STRUCTURES. PROTECT EXTG AND NEW CONSTRUCTION FROM FREEZING. BEFORE PLACING CONCRETE FOR FOUNDATIONS, OBTAIN APPROVAL FROM PROFESSIONAL STRUCTURAL ENGINEER, CONSULT AND NOTIFY OF CONSTRUCTION SCHEDULING:

# F. TEMPORARY WORK:

- PROVIDE ALL ADEQUATE SHORING FOR THE SAFE COMPLETION OF THE WORK
- ASSUME RESPONSIBILITY TO DESIGN AS WELL AS TO ERECT, MAINTAIN AND EVENTUALLY REMOVE ALL THE TEMPORARY WORKS NECESSARY FOR CARRYING OUT OF THIS CONTRACT.
- PROVIDE ALL TEMPORARY SIGNAGE AND TEMPORARY FIRE WATCH AS REQUIRED.

# ADDITIONAL NOTES

- PROVISION OF SAFE ACCESS TO THE BUILDING WITH APPROPRIATE PROTECTION TO ALLOW SAFE PUBLIC ACCESS TO ALL ENTRANCES;
- PROTECT ADJACENT AND ABUTTING BUILDINGS OUTSIDE THE PRESCRIBED SCOPE OF WORK FROM DAMAGE, DUST AND DISTURBANCE; REMOVE ALL EXISTING CONTENTS, WASTE, DEMOLISHED MATERIALS AND RUBBISH FROM SITE AND DISPOSE OF AT LEGAL DUMPING SITES;
- PAY ALL DISPOSAL COSTS; AND MAINTAIN A CLEAN AND SAFE SITE PRE-, DURING AND POST-CONSTRUCTION.

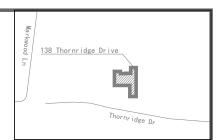

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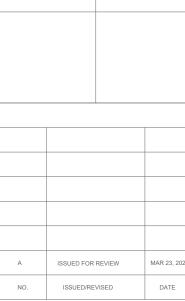
CONTRACTOR MUST CHECK & VERIFY ALL DIMENSIONS ON SITE.



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Owner & Address

138 Thornridge Dr. Thornhill, ONTARIO

Drawing Title

# NOTES

DES18-06-03A

J.H

FF

Checked by

Drawing No

MAR 23, 2023

A0.0



# Received

March 29, 2023

# **BENCHMARK NOTE:**

REGIONAL MUNICIPALITY OF YORK

ELEVATIONS ARE GEODETIC AND REFERRED TO CITY OF VAUGHAN BENCHMARK No - 2 - 6 HAVING AN ELEVATION

# METRIC:

DISTANCES SHOWN ON THIS PLAN ARE IN METRES AND CAN BE CONVERTED TO FEET BY DIVIDING BY 0.3048

THIS IS NOT A PLAN OF SURVEY THE BOUDARY INFORMATION ARE COMPILED FROM VARIOUS SOURCES AND SHALL NOT BE USED FOR MORTGAGE OR TRANSACTION PURPOSES

# **UNDERGROUND SERVICES:**

THE LOCATION OF UNDERGROUND SERVICES SHOWN ON THIS PLAN IS ONLY APPROXIMATE MUST NOT BE ASSUMED TO BE COMPLETE OR UP-TO-DATE. THE UNDERNAMED COMPANY AND EACH UTILITY ACCEPTS NO RESPONSIBILITY FOR ANY CLAIMS OR LOSSES DUE TO IMPROPER USE OF THE INFOMATION SHOWN HEREON AND EACH UTILITY MUST BE CONTACTED FOR AN ON-SITE LOCATE PRIOR TO ANY EXCAVATION.

- ALL FOOTING FORMWORK ELEVATION ARE TO BE CONFIRMED BY A REGISTERED PROFESSIONAL ENGINEER OR A REGISTERED ONTARIO LAND SURVEYOR PRIOR TO THE PLACING OF ANY CONCRETE.


  PRIOR TO THE SUPERSTRUCTURE WORKS PROCEEDING AND THE RELEASE CERTIFY THAT THE TOP OF FOUNDATIONS IS IN CONFORMITY WITH THE GRADING PLAN REVIEWEDBY THE CITY.
- 3. ALL RAINWATER LEADERS TO DISCHARGE ONTO SPLASH PADS AT GROUND LEVEL AT FRONT OF HOUSE

Soakaway pit detail

2% Min/ 5% Max

Grade


# LEGEND:

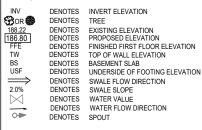

100mm Ø RIVER ROCK @200mm Min DEPTH

50mm Ø STONE @500mm APPROX. DE 20mm Ø GRAVEL @800mm APPROX. DEF



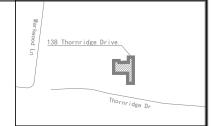

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CONSTRUCTION TRUE NORTH NORTH





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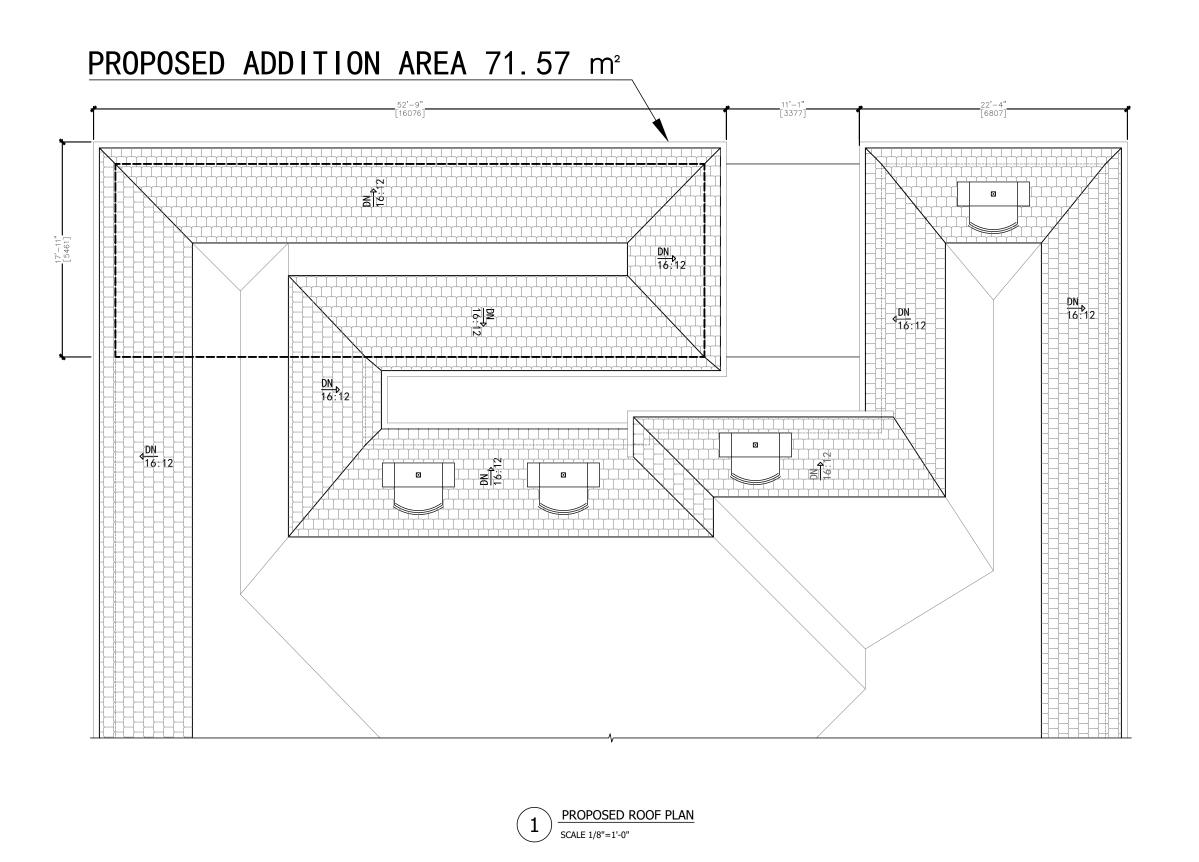
138 Thornridge Dr. Thornhill, ONTARIO


# LOT GRADING PLAN

DES18-06-03A FF MAR 29, 2023

A1.0

Drawing No



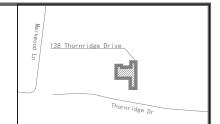

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NORTH

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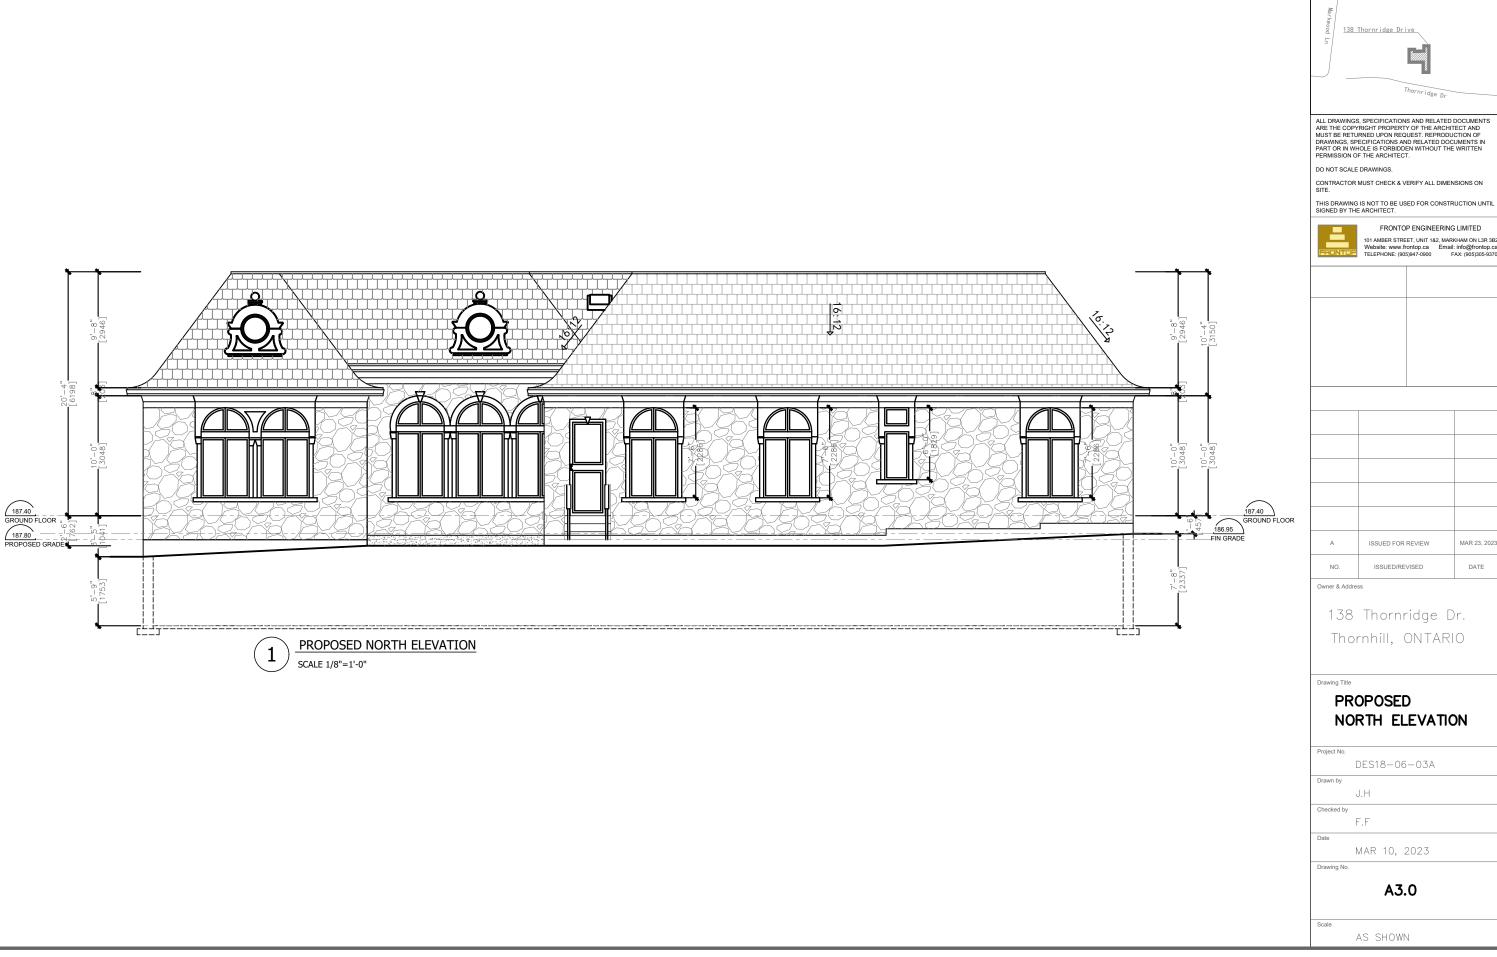
# **PROPOSED ROOF PLAN**

DES18-06-03A

F.F


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MAR 23, 202 DATE

Thornhill, ONTARIO



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Drawing Title

# PROPOSED WEST ELEVATION
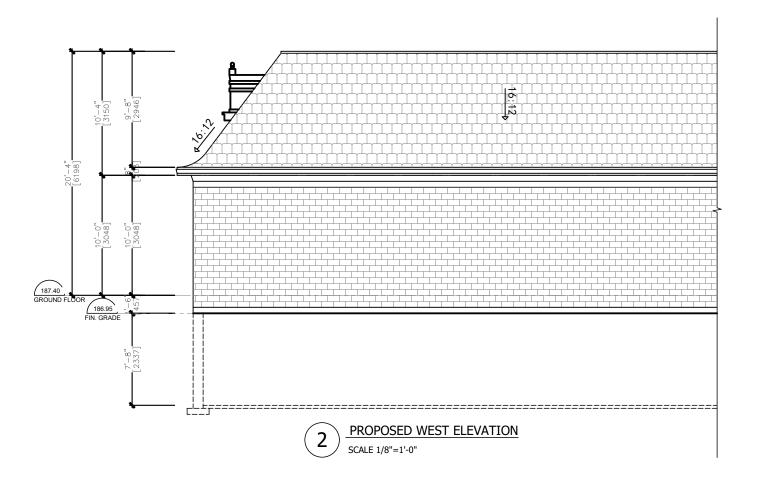
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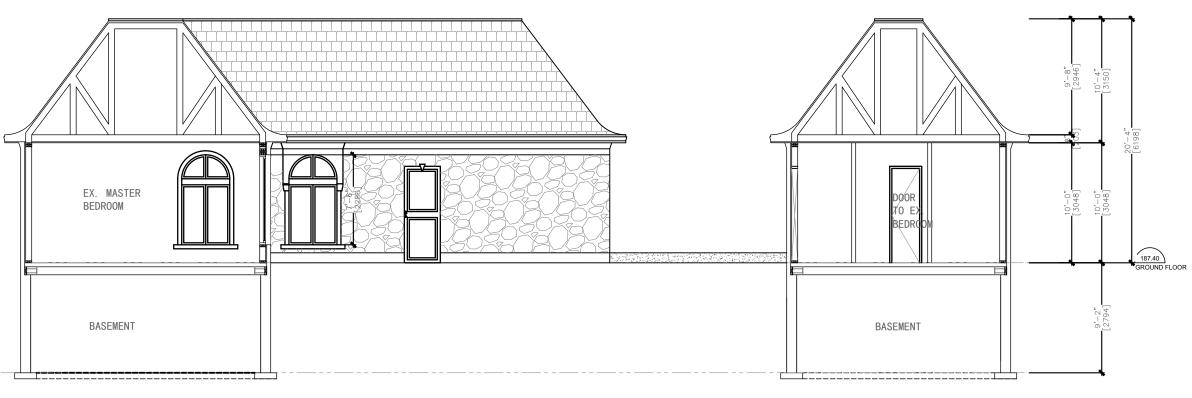
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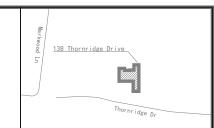
MAR 10, 2023

Drawing No.

A3.1



SECTION 1-1 SCALE 1/8"=1'-0"



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# **PROPOSED** SECTION

DES18-06-03A


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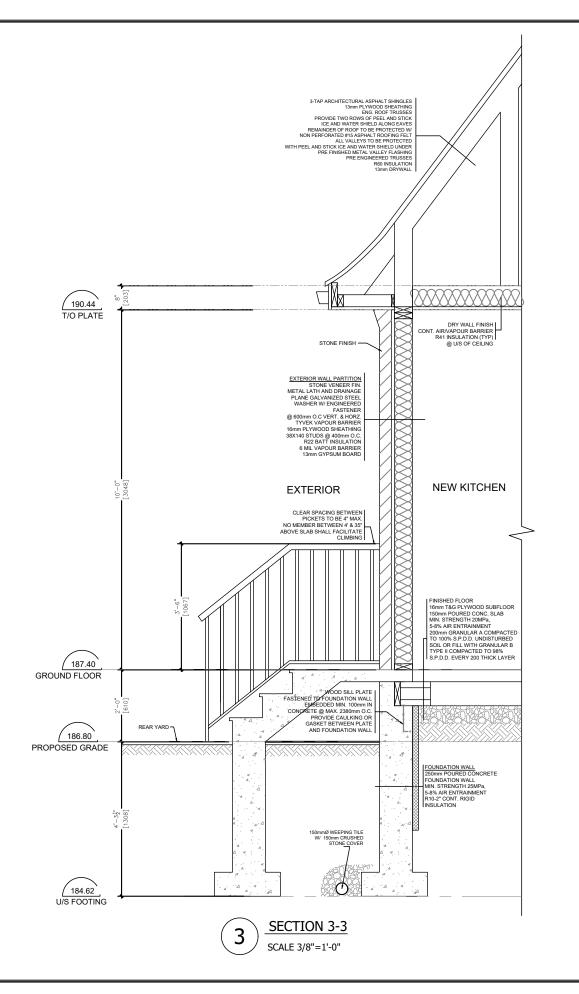
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NO. ISSUED/REVISED DATE

Owner & Addre

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PROPOSED
SECTION AND
SECTION DETAIL

Project No.

DES18-06-03A

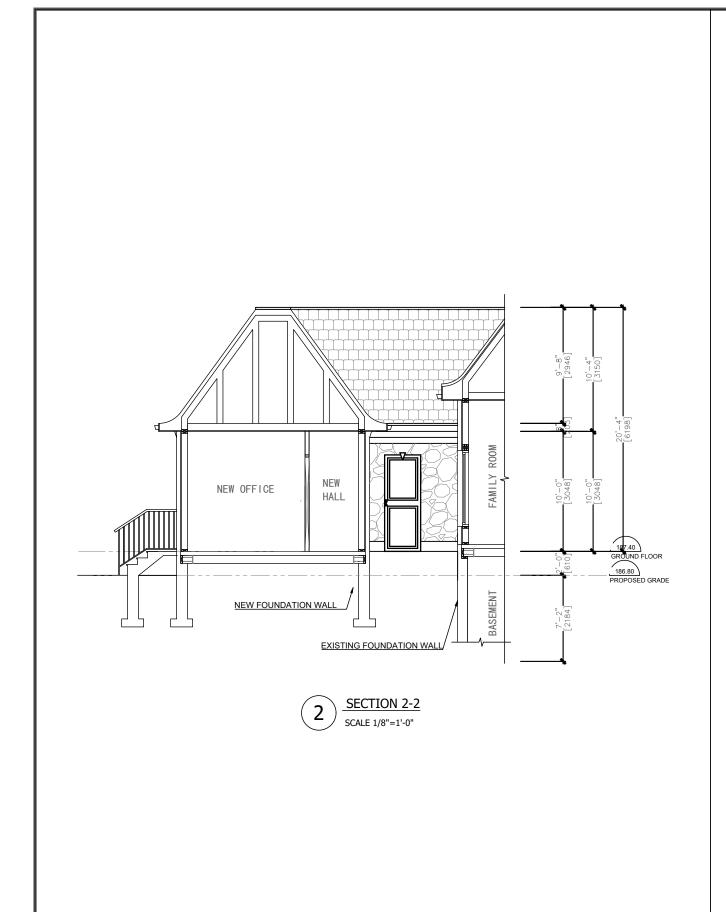Drawn by

Checked by

F.F

MAR 10, 2023

Drawing No.

A4.1

Sca

SCHEDULE B: STAFF & AGENCY COMMENTS				
DEPT/AGENCY	Circulated	Comments Received	Conditions	Nature of Comments
TRCA *Schedule B	Х			No Comments Received to Date
Ministry of Transportation (MTO) *Schedule B				No Comments Received to Date
Region of York *Schedule B	Х	Х		General Comments
Alectra *Schedule B	Х	X		General Comments
Bell Canada *Schedule B	Х			No Comments Received to Date
YRDSB *Schedule B				
YCDSB *Schedule B				
CN Rail *Schedule B				
CP Rail *Schedule B				
TransCanada Pipeline *Schedule B	Х			No Comments Received to Date
Metrolinx *Schedule B				
Propane Operator *Schedule B				
Development Planning	Х			Application Under Review
Building Standards (Zoning)	Х	Х		General Comments



Date: April 14<sup>th</sup> 2023

Attention: Christine Vigneault

**RE:** Request for Comments

File No.: A046-23

**Related Files:** 

Applicant Liangyan Shui

**Location** 138 Thornridge Drive



# **COMMENTS:**

	We have reviewed the proposed Variance Application and have no comments or objections to its approval.
X	We have reviewed the proposed Variance Application and have no objections to its approval, subject to the following comments (attached below).
	We have reviewed the proposed Variance Application and have the following concerns (attached below).

Alectra Utilities (formerly PowerStream) has received and reviewed the proposed Variance Application. This review, however, does not imply any approval of the project or plan.

All proposed billboards, signs, and other structures associated with the project or plan must maintain minimum clearances to the existing overhead or underground electrical distribution system as specified by the applicable standards, codes and acts referenced.

In the event that construction commences, and the clearance between any component of the work/structure and the adjacent existing overhead and underground electrical distribution system violates the Occupational Health and Safety Act, the customer will be responsible for 100% of the costs associated with Alectra making the work area safe. All construction work will be required to stop until the safe limits of approach can be established.

In the event construction is completed, and the clearance between the constructed structure and the adjacent existing overhead and underground electrical distribution system violates the any of applicable standards, acts or codes referenced, the customer will be responsible for 100% of Alectra's cost for any relocation work.

# References:

- Ontario Electrical Safety Code, latest edition (Clearance of Conductors from Buildings)
- Ontario Health and Safety Act, latest edition (Construction Protection)
- Ontario Building Code, latest edition (Clearance to Buildings)
- PowerStream (Construction Standard 03-1, 03-4), attached
- Canadian Standards Association, latest edition (Basic Clearances)

If more information is required, please contact either of the following:

Mr. Stephen Cranley, C.E.T

Supervisor, Distribution Design, ICI & Layouts (North)

**Phone**: 1-877-963-6900 ext. 31297

**E-mail**: stephen.cranley@alectrautilities.com

Mitchell Penner

Supervisor, Distribution Design-Subdivisions

**Phone**: 416-302-6215

**Email:** Mitchell.Penner@alectrautilities.com



Power Stream 1

# Construction Standard

03-1

	SYSTEM VOLTAGE			
LOCATION OF WIRES, CABLES OR CONDUCTORS	SPAN GUYS AND COMMUNICATIONS WIRES		4.16/2.4kV TO 27.6/16kV (SEE NOTE 1)	44kV
	MINIMUM	VERTICAL CLEA	ARANCES (SEE	NOTE 2)
OVER OR ALONGSIDE ROADS, DRIVEWAYS OR LANDS ACCESSIBLE TO <u>VEHICLES</u>	442cm	442cm	480cm	520cm
OVER GROUND ACCESSIBLE TO PEDESTRIANS AND BICYCLES ONLY	250cm	310cm	340cm	370cm
ABOVE TOP OF RAIL AT RAILWAY CROSSINGS	730cm	730cm	760cm	810cm



MINIMUM ATTACHMENT HEIGHT = MAXIMUM SAG

- + MINIMUM VERTICAL CLEARANCE (FROM ABOVE TABLE)
  ± GRADE DIFFERENCE

- + 0.3m (VEHICLE OR RAILWAY LOCATION) + SNOW DEPTH (PEDESTRIAN LOCATION, SEE NOTE 3)

# NOTES:

- THE MULTIGROUNDED SYSTEM NEUTRAL HAS THE SAME CLEARANCE AS THE 600V SYSTEM.
- 2. THE VERTICAL CLEARANCES IN THE ABOVE TABLE ARE UNDER  $\underline{\text{MAXIMUM SAG}}$  CONDITIONS.
- 3. REFER TO CSA STANDARD C22.3 No.1, ANNEX D FOR LOCAL SNOW DEPTH
- 4. ALL CLEARANCES ARE IN ACCORDANCE TO CSA STANDARD C22.3.

<u>\G</u>	340cm	11'-4"		
	310cm	10'-4"		
VALUES.	250cm	8'-4"		
VALUES.				
REFERENCES				
SAGS AND	FNSIONS 1	SECTION 02		

METRIC

810cm

760cm 730cm

520cm 480cm

442cm 370cm

CONVERSION TABLE

IMPERIAL (APPROX)

27'-0" 25'-4"

24'-4" 17'-4"

15'-5" 12'-4"

# MINIMUM VERTICAL CLEARANCES OF WIRES, CABLES AND CONDUCTORS ABOVE GROUND OR RAILS

ORIGINAL ISSUE DATE: 2010-DEC-24 REVISION NO: R1 REVISION DATE: 2012-JAN-09

Certificate of Approval This construction Standard meets the safety requirements of Section 4 of Regulation 22/04			
Joe Crozier, P.Eng. 2012-JAN-09 Name Date			
P.Fng. Approval By: Joe Crozier			



# Construction Standard

03 - 4





VOLTAGE	MINIMUM HORIZONTAL CLEARNACE UNDER MAXIMUM SWING CONDITIONS DIMENSION "X" (SEE NOTES 1, 3 & 4)	MINIMUM VERTICAL CLEARANCE UNDER MAXIMUM DESIGN SAG CONDITIONS DIMENSION "Y" (SEE NOTES 1, 2, 4 & 5)
0-600V AND NEUTRAL	100cm	250cm
4.16/2.4 TO 44kV	300cm	480cm

# NOTES

- UNDER NO CIRCUMSTANCES SHALL A CONDUCTOR BE PERMITTED TO PENETRATE THE ENVELOPE SHOWN BY THE DOTTED LINE.
- 2. THE VERTICAL CLEARANCES ARE UNDER CONDITIONS OF MAXIMUM DESIGN SAG.
- THE HORIZONTAL CLEARANCES ARE UNDER CONDITIONS OF MAXIMUM SWING. WHERE THE CONDUCTOR SWING IS NOT KNOWN A HORIZONTAL CLEARANCE OF 480CM SHALL BE USED.
- 4. BUILDINGS THAT EXCEED 3 STOREYS OR 15M IN HEIGHT, THE MINIMUM HORIZONTAL CLEARANCE OF THE SECONDARY CONDUCTORS SHOULD BE INCREASED TO 300cm WHERE IT IS NECESSARY TO ALLOW FOR THE RAISING OF LADDERS BY LOCAL FIRE DEPARTMENTS.
- IN SITUATIONS SUCH AS MULTI-LEVEL GARAGES, WHERE ROOFS ARE NORMALLY USED BY PERSONS AND VEHICLES, THE VERTICAL CLEARANCES OF POWERSTREAM STANDARD 03-1 SHALL APPLY.
- 6. DISTRIBUTION LINES CONSTRUCTED NEAR BUILDINGS SHALL BE BUILT TO AVOID OVERHANG WHEREVER POSSIBLE. WHERE LINES MUST BE CONSTRUCTED OVER OR ADJACENT TO BUILDINGS THE APPLICABLE HORIZONTAL AND VERTICAL CLEARANCES SHALL BE AT CONDITIONS OF MAXIMUM CONDUCTOR SWING AND MAXIMUM SAG. THE ABOVE CLEARANCES ARE DESIGNED TO PREVENT PERSONS ON OR IN BUILDINGS AS WELL AS EXTERNAL MACHINERY USED IN CONJUCTION WITH A BUILDING TO COME IN CONTACT WITH CONDUCTORS. EFFORTS SHOULD BE MADE TO INCREASE THESE CLEARANCES WHERE POSSIBLE.
- 7. ALL CLEARANCES ARE IN ACCORDANCE TO CSA C22.3 NO.1-06 (TABLE-9).

CONVERSION TABLE		
IMPERIAL		
(APPROX)		
16'-0"		
10'-0"		
8'-4"		
3'-4"		

# MINIMUM VERTICAL & HORIZONTAL CLEARANCES OF CONDUCTORS FROM BUILDINGS OR OTHER PERMANENT STRUCTURES (CONDUCTORS NOT ATTACHED TO BUILDINGS)

ORIGINAL ISSUE DATE: 2010—MAY—05 REVISION NO: REVISION DATE:
PEgystem Planning and Standards/Standard Design/PowerStream Standards/working (abbr/Scellan 3/3-4/c/wg d3-4 Ro May 5, 2010, dwg, %/3/2010 8/2/202 AM, Adobe POF



To: Committee of Adjustment

From: Punya Marahatta, Building Standards Department

**Date:** April 03, 2023

Applicant: Liangyan Shui

**Location:** 138 Thornridge Drive, Thornhill

PLAN RP4061 Lot 41

**File No.(s):** A046/23

# Zoning Classification:

The subject lands are zoned R1E(EN) – First Density Residential Zone (Established Neighbourhood) and subject to the provisions of Exception 14.403 under Zoning By-law 001-2021, as amended.

#	Zoning By-law 001-2021	Variance requested
1	The maximum permitted lot coverage is 23%.	To permit a maximum lot
	[Section 7.2.2. Table 7-3, Footnote (2)]	coverage of 25.86%.

# **Staff Comments:**

# Stop Work Order(s) and Order(s) to Comply:

There are no outstanding Orders on file

# **Building Permit(s) Issued:**

A Building Permit has not been issued. The Ontario Building Code requires a building permit for structures that exceed  $10 m^2$ .

# **Other Comments:**

General Comments		
1	The applicant shall be advised that additional variances may be required upon review of detailed	
	drawing for building permit/site plan approval.	
2	This has been reviewed as a single dwelling unit only. Further zoning review and a separate	
	building permit would be required for a secondary suite.	

# **Conditions of Approval:**

If the committee finds merit in the application, the following conditions of approval are recommended.

<sup>\*</sup> Comments are based on the review of documentation supplied with this application.

From: Development Services
To: Christine Vigneault
Cc: Committee of Adjustment

Subject: [External] RE: A046/23 (138 Thornridge Drive) - REQUEST FOR COMMENTS, CITY OF VAUGHAN

**Date:** Wednesday, April 19, 2023 5:58:00 PM

Attachments: <u>image001.png</u>

image003.png

Hi Christine,

The Regional Municipality of York has completed its review of the above minor variance and has no comment.

Many thanks,

Our working hours may be different. Please do not feel obligated to reply outside of your scheduled working hours. Let's work together to help foster healthy work-life boundaries.

**Niranjan Rajevan**, **M.Pl.** | Associate Planner, Programs and Process Improvement, Planning and Economic Development, Corporate Services

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# SCHEDULE C: PUBLIC & APPLICANT CORRESPONDENCE

None