ITEM: 6.4

REPORT SUMMARY MINOR VARIANCE APPLICATION FILE NUMBER A186/23

Report Date: February 16, 2024

THIS REPORT CONTAINS COMMENTS FROM THE FOLLOWING DEPARTMENTS & AGENCIES (SEE SCHEDULE B):

Additional comments from departments and agencies received after the publication of the report will be made available on the City's <u>website</u>.

Internal Departments *Comments Received	Conditions Required		Nature of Comments
Committee of Adjustment	Yes □	No ⊠	General Comments
Building Standards (Zoning) *See Schedule B	Yes □	No ⊠	General Comments
Development Planning	Yes □	No ⊠	Recommend Approval/No Conditions
Development Engineering	Yes □	No ⊠	General Comments

External Agencies *Comments Received	Conditions	Required	Nature of Comments *See Schedule B for full comments
Alectra	Yes □	No ⊠	General Comments
TRCA	Yes □	No ⊠	General Comments
Region of York	Yes □	No ⊠	General Comments

PUBLIC & APPLICANT CORRESPONDENCE (SEE SCHEDULE C)

All personal information collected because of this public meeting (including both written and oral submissions) is collected under the authority of the Municipal Act, the Municipal Freedom of Information and Protection of Privacy Act (MFIPPA), the Planning Act and all other relevant legislation, and will be used to assist in deciding on this matter. All personal information (as defined by MFIPPA), including (but not limited to) names, addresses, opinions and comments collected will become property of the City of Vaughan, will be made available for public disclosure (including being posted on the internet) and will be used to assist the Committee of Adjustment and staff to process this application.

Correspondence Type	Name	Address	Date Received (mm/dd/yyyy)	Summary
Applicant				Application Cover Letter

BACKGROUND (SCHEDULE D, IF REQUIRED)		
* Background Information contains historical development approvals considered to be related to this file.		
This information should not be considered comprehensive.		
Application No. (City File) Application Description		
(i.e. Minor Variance Application; Approved by COA / OLT)		
N/A N/A		

* Previous hearing dates where this application was adjourned by the Committee and public notice issued.		
Hearing Date Reason for Adjournment (to be obtained from NOD_ADJ)		
N/A N/A		

SCHEDULES		
Schedule A	Drawings & Plans Submitted with the Application	
Schedule B Comments from Agencies, Building Standards & Development Planning		
Schedule C (if required) Public & Applicant Correspondence		
Schedule D (if required)	Background	



MINOR VARIANCE APPLICATION FILE NUMBER A186/23

CITY WARD #:	2
APPLICANT:	Francesco & Irina Le Coche
AGENT:	Lifestyle Sunrooms Inc. (2306096 Ontario Ltd.)
PROPERTY:	23 Umbria Crescent, Woodbridge
	, 3
ZONING DESIGNATION:	See below.
VAUGHAN OFFICIAL PLAN	Vaughan Official Plan 2010 ('VOP 2010'): "Low-Rise Residential".
(2010) DESIGNATION:	
RELATED DEVELOPMENT APPLICATIONS:	None
PURPOSE OF APPLICATION:	Relief from the Zoning By-law is being requested to permit an unheated sunroom to be constructed at the rear of the existing dwelling.

The following variances are being requested from the City's Zoning By-law to accommodate the above proposal:

The subject lands are zoned R5(EN) – Fifth Density Residential Zone (Established Neighbourhood) and subject to the provisions of Exception 14.650 under Zoning By-law 001-2021.

#	Zoning By-law 001-2021	Variance requested
1	A minimum setback of 7.5 m is required from	To permit a minimum setback of 6.74 m from
	the rear lot line to the unheated sunroom	the rear lot line to the unheated sunroom
	addition for a dwelling. [Table 7-5]	addition for a dwelling.

HEARING INFORMATION

DATE OF MEETING: Thursday, February 22, 2024

TIME: 6:00 p.m.

MEETING LOCATION: Vaughan City Hall, Woodbridge Room (2nd Floor), 2141 Major Mackenzie Drive

LIVE STREAM LINK: Vaughan.ca/LiveCouncil

PUBLIC PARTICIPATION

If you would like to speak to the Committee of Adjustment at the meeting, either remotely or in person, please complete the Request to Speak Form and submit to cofa@vaughan.ca

If you would like to submit written comments, please quote file number above and submit by mail or email to:

Email: cofa@vaughan.ca

Mail: City of Vaughan, Office of the City Clerk, Committee of Adjustment, 2141 Major Mackenzie Drive, Vaughan, ON, L6A 1T1

To speak electronically, pre-registration is required by completing the Request to Speak Form on-line and submitting it to cofa@vaughan.ca no later than NOON on the last business day before the meeting.

THE DEADLINE TO REGISTER TO SPEAK ELECTRONICALLY OR SUBMIT WRITTEN COMMENTS ON THE ABOVE NOTED FILE(S) IS <u>NOON</u> ON THE LAST BUSINESS DAY BEFORE THE MEETING.

INTRODUCTION

Staff and Agencies act as advisory bodies to the Committee of Adjustment. The comments contained in this report are presented as recommendations to the Committee.

Section 45(1) of the Planning Act sets the criteria for authorizing minor variances to the City of Vaughan's Zoning By-law. Accordingly, review of the application may consider the following:

INTRODUCTION

That the general intent and purpose of the by-law will be maintained. That the general intent and purpose of the official plan will be maintained.

That the requested variance(s) is/are acceptable for the appropriate development of the subject lands.

That the requested variance(s) is/are minor in nature.

Public written and oral submissions relating to this application are taken into consideration by the Committee of Adjustment as part of its deliberations and final decision on this matter.

COMMITTEE OF ADJUSTMENT		
Date Public Notice Mailed:	February 8, 2024	
Date Applicant Confirmed Posting of Sign:	February 9, 2024	
*As provided in Application Form	Relief from the Zoning By-law is being requested to permit an unheated sunroom to be constructed at the rear of the existing dwelling.	
Was a Zoning Review Waiver (ZRW) Form submitted by Applicant: *ZRW Form may be used by applicant in instances where a revised submission is made, and zoning staff do not have an opportunity to review and confirm variances prior to the issuance of public notice.	Yes □ No ⊠	
COMMENTS:		
None		
Committee of Adjustment Recommended Conditions of Approval:	None	

BUILDING STANDARDS (ZONING)		
**See Schedule B for Building Standards (Zoning) Comments		
Building Standards Recommended Conditions of Approval: None		

DEVELOPMENT PLANNING	
**See Schedule B for Development Planning Comments.	
Development Planning Recommended Conditions of Approval:	None

DEVELOPMENT ENGINEERING		
Link to Grading Permit Link to Pool Pe	ermit Link to Curb Curt Permit Link Culvert Installation	
The Development Engineering Department does not object to the Minor Variance application A186/23.		
Development Engineering Recommended Conditions of		
Approval:		

PARKS, FORESTRY & HORTICULTURE (PFH)	
No comments received to date.	
PFH Recommended Conditions of Approval:	None

DEVELOPMENT FINANCE	
No comment no concerns.	
Development Finance Recommended Conditions of Approval:	None

BY-LAW AND COMPLIANCE, LICENSING AND PERMIT SERVICES	
No comments received to date.	
BCLPS Recommended Conditions of Approval:	None

BUILDING INSPECTION (SEPTIC)	
No comments received to date.	
Building Inspection Recommended Conditions of Approval:	None

FIRE DEPARTMENT	
No comments received to date.	
Fire Department Recommended Conditions of Approval:	None

IMPORTANT INFORMATION

CONDITIONS: It is the responsibility of the owner/applicant and/or authorized agent to obtain and provide a clearance letter from respective department and/or agency (see condition chart above for contact). This letter must be provided to the Secretary-Treasurer to be finalized. All conditions must be cleared prior to the issuance of a Building Permit.

APPROVALS: Making any changes to your proposal after a decision has been made may impact the validity of the Committee's decision.

An approval obtained from the Committee of Adjustment, where applicable, is tied to the building envelope shown on the plans and drawings submitted with the application and subject to the variance approval.

A building envelope is defined by the setbacks of the buildings and/or structures shown on the plans and drawings submitted with the application, as required by Ontario Regulation 200/96. Future development outside of an approved building envelope, where a minor variance was obtained, must comply with the provisions of the City's Zoning By-law.

Elevation drawings are provided to reflect the style of roof (i.e. flat, mansard, gable etc.) to which a building height variance has been applied. Where a height variance is approved, building height is applied to the style of roof (as defined in the City's Zoning By-law) shown on the elevation plans submitted with the application.

Architectural design features that are not regulated by the City's Zoning By-law are not to be considered part of an approval unless specified in the Committee's decision.

DEVELOPMENT CHARGES: That the payment of the Regional Development Charge, if required, is payable to the City of Vaughan before issuance of a building permit in accordance with the Development Charges Act and the Regional Development Charges By-law in effect at the time of payment.


That the payment of the City Development Charge, if required, is payable to the City of Vaughan before issuance of a building permit in accordance with the Development Charges Act and the City's Development Charges By-law in effect at the time of payment.

That the payment of the Education Development Charge if required, is payable to the City of Vaughan before issuance of a building permit in accordance with the Development Charges Act and the Boards of Education By-laws in effect at the time of payment

That the payment of Special Area Development charge, if required, is payable to the City of Vaughan before issuance of a building permit in accordance with the Development Charges Act and The City's Development Charge By-law in effect at the time of Building permit issuance to the satisfaction of the Reserves/Capital Department.

NOTICE OF DECISION: If you wish to be notified of the decision in respect to this application or a related Ontario Land Tribunal (OLT) hearing you must complete a Request for Decision form and submit to the Secretary Treasurer (ask staff for details). In the absence of a written request to be notified of the Committee's decision you will **not** receive notice.

SCHEDULE A: DRAWINGS & PLANS

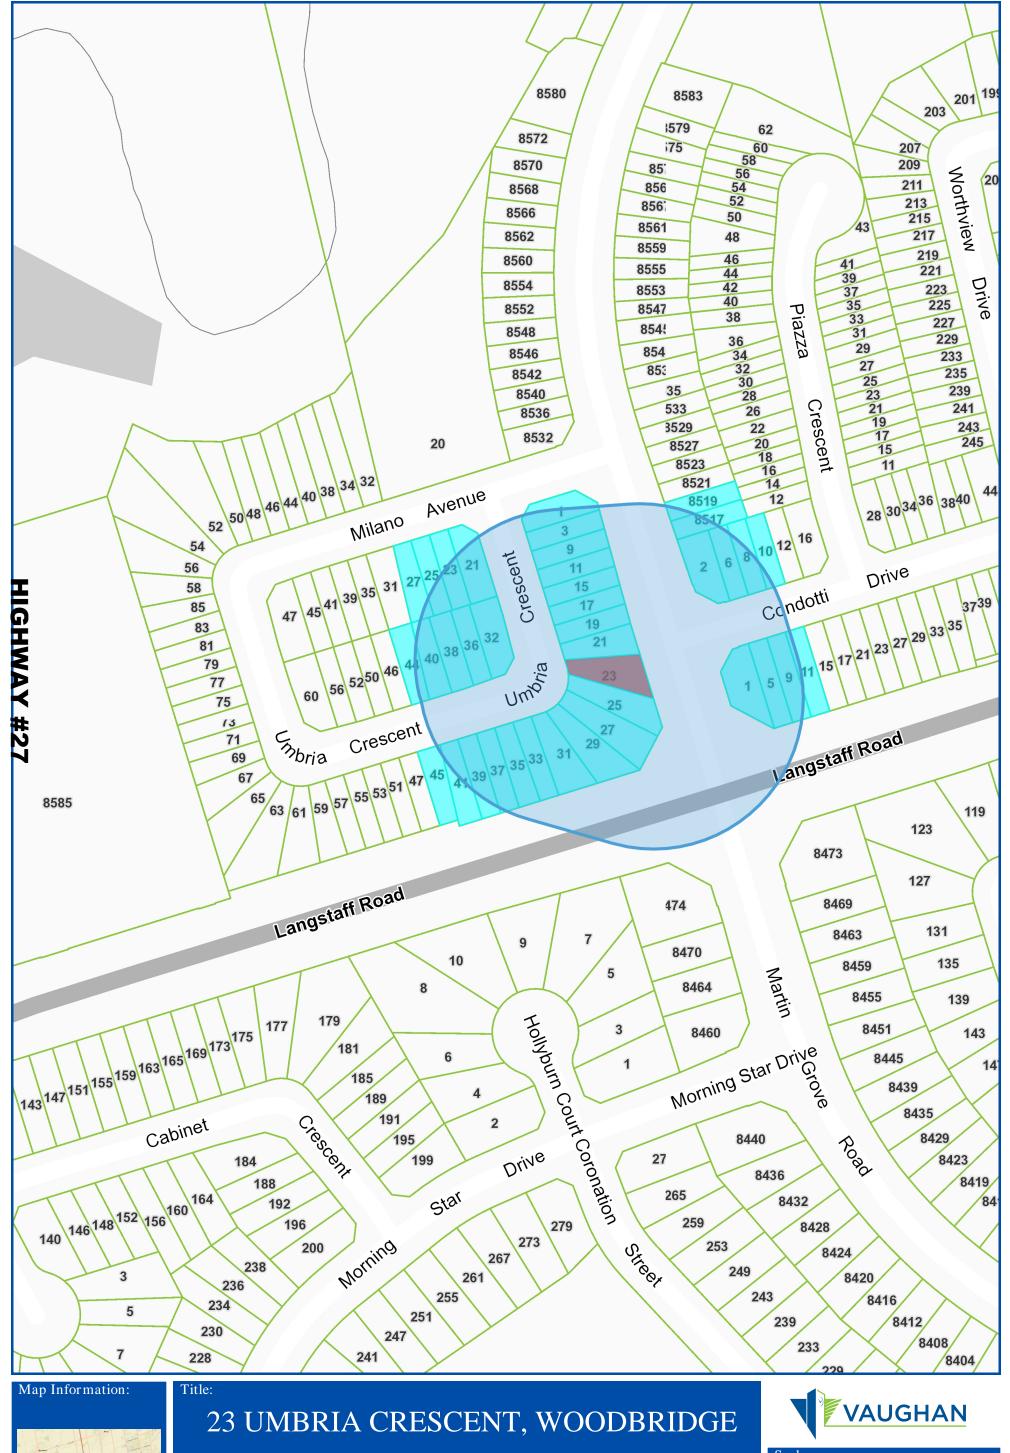

NOTIFICATION MAP - A186/23




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Created By: Infrastructure Delivery Department November 17, 2023 11:12 AM

NAD 83 UTM Zone



NOTES:

- 1. THE WALLS AND ROOF STRUCTURAL PANELS OF THE SUNROOM WILL BE PREFABRICATED BY LIFESTYLE SUNROOMS INC. AND WILL BE INSTALLED BY ITS TRAINED SKILLED INSTALLERS.
- 2. A PROFESSIONAL ENGINEER UNDERTAKES THE GENERAL REVIEW OF THE INSTALLATION.
- 3. A FINAL PROJECT REVIEW LETTER WILL BE SUBMITTED TO THE BUILDING DEPARTMENT AFTER THE COMPLETION.
- 4. (1). STAIRS RISER DIMENSIONS SHALL CONFIRM TO ARTICLES 9.8.4.2 AND 9.8.4.3 OF THE 2012 OBC WHICH STIPULATES THAT RISERS DESIGNED FOR PRIVATE USE MUST HAVE A MAXIMUM RISE OF NO MORE THAN 200 mm OR A MINIMUM RISE OF NO LESS THAN 125 mm AND A MAXIMUM RUN OF NO MORE THAN 355 mm OR A MINIMUM RUN OF NO MORE THAN 210 mm AND A MAXIMUM TREAD DEPTH OF 355 mm OR A MINIMUM TREAD DEPTH OF NO LESS THAN 235 mm.
- 4. (2). REQUIRED EXIT STAIRS SHALL HAVE A WIDTH, MEASURED BETWEEN WALL FACES OR GUARDS, OF NOT LESS THAN 900 mm AS PER ARTICLE 9.8.2.1 OF THE 2012 OBC.
- 5. THE WIDTH OF THE LANDING IF REQUIRED SHALL BE NOT LESS THAN THE GREATER REQUIRED STAIR WIDTH WHERE ONE OR MORE OF THE STAIR WIDTHS DO NOT EXCEED THEIR RESPECTIVE REQUIRED WIDTHS, OR NOT LESS THAN THE LESSER ACTUAL STAIR WIDTH WHERE ALL OF THE WIDTHS OF THE STAIRS EXCEED THEIR RESPECTIVE REQUIRED WIDTHS AS PER ARTICLES 9.8.6.2 AND 9.8.6.3 OF THE 2012 OBC.
- 6. ALL <u>HAND RAILS AND GUARDS</u> SHALL BE BUILT AS PER OBC 2012 AND SUPPLEMENTARY STANDARD SB-7. EXTERIOR HANDRAIL AND GUARDS TO BE AT LEAST 900 mm OR 36" MEASURED VERTICALLY ABOVE THE NOSING OF ANY TREAD AND/OR PLATFORM NOT MORE THAN 1800 mm OR 5'-11" ABOVE THE FINISHED GROUND AS PER SUBSECTIONS 9.8.7 AND 9.8.8 OF 2012 OBC; ALL PICKET AND/OR GUARD SPACING MUST BE NO MORE THAN 100 mm OR 4" APART AS PER ARTICLE 9.8.8.5 OF THE 2012 OBC; ALL BALUSTERS TO BE SPACED NO MORE THAN 1200 mm OR 48" APART.
 7.TO CARRY RAINWATER AWAY FROM THE SUNROOM, DOWNSPOUTS WILL BE INSTALLED AT THE OUTSIDE CORNERS OF ROOM IN ACCORDANCE TO ARTICLES 9.26.18.2, 7.3.3.7, AND 5.6.2.2 OF THE 2012
- 8. ALL <u>ADDITIONAL ASPECTS</u> OF THE PROJECT WILL BE INSTALLED ACCORDING TO TACBOC DETAILS AND COMPLY WITH THE REQUIREMENTS STIPULATED BY THE 2012 OBC, INCLUDING DOORS (TO SECTION 9.6.); WINDOWS (TO SECTION 9.7.); SKYLIGHTS(TO SUBSECTION 9.7.7.); GLASSES(TO SUBSECTION 9.7.3.); WOOD FRAME CONNECTIONS, DECK FARMING, STICK BUILT WALLS AND SUBFLOORING (TO SUBSECTION 9.23.14);BUILT—UP BEAMS (TO ARTICLE 9.23.8.3); BUILT—UP COLUMNS (TO ARTICLE 9.17.4.2); ROOFING (TO SECTION 9.26.); ROOF DRAINS AND DOWNSPOUTS (TO SUBSECTION 9.26.18.); FLASHING (TO SUBSECTIONS 9.20.13 &9.26.3 &9.26.4); CLADDING(TO SECTION 9.27.); CAULKING (TO SUBSECTION 9.27.4.); INTERIOR FINISHING (TO SUBSECTION 9.29.); FLOORING (TO SECTION 9.30.); STAIRS, RAMPS, HANDRAILS AND GUARDS (TO SECTION 9.8.); LIGHTING OUTLETS (TO SECTION 9.34.).

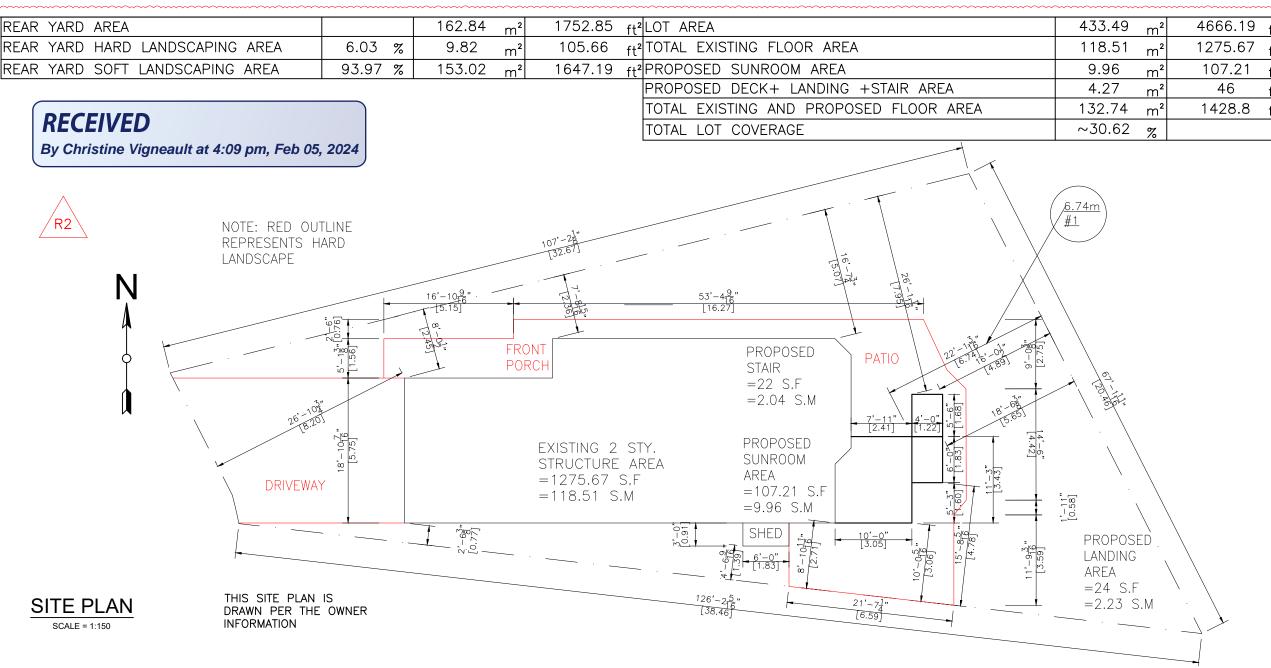

944 Crawford Dr. Peterborough, Ontario K9J 3X2

www.lifestylesunrooms.com

Tel: 800-465-0593 Fax: 800-934-0822

PROJECT

LIFESTYLE SUNROOM ADDITION

PROJECT ADDRESS

23 UMBRIA CRES VAUGHAN, ON L4H 2E1

DRAWING TITLE

SITE PLAN

DRAWING NUMBER

01

REVISION PROJECT# DESIGN# PRJ92498 MODEL TYPE 225 A-FRAME (4" WOOD TOP) CLIENT


CLIENI	
FRANCESCO &	IRINA LECOCHE
DATE	SCALE
JAN 26, 2024	
DRAWN BY:	CHECKED BY:

LIFESTYLE ENGINEERING

J.P.

L.W.



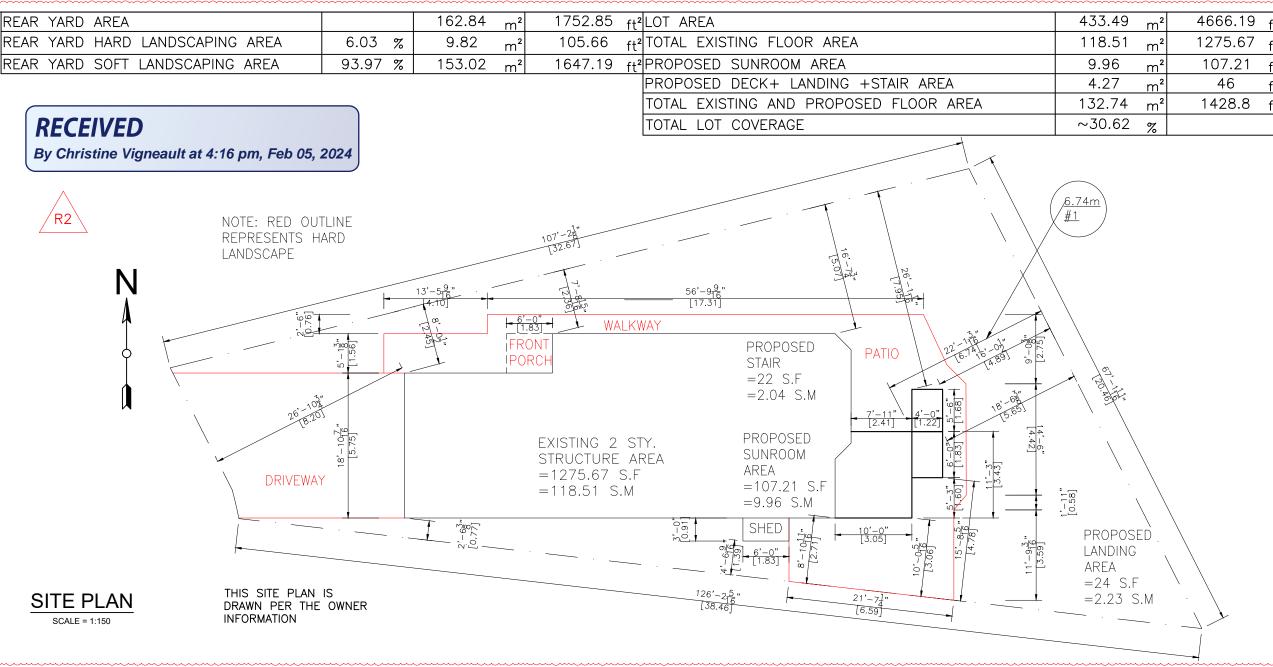

NOTES

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${\bf www.lifestyle sunrooms.com}$

Tel: 800-465-0593 Fax: 800-934-0822

PROJECT

LIFESTYLE SUNROOM ADDITION

PROJECT ADDRESS

23 UMBRIA CRES VAUGHAN, ON L4H 2E1

DRAWING TITLE

SITE PLAN


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REVISION PROJECT# DESIGN# PRJ92498 MODEL TYPE 225 A-FRAME (4" WOOD TOP)


CLIENT FRANCESCO & IRINA LECOCHE DATE SCALE

JAN 26, 2024	
DRAWN BY:	CHECKED BY
L.W.	J.P.




* NOTES: -HELICAL PILES ARE PER CCMC 13059-R AND THE ENCLOSED CALCULATIONS -THE STRUCTURAL PANELS ARE ACCORDING TO BMEC#03-08-287 AND THE

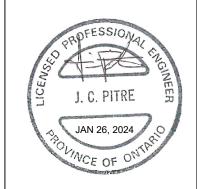ENCLOSED CALCULATIONS

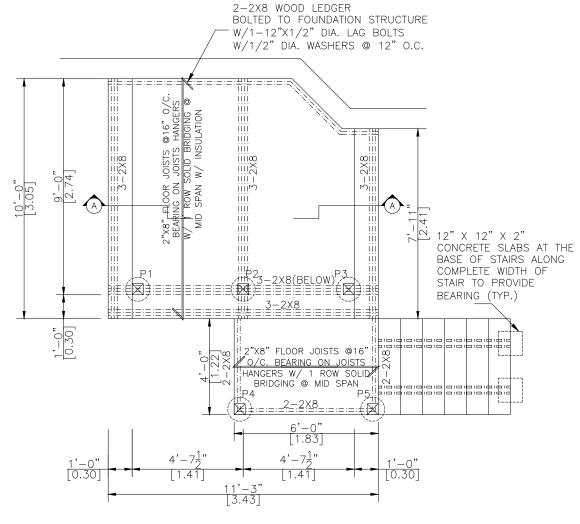

PIERS & DECK PLAN

SCALE 1/4"=1'-0"

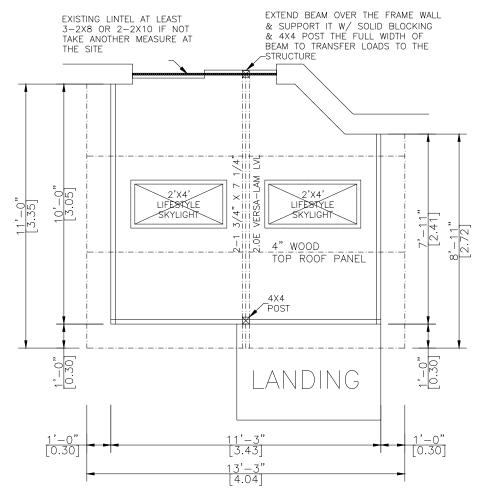

WALLS & ROOF PLAN

SCALE 1/4"=1'-0"

P1	Compressive Load = 11.63 KN = 2615 Lbs Use helical post per structural calculation
P2	Compressive Load = 24.29 KN = 5462 Lbs Use helical post per structural calculation
P3	Compressive Load = 13.17 KN = 2961 Lbs Use helical post per structural calculation
P4,P5	Compressive Load = 2.1 KN = 473 Lbs Use helical post per structural calculation



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PROJECT

LIFESTYLE SUNROOM ADDITION

PROJECT ADDRESS

23 UMBRIA CRES VAUGHAN, ON L4H 2E1

DRAWING TITLE

DECK & ROOF PLAN

DRAWING NUMBER


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REVISION PROJECT# DESIGN# PRJ92498 MODEL TYPE 225 A-FRAME (4" WOOD TOP)


CLIENT


IRINA LECOCHE
SCALE
CHECKED BY:
J.P.



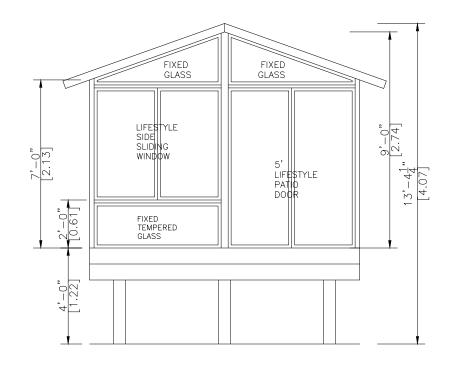

FRONT ELEVATION SCALE 1/4"=1'-0"

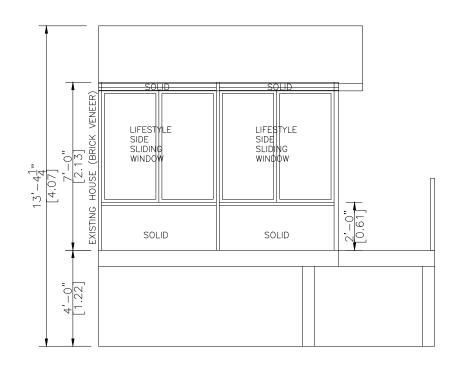

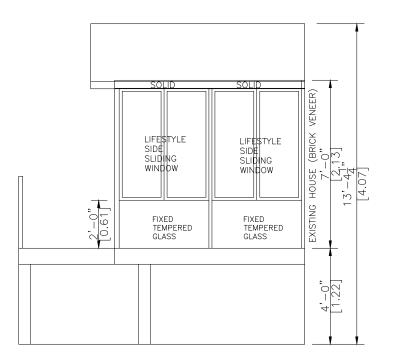

LEFT ELEVATION

SCALE 1/4"=1'-0"

RIGHT ELEVATION

SCALE 1/4"=1'-0"



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PROJECT

LIFESTYLE SUNROOM ADDITION

PROJECT ADDRESS

23 UMBRIA CRES VAUGHAN, ON L4H 2E1

DRAWING TITLE

ELEVATIONS

DRAWING NUMBER

03

REVISION PROJECT# DESIGN# PRJ92498

MODEL TYPE

225 A-FRAME (4" WOOD TOP)

CLIENT

FRANCES	CO &	IRINA	LECOCHE

DATE	SCALE
JAN 26, 2024	
DRAWN BY:	CHECKED BY
L.W.	J.P.



NOTE:

-THE M3500 WAS TESTED AND CERTIFIED BY INTERTEK CANADA. WITH A MAXIMUM PAYLOAD OF 96,440 LBS, WITH A 4/1 SAFETY RATIO, GIVING THE M3500 A SAFETY LOAD FACTOR OF APPROX. 24,100 LBS PER BRACKET.

-6" SLEEVE ANCHORS TO ATTACH THE M3500 TO THE FOUNDATION OF THE HOUSE.

-FRONT AND SIDE LATERAL SUPPORTS TO BE INSTALLED ON THE FRONT BEAM/POST ASSEMBLY.


RIDGE BEAM 2-1 3/4" X 7 1/4" 2.0E VERSA-LAM LVL EXTEND BEAM OVER THE FRAME WALL & SUPPORT IT W/ SOLID BLOCKING & 4X4 POST THE FULL WIDTH OF BEAM TO TRANSFER LOADS TO THE STRUCTURE WOOD TOP ROOF PANEL GUTTER ¬ 4X4 POST_ (BEYOND) WOOD FLOOR JOISTS INSULATION (TYP. 5/8" PLYWOOD SUBFLOOR FINISHED FLOOR MIN 48 BELOW GRADE 井 metal post (typ.)~

A-A SECTION

SCALE= 1/4"=1'-0"

NOTE:

-HELICAL PILES MADE OF STEEL IN ACCORDANCE WITH ASTM A500 GRADE C AND CAN/CSA-G40.21-97 HEAT GALVANIZED WITH A GALVANIZATION RATING OF AT LEAST 610 g/m² ACCORDING TO THE CSA-G164M-92 STANDARDS. ALL HELICAL PILES MUST BE INSTALLED TO A DEPTH OF AT LEAST 48" OR GREATER BELOW GRADE LEVEL AND IN ACCORDANCE WITH THE TORQUE SPECIFICATIONS.(REFER TO STRUCTURAL CALCULATION) -ALL CONCRETE PIER DESIGNS BASED ON SOIL BEARING CAPACITY OF 1500 P.s.f. (REFER TO STRUCTURAL CALCULATIONS)

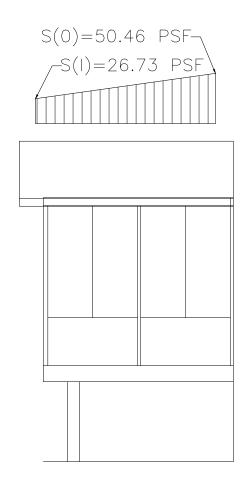



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PROJECT

LIFESTYLE SUNROOM ADDITION

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23 UMBRIA CRES VAUGHAN, ON L4H 2E1

DRAWING TITLE

A-A SECTION & SNOW ACCUMULATION

DRAWING NUMBER

04

REVISION PROJECT# DESIGN# PRJ92498 MODEL TYPE 225 A-FRAME (4" WOOD TOP) CLIENT

FRANCESCO & IRINA LECOCHE DATE SCALE JAN 26, 2024 FRAWN BY: CHECKED BY:

LIFESTYLE ENGINEERING

J.P.

L.W.




SNOW ACCUMULATION

REFER TO ATTACHED CALCULATION


* NOTES: -HELICAL PILES ARE PER CCMC 13059-R AND THE ENCLOSED CALCULATIONS -THE STRUCTURAL PANELS ARE ACCORDING TO BMEC#03-08-287 AND THE

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SCALE 1/4"=1'-0"

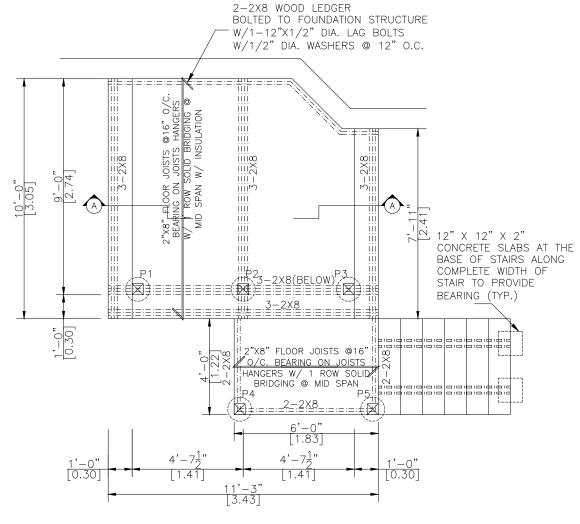

WALLS & ROOF PLAN

SCALE 1/4"=1'-0"
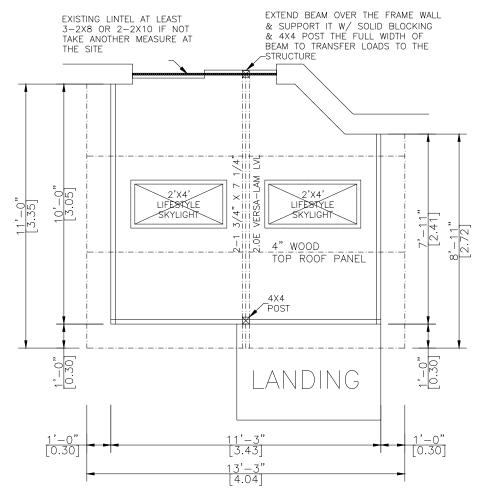
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DECK & ROOF PLAN

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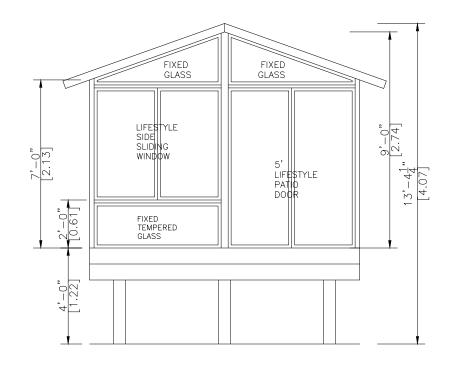
02

REVISION PROJECT# DESIGN# PRJ92498 MODEL TYPE 225 A-FRAME (4" WOOD TOP)


CLIENT


IRINA LECOCHE		
SCALE		
CHECKED BY:		
J.P.		





FRONT ELEVATION SCALE 1/4"=1'-0"

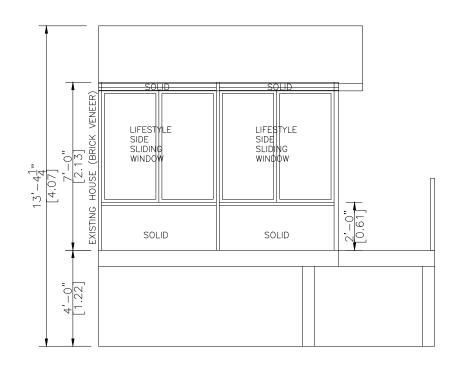

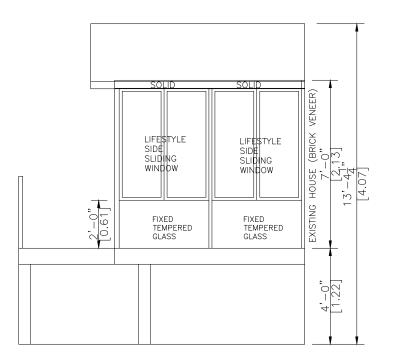

LEFT ELEVATION

SCALE 1/4"=1'-0"

RIGHT ELEVATION

SCALE 1/4"=1'-0"



944 Crawford Dr. Peterborough, Ontario K9J 3X2

www.lifestylesunrooms.com

Tel: 800-465-0593 Fax: 800-934-0822

PROJECT

LIFESTYLE SUNROOM ADDITION

PROJECT ADDRESS

23 UMBRIA CRES VAUGHAN, ON L4H 2E1

DRAWING TITLE

ELEVATIONS

DRAWING NUMBER

03

REVISION PROJECT# DESIGN# PRJ92498

MODEL TYPE

225 A-FRAME (4" WOOD TOP)

CLIENT

FRANCES	CO &	IRINA	LECOCHE

DATE	SCALE
JAN 26, 2024	
DRAWN BY:	CHECKED BY
L.W.	J.P.



NOTE:

-THE M3500 WAS TESTED AND CERTIFIED BY INTERTEK CANADA. WITH A MAXIMUM PAYLOAD OF 96,440 LBS, WITH A 4/1 SAFETY RATIO, GIVING THE M3500 A SAFETY LOAD FACTOR OF APPROX. 24,100 LBS PER BRACKET.

-6" SLEEVE ANCHORS TO ATTACH THE M3500 TO THE FOUNDATION OF THE HOUSE.

-FRONT AND SIDE LATERAL SUPPORTS TO BE INSTALLED ON THE FRONT BEAM/POST ASSEMBLY.


RIDGE BEAM 2-1 3/4" X 7 1/4" 2.0E VERSA-LAM LVL EXTEND BEAM OVER THE FRAME WALL & SUPPORT IT W/ SOLID BLOCKING & 4X4 POST THE FULL WIDTH OF BEAM TO TRANSFER LOADS TO THE STRUCTURE WOOD TOP ROOF PANEL GUTTER ¬ 4X4 POST_ (BEYOND) WOOD FLOOR JOISTS INSULATION (TYP. 5/8" PLYWOOD SUBFLOOR FINISHED FLOOR MIN 48 BELOW GRADE 井 metal post (typ.)~

A-A SECTION

SCALE= 1/4"=1'-0"

NOTE:

-HELICAL PILES MADE OF STEEL IN ACCORDANCE WITH ASTM A500 GRADE C AND CAN/CSA-G40.21-97 HEAT GALVANIZED WITH A GALVANIZATION RATING OF AT LEAST 610 g/m² ACCORDING TO THE CSA-G164M-92 STANDARDS. ALL HELICAL PILES MUST BE INSTALLED TO A DEPTH OF AT LEAST 48" OR GREATER BELOW GRADE LEVEL AND IN ACCORDANCE WITH THE TORQUE SPECIFICATIONS.(REFER TO STRUCTURAL CALCULATION) -ALL CONCRETE PIER DESIGNS BASED ON SOIL BEARING CAPACITY OF 1500 P.s.f. (REFER TO STRUCTURAL CALCULATIONS)

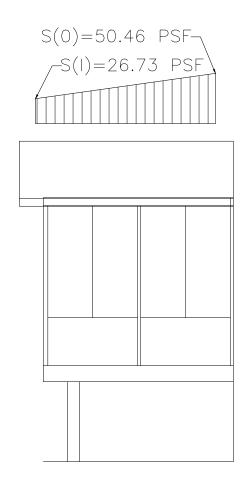



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PROJECT

LIFESTYLE SUNROOM ADDITION

PROJECT ADDRESS

23 UMBRIA CRES VAUGHAN, ON L4H 2E1

DRAWING TITLE

A-A SECTION & SNOW ACCUMULATION

DRAWING NUMBER

04

REVISION PROJECT# DESIGN# PRJ92498 MODEL TYPE 225 A-FRAME (4" WOOD TOP) CLIENT

FRANCESCO & IRINA LECOCHE DATE SCALE JAN 26, 2024 FRAWN BY: CHECKED BY:

LIFESTYLE ENGINEERING


J.P.

L.W.



SNOW ACCUMULATION

REFER TO ATTACHED CALCULATION

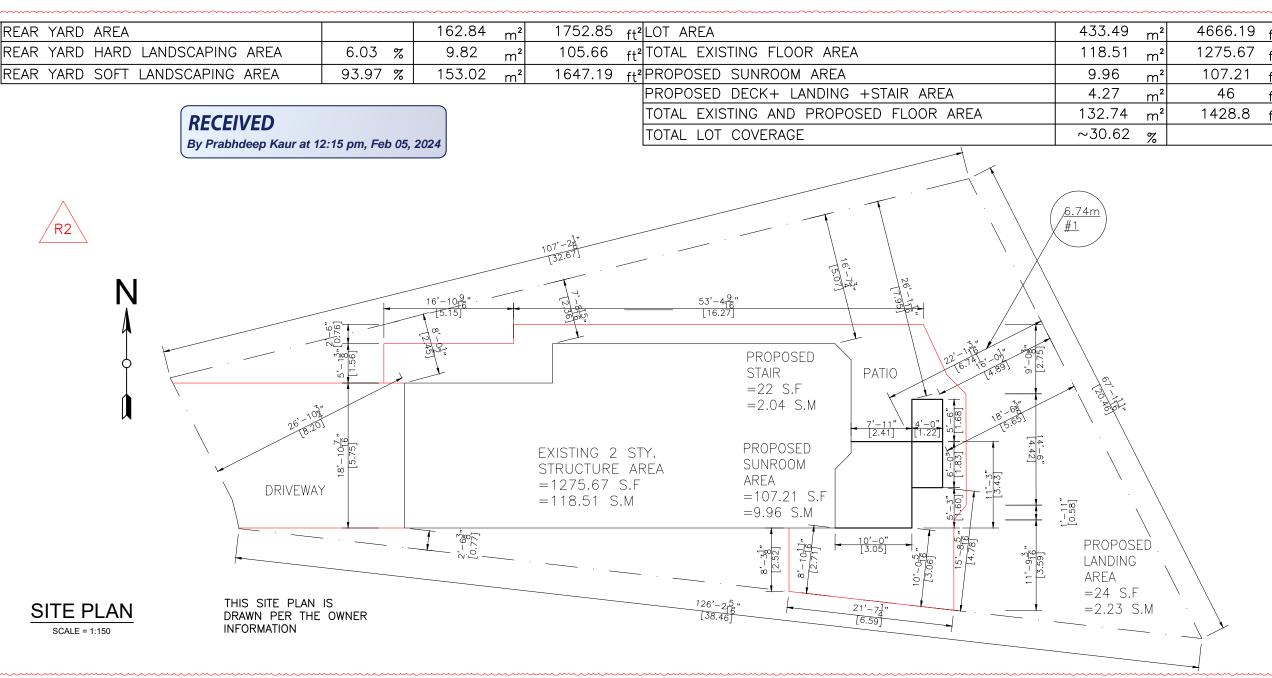

NOTES:

- 1. THE WALLS AND ROOF STRUCTURAL PANELS OF THE SUNROOM WILL BE PREFABRICATED BY LIFESTYLE SUNROOMS INC. AND WILL BE INSTALLED BY ITS TRAINED SKILLED INSTALLERS.
- 2. A PROFESSIONAL ENGINEER UNDERTAKES THE GENERAL REVIEW OF THE INSTALLATION.
- 3. A FINAL PROJECT REVIEW LETTER WILL BE SUBMITTED TO THE BUILDING DEPARTMENT AFTER THE COMPLETION.
 4. (1). STAIRS RISER DIMENSIONS SHALL CONFIRM TO ARTICLES 9.8.4.2 AND 9.8.4.3 OF THE 2012 OBC WHICH STIPULATES THAT RISERS DESIGNED FOR PRIVATE USE MUST HAVE A MAXIMUM RISE OF NO MORE THAN 200 mm OR A MINIMUM RISE OF NO LESS THAN 125 mm AND A MAXIMUM RUN OF NO MORE THAN 355 mm OR A MINIMUM RUN OF NO MORE THAN 210 mm AND A MAXIMUM TREAD DEPTH OF NO LESS THAN 235 mm.
- 4. (2). REQUIRED EXIT STAIRS SHALL HAVE A WIDTH, MEASURED BETWEEN WALL FACES OR GUARDS, OF NOT LESS THAN 900 mm AS PER ARTICLE 9.8.2.1 OF THE 2012 OBC.
- 5. THE WIDTH OF THE LANDING IF REQUIRED SHALL BE NOT LESS THAN THE GREATER REQUIRED STAIR WIDTH WHERE ONE OR MORE OF THE STAIR WIDTHS DO NOT EXCEED THEIR RESPECTIVE REQUIRED WIDTHS, OR NOT LESS THAN THE LESSER ACTUAL STAIR WIDTH WHERE ALL OF THE WIDTHS OF THE STAIRS EXCEED THEIR RESPECTIVE REQUIRED WIDTHS AS PER ARTICLES 9.8.6.2 AND 9.8.6.3 OF THE 2012 OBC.
- 6. ALL <u>HAND RAILS AND GUARDS</u> SHALL BE BUILT AS PER OBC 2012 AND SUPPLEMENTARY STANDARD SB-7. EXTERIOR HANDRAIL AND GUARDS TO BE AT LEAST 900 mm OR 36" MEASURED VERTICALLY ABOVE THE NOSING OF ANY TREAD AND/OR PLATFORM NOT MORE THAN 1800 mm OR 5'-11" ABOVE THE FINISHED GROUND AS PER SUBSECTIONS 9.8.7 AND 9.8.8 OF 2012 OBC; ALL PICKET AND/OR GUARD SPACING MUST BE NO MORE THAN 100 mm OR 4" APART AS PER ARTICLE 9.8.8.5 OF THE 2012 OBC; ALL BALUSTERS TO BE SPACED NO MORE THAN 1200 mm OR 48" APART.
 7.TO CARRY RAINWATER AWAY FROM THE SUNROOM, DOWNSPOUTS WILL BE INSTALLED AT THE OUTSIDE CORNERS OF ROOM IN ACCORDANCE TO ARTICLES 9.26.18.2, 7.3.3.7, AND 5.6.2.2 OF THE 2012
- 8. ALL <u>ADDITIONAL ASPECTS</u> OF THE PROJECT WILL BE INSTALLED ACCORDING TO TACBOC DETAILS AND COMPLY WITH THE REQUIREMENTS STIPULATED BY THE 2012 OBC, INCLUDING DOORS (TO SECTION 9.6.); WINDOWS (TO SECTION 9.7.); SKYLIGHTS(TO SUBSECTION 9.7.7.); GLASSES(TO SUBSECTION 9.7.3.); WOOD FRAME CONNECTIONS, DECK FARMING, STICK BUILT WALLS AND SUBFLOORING (TO SUBSECTION 9.23.14);BUILT—UP BEAMS (TO ARTICLE 9.23.8.3); BUILT—UP COLUMNS (TO ARTICLE 9.17.4.2); ROOFING (TO SECTION 9.26.); ROOF DRAINS AND DOWNSPOUTS (TO SUBSECTION 9.26.18.); FLASHING (TO SUBSECTIONS 9.20.13 &9.26.3 &9.26.4); CLADDING(TO SECTION 9.27.); CAULKING (TO SUBSECTION 9.27.4.); INTERIOR FINISHING (TO SUBSECTION 9.29.); FLOORING (TO SECTION 9.30.); STAIRS, RAMPS, HANDRAILS AND GUARDS (TO SECTION 9.8.); LIGHTING OUTLETS (TO SECTION 9.34.).



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PROJECT

LIFESTYLE SUNROOM ADDITION

PROJECT ADDRESS

23 UMBRIA CRES VAUGHAN, ON L4H 2E1

DRAWING TITLE

SITE PLAN

DRAWING NUMBER

01

REVISION PROJECT# DESIGN# PRJ92498 MODEL TYPE 225 A-FRAME (4" WOOD TOP) CLIENT

 FRANCESCO & IRINA LECOCHE

 DATE
 SCALE

 JAN 26, 2024


DRAWN BY: CHECKED BY:

L.W. J.P.




* NOTES: -HELICAL PILES ARE PER CCMC 13059-R AND THE ENCLOSED CALCULATIONS -THE STRUCTURAL PANELS ARE ACCORDING TO BMEC#03-08-287 AND THE

ENCLOSED CALCULATIONS

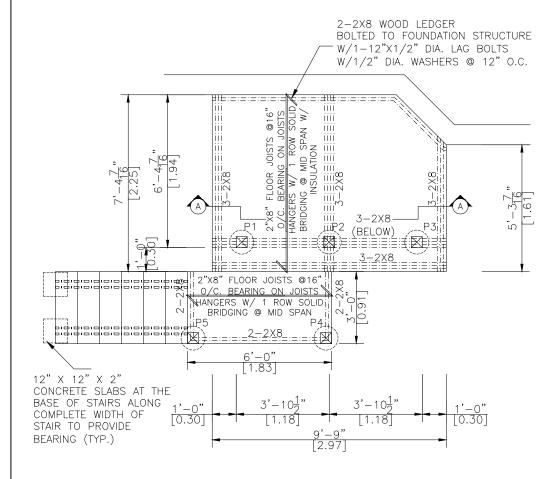



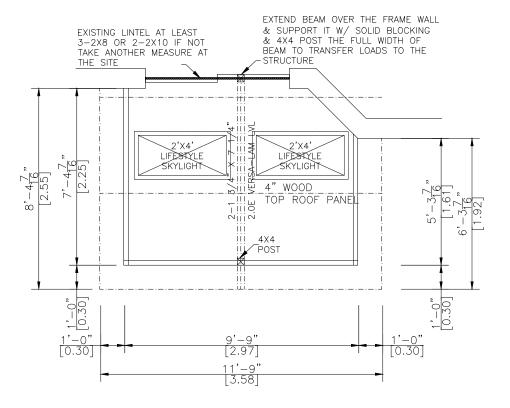

WALLS & ROOF PLAN

SCALE 1/4"=1'-0"

P1	Compressive Load = 11.63 KN = 2615 Lbs Use helical post per structural calculation
P2	Compressive Load = 24.29 KN = 5462 Lbs Use helical post per structural calculation
P3	Compressive Load = 13.17 KN = 2961 Lbs Use helical post per structural calculation
P4,P5	Compressive Load = 2.1 KN = 473 Lbs Use helical post per structural calculation



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PROJECT

LIFESTYLE SUNROOM ADDITION

PROJECT ADDRESS

23 UMBRIA CRES VAUGHAN, ON L4H 2E1

DRAWING TITLE

DECK & ROOF PLAN

DRAWING NUMBER


02

REVISION PROJECT# DESIGN# PRJ92498 MODEL TYPE 225 A-FRAME (4" WOOD TOP)

CLIENT


FRANCESCO &	IRINA LECOCHE
DATE	SCALE
JUL 20, 2023	
DRAWN BY:	CHECKED BY:



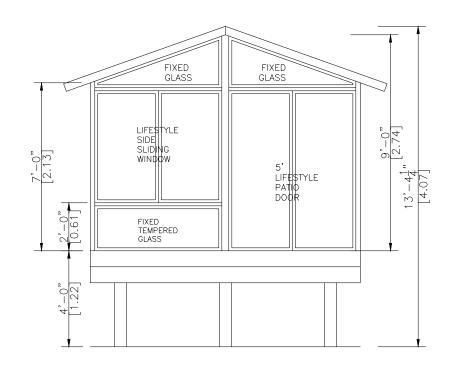


FRONT ELEVATION

SCALE 1/4"=1'-0"

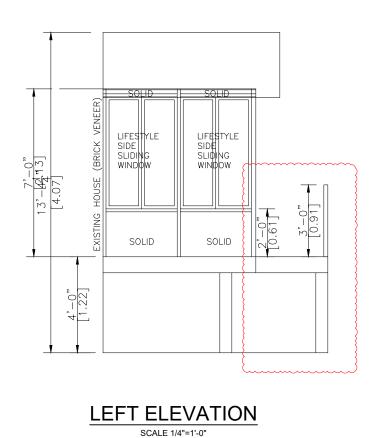



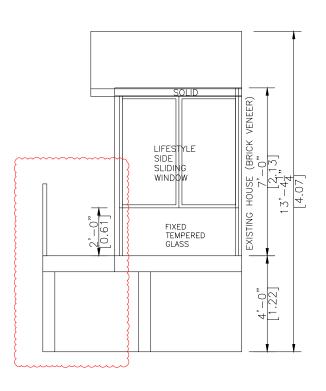

RIGHT ELEVATION

SCALE 1/4"=1'-0"



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PROJECT

LIFESTYLE SUNROOM ADDITION

PROJECT ADDRESS

23 UMBRIA CRES VAUGHAN, ON L4H 2E1

DRAWING TITLE

ELEVATIONS

DRAWING NUMBER

03

REVISION PROJECT# DESIGN# PRJ92498

MODEL TYPE

225 A-FRAME (4" WOOD TOP)

CLIENT

FRANCESCO	&c	IRINA	LECOCHE

DATE	SCALE
JUL 20, 2023	
DRAWN BY:	CHECKED BY
L.W.	J.P.



NOTE:

-THE M3500 WAS TESTED AND CERTIFIED BY INTERTEK CANADA. WITH A MAXIMUM PAYLOAD OF 96,440 LBS, WITH A 4/1 SAFETY RATIO, GIVING THE M3500 A SAFETY LOAD FACTOR OF APPROX. 24,100 LBS PER BRACKET.

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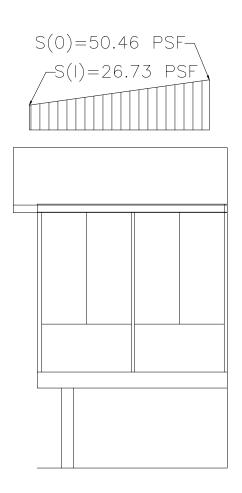
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RIDGE BEAM 2-1 3/4" X 7 1/4" 2.0E VERSA-LAM LVL EXTEND BEAM OVER THE FRAME WALL & SUPPORT IT W/ SOLID BLOCKING & 4X4 POST THE FULL WIDTH OF BEAM TO TRANSFER LOADS TO THE STRUCTURE GUTTER (0.46) 4X4 POST (BEYOND) 4X4 POST (BEYOND) 5/8" PLYWOOD SUBFLOOR FINISHED FLOOR METAL POST (TYP.) MIN 48" BELOW GRADE

SCALE= 1/4"=1'-0"

NOTE:

-HELICAL PILES MADE OF STEEL IN ACCORDANCE WITH ASTM A500 GRADE C AND CAN/CSA-G40.21-97 HEAT GALVANIZED WITH A GALVANIZATION RATING OF AT LEAST 610 g/m² ACCORDING TO THE CSA-G164M-92 STANDARDS. ALL HELICAL PILES MUST BE INSTALLED TO A DEPTH OF AT LEAST 48" OR GREATER BELOW GRADE LEVEL AND IN ACCORDANCE WITH THE TORQUE SPECIFICATIONS.(REFER TO STRUCTURAL CALCULATION) -ALL CONCRETE PIER DESIGNS BASED ON SOIL BEARING CAPACITY OF 1500 P.s.f. (REFER TO STRUCTURAL CALCULATIONS)





REFER TO ATTACHED CALCULATION



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${\bf www.lifestyle sunrooms.com}$

Tel: 800-465-0593 Fax: 800-934-0822

PROJECT

LIFESTYLE SUNROOM ADDITION

PROJECT ADDRESS

23 UMBRIA CRES VAUGHAN, ON L4H 2E1


DRAWING TITLE

A-A SECTION & SNOW ACCUMULATION

DRAWING NUMBER

04

REVISION PRO	JECT# DESIGN#		
PRJ92498			
MODEL TYPE			
225 A-FRAME (4" WOOD TOP)			
CLIENT			
FRANCESCO & IRINA LECOCHE			
DATE SCALE			
JUL 20, 2023			
DRAWN BY:	CHECKED BY:		

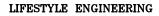

J.P.

L.W.



SCHEDULE B: COMMENTS FROM AGENCIES, BUILDING STANDARDS & DEVELOPMENT PLANNING

Department / Agency *Comments Received	Conditions Required		Nature of Comments
Building Standards (Zoning) *See	Yes □	No ⊠	General Comments
Schedule B			
Development Planning	Yes □	No ⊠	Recommend Approval/No Conditions
	•	•	
Alectra	Yes □	No ⊠	General Comments
TRCA	Yes □	No ⊠	General Comments
Region of York	Yes □	No ⊠	General Comments



Date: January 17th 2024

Attention: Christine Vigneault

RE: Request for Comments

File No.: A186-23

Related Files:

Applicant Frank & Irina Le Coche

Location 23 Umbria Crescent



COMMENTS:

	We have reviewed the proposed Variance Application and have no comments or objections to its approval.
X	We have reviewed the proposed Variance Application and have no objections to its approval, subject to the following comments (attached below).
	We have reviewed the proposed Variance Application and have the following concerns (attached below).

Alectra Utilities (formerly PowerStream) has received and reviewed the proposed Variance Application. This review, however, does not imply any approval of the project or plan.

All proposed billboards, signs, and other structures associated with the project or plan must maintain minimum clearances to the existing overhead or underground electrical distribution system as specified by the applicable standards, codes and acts referenced.

In the event that construction commences, and the clearance between any component of the work/structure and the adjacent existing overhead and underground electrical distribution system violates the Occupational Health and Safety Act, the customer will be responsible for 100% of the costs associated with Alectra making the work area safe. All construction work will be required to stop until the safe limits of approach can be established.

In the event construction is completed, and the clearance between the constructed structure and the adjacent existing overhead and underground electrical distribution system violates the any of applicable standards, acts or codes referenced, the customer will be responsible for 100% of Alectra's cost for any relocation work.

References:

- Ontario Electrical Safety Code, latest edition (Clearance of Conductors from Buildings)
- Ontario Health and Safety Act, latest edition (Construction Protection)
- Ontario Building Code, latest edition (Clearance to Buildings)
- PowerStream (Construction Standard 03-1, 03-4), attached
- Canadian Standards Association, latest edition (Basic Clearances)

If more information is required, please contact either of the following:

Mr. Stephen Cranley, C.E.T

Supervisor, Distribution Design, ICI & Layouts (North)

Phone: 1-877-963-6900 ext. 31297

E-mail: stephen.cranley@alectrautilities.com

Mitchell Penner

Supervisor, Distribution Design-Subdivisions

Phone: 416-302-6215

Email: Mitchell.Penner@alectrautilities.com



Power Stream 1

Construction Standard

03-1

	SYSTEM VOLTAGE			
LOCATION OF WIRES, CABLES OR CONDUCTORS	SPAN GUYS AND COMMUNICATIONS WIRES		4.16/2.4kV TO 27.6/16kV (SEE NOTE 1)	44kV
	MINIMUM	VERTICAL CLEA	ARANCES (SEE	NOTE 2)
OVER OR ALONGSIDE ROADS, DRIVEWAYS OR LANDS ACCESSIBLE TO <u>VEHICLES</u>	442cm	442cm	480cm	520cm
OVER GROUND ACCESSIBLE TO PEDESTRIANS AND BICYCLES ONLY	250cm	310cm	340cm	370cm
ABOVE TOP OF RAIL AT RAILWAY CROSSINGS	730cm	730cm	760cm	810cm



MINIMUM ATTACHMENT HEIGHT = MAXIMUM SAG

- + MINIMUM VERTICAL CLEARANCE (FROM ABOVE TABLE)
 ± GRADE DIFFERENCE

- + 0.3m (VEHICLE OR RAILWAY LOCATION) + SNOW DEPTH (PEDESTRIAN LOCATION, SEE NOTE 3)

NOTES:

- THE MULTIGROUNDED SYSTEM NEUTRAL HAS THE SAME CLEARANCE AS THE 600V SYSTEM.
- 2. THE VERTICAL CLEARANCES IN THE ABOVE TABLE ARE UNDER $\underline{\text{MAXIMUM SAG}}$ CONDITIONS.
- 3. REFER TO CSA STANDARD C22.3 No.1, ANNEX D FOR LOCAL SNOW DEPTH
- 4. ALL CLEARANCES ARE IN ACCORDANCE TO CSA STANDARD C22.3.

<u>\G</u>	340cm	11'-4"			
	310cm	10'-4"			
VALUES.	250cm	8'-4"			
VALUES.					
REFERENCES					
SAGS AND TENSIONS SECTION O					

METRIC

810cm

760cm 730cm

520cm 480cm

442cm 370cm

CONVERSION TABLE

IMPERIAL (APPROX)

27'-0" 25'-4"

24'-4" 17'-4"

15'-5" 12'-4"

MINIMUM VERTICAL CLEARANCES OF WIRES, CABLES AND CONDUCTORS ABOVE GROUND OR RAILS

ORIGINAL ISSUE DATE: 2010-DEC-24 REVISION NO: R1 REVISION DATE: 2012-JAN-09

Certificate of Approval This construction Standard meets the safety requirements of Section 4 of Regulation 22/04		
Joe Crozier, P.Eng. Name	2012-JAN-09 Date	
P Fng. Annroyal By-	Ine Crozier	



Construction Standard

03 - 4





VOLTAGE	MINIMUM HORIZONTAL CLEARNACE UNDER MAXIMUM SWING CONDITIONS DIMENSION "X" (SEE NOTES 1, 3 & 4)	MINIMUM VERTICAL CLEARANCE UNDER MAXIMUM DESIGN SAG CONDITIONS DIMENSION "Y" (SEE NOTES 1, 2, 4 & 5)	
0-600V AND NEUTRAL	100cm	250cm	
4.16/2.4 TO 44kV	300cm	480cm	

NOTES

- UNDER NO CIRCUMSTANCES SHALL A CONDUCTOR BE PERMITTED TO PENETRATE THE ENVELOPE SHOWN BY THE DOTTED LINE.
- 2. THE VERTICAL CLEARANCES ARE UNDER CONDITIONS OF MAXIMUM DESIGN SAG.
- THE HORIZONTAL CLEARANCES ARE UNDER CONDITIONS OF MAXIMUM SWING. WHERE THE CONDUCTOR SWING IS NOT KNOWN A HORIZONTAL CLEARANCE OF 480CM SHALL BE USED.
- 4. BUILDINGS THAT EXCEED 3 STOREYS OR 15M IN HEIGHT, THE MINIMUM HORIZONTAL CLEARANCE OF THE SECONDARY CONDUCTORS SHOULD BE INCREASED TO 300cm WHERE IT IS NECESSARY TO ALLOW FOR THE RAISING OF LADDERS BY LOCAL FIRE DEPARTMENTS.
- IN SITUATIONS SUCH AS MULTI-LEVEL GARAGES, WHERE ROOFS ARE NORMALLY USED BY PERSONS AND VEHICLES, THE VERTICAL CLEARANCES OF POWERSTREAM STANDARD 03-1 SHALL APPLY.
- 6. DISTRIBUTION LINES CONSTRUCTED NEAR BUILDINGS SHALL BE BUILT TO AVOID OVERHANG WHEREVER POSSIBLE. WHERE LINES MUST BE CONSTRUCTED OVER OR ADJACENT TO BUILDINGS THE APPLICABLE HORIZONTAL AND VERTICAL CLEARANCES SHALL BE AT CONDITIONS OF MAXIMUM CONDUCTOR SWING AND MAXIMUM SAG. THE ABOVE CLEARANCES ARE DESIGNED TO PREVENT PERSONS ON OR IN BUILDINGS AS WELL AS EXTERNAL MACHINERY USED IN CONJUCTION WITH A BUILDING TO COME IN CONTACT WITH CONDUCTORS. EFFORTS SHOULD BE MADE TO INCREASE THESE CLEARANCES WHERE POSSIBLE.
- 7. ALL CLEARANCES ARE IN ACCORDANCE TO CSA C22.3 NO.1-06 (TABLE-9).

CONVERSION TABLE		
IMPERIAL		
(APPROX)		
16'-0"		
10'-0"		
8'-4"		
3'-4"		

MINIMUM VERTICAL & HORIZONTAL CLEARANCES OF CONDUCTORS FROM BUILDINGS OR OTHER PERMANENT STRUCTURES (CONDUCTORS NOT ATTACHED TO BUILDINGS)

ORIGINAL ISSUE DATE: 2010—MAY—05 REVISION NO: REVISION DATE:
PEgystem Planning and Standards/Standard Design/PowerStream Standards/standards working (lighter/Seedlan 3/3-4/c/wg d3-4 Ro May 5, 2010, s/wg, 3/3/2010 8/2022 AM, Adobe POF



To: Committee of Adjustment

From: Faegheh Gholami, Building Standards Department

Date: February 9, 2024

Applicant: Frank & Irina Le Coche

Location: 23 Umbria Crescent

PLAN 65M3375 Lot 10

File No.(s): A186/23

Zoning Classification:

The subject lands are zoned R5(EN) – Fifth Density Residential Zone (Established Neighbourhood) and subject to the provisions of Exception 14.650 under Zoning By-law 001-2021.

#	Zoning By-law 001-2021	Variance requested		
1	A minimum setback of 7.5 m is required from the rear lot line to the unheated sunroom addition for a dwelling. [Table 7-5]	To permit a minimum setback of 6.74 m from the rear lot line to the unheated sunroom addition for a dwelling.		

Staff Comments:

Building Permit(s) Issued:

Building Permit Application No. 2023 130347 has been submitted for the proposed addition to the dwelling.

Other Comments:

Ger	neral Comments
1	The Applicant shall be advised that additional variances may be required upon review of
	detailed drawing for building permit.

Conditions of Approval:

If the committee finds merit in the application, the following conditions of approval are recommended.

None

* Comments are based on the review of documentation supplied with this application.





To: Christine Vigneault, Committee of Adjustment Secretary Treasurer

From: Nancy Tuckett, Director of Development Planning

Date: February 13, 2024

Name of Owner: Frank Le Coche

Location: 23 Umbria Crescent

File No.(s): A186/23

Proposed Variance(s) (By-law 001-2021):

1. A minimum setback of 7.5 m is required from the rear lot line to the unheated sunroom addition of a dwelling.

By-Law Requirement(s) (By-law 001-2021):

1. To permit a minimum setback of 6.74 m from the rear lot line to the unheated sunroom addition of a dwelling.

Official Plan:

City of Vaughan Official Plan 2010 ('VOP 2010'): "Low-Rise Residential"

Comments:

The Owner is requesting relief to permit the construction of a proposed sunroom, with the above-noted variance.

The Development Planning Department has no objection to the proposed variance for the reduced rear yard setback for the sunroom. Due to the unique shape of the pieshaped lot and rectangular footprint of the two-storey dwelling, the rear yard deepens the further south the rear lot line travels, causing the dwelling to be at an angle to the rear lot line. The near-square sunroom, with dimensions of about 3.05 m x 3.43 m, would be 6.74 m from the rear lot line at its northeast corner and 8.29 m from the rear lot line at its southeast corner. The sunroom occupies approximately half the length of the rear wall of the dwelling, leaving sufficient room for landscaped amenity space in the rear yard, particularly north and southeast of the sunroom. The sunroom will sit upon a deck, which will be reconfigured and expanded. As a result of the bend in Umbria Crescent, the sunroom will be behind the rear wall of the abutting property to the south, 25 Umbria Crescent, maintaining a stepping of built form in the rear yards facing Martin Grove Road. As an elevated single storey structure, which will be partially buffered by a privacy fence, the sunroom will not pose adverse massing impacts to Martin Grove Road.

Accordingly, the Development Planning Department can support the requested variance and is of the opinion that the proposal is minor in nature, maintains the general intent and purpose of the Official Plan and Zoning By-law, and is desirable for the appropriate development of the land.

Recommendation:

The Development Planning Department recommends approval of the application.

Conditions of Approval:

If the Committee finds merit in the application, the following conditions of approval are recommended:

None

Comments Prepared by:

Joshua Cipolletta, Planner David Harding, Senior Planner

Prabhdeep Kaur

From: Kristen Regier <Kristen.Regier@trca.ca>
Sent: Wednesday, January 17, 2024 11:40 AM

To: Committee of Adjustment

Cc: Prabhdeep Kaur

Subject: [External] RE: A186/23 (23 Umbria Cr) - REQUEST FOR COMMENTS, CITY OF VAUGHAN

CAUTION! This is an external email. Verify the sender's email address and carefully examine any links or attachments before clicking. If you believe this may be a phishing email, please use the Phish Alert Button.

Hello,

The subject property at 23 Umbria Crescent, Vaughan is not located within TRCA's Regulated Area. TRCA's Planning and Regulatory policy interests are not impacted.

As such, TRCA has no comments on the application.

Best,

Kristen Regier, MA (she / her)

Planner

Development Planning and Permits | Development and Engineering Services Toronto and Region Conservation Authority (TRCA)

T: 437-880-2129

E: kristen.regier@trca.ca

A: 101 Exchange Avenue, Vaughan, ON, L4K 5R6 | trca.ca



From: Development Services
To: Prabhdeep Kaur
Cc: Committee of Adjustment

Subject: [External] RE: A186/23 (23 Umbria Cr) - REQUEST FOR COMMENTS, CITY OF VAUGHAN

Date: Tuesday, February 13, 2024 2:30:42 PM

Attachments: image002.png

image004.png

CAUTION! This is an external email. Verify the sender's email address and carefully examine any links or attachments before clicking. If you believe this may be a phishing email, please use the Phish Alert Button.

Hi Pravina,

The Regional Municipality of York has completed its review of the minor variance application – A186/23 (23 Umbria Cr.) and has no comment.

Please provide us with a digital copy of the notice of decision for our records.

Many thanks,

Our working hours may be different. Please do not feel obligated to reply outside of your scheduled working hours. Let's work together to help foster healthy work-life boundaries.

Niranjan Rajevan, M.PI. | Associate Planner, Development Services, Planning and Economic Development, Corporate Services

The Regional Municipality of York | 17250 Yonge Street | Newmarket, ON L3Y 6Z1 1-877-464-9675 ext. 71521 | niranjan.rajevan@york.ca | www.york.ca

Our Values: Integrity, Commitment, Accountability, Respect, Excellence



Our Mission: Working together to serve our thriving communities - today and tomorrow

Please consider the environment before printing this email.

SCHEDULE C: PUBLIC & APPLICANT CORRESPONDENCE						
Correspondence Type	Name	Address	Date Received (mm/dd/yyyy)	Summary		
Applicant				Application Cover Letter		



23 Umbria Crescent

Thursday, November 2nd, 2023 City of Vaughan 2141 Major Mackenzie Dr Vaughan, ON L6A 1T1 Planning & Development Services

Dear Sir/Madam,

Please be advised the following document outlines how each of the comments provided have been addressed.

1. Is the application minor?

The size of the sunroom remains as proposed and presented in the drawing. Despite the reduced rear yard setback, the addition of the sunroom is not anticipated to negatively impact privacy on adjacent properties as it is a single-story addition. A public road connects to the existing building's driveway. The driveway includes approximately 2 parking spaces. Not adversely affecting the privacy or natural lighting of surrounding properties.

- 2. Is the application desirable for the appropriate development of the lands in question? The dwelling will continue to align with the character of the surrounding neighborhood and no major concerns are anticipated to arise as a result of the variance. The sunroom does not negatively impact drainage on the adjacent properties.
 - 3. Does the application conform to the general intent of the Zoning Bylaw?

Proposed rear yard setback of 6.74 m to the unheated sunroom addition does not meet the minimum requirement of 7.5 m. [Table 7-5]

Proposed encroachment of 2.61 m into the minimum required rear yard for access stairs, open and unenclosed, exceeds the maximum permitted encroachment of 1.8 m. [4.13] A minimum setback of 5.7m is required from the lot line to the closest point of the access stairs is required.

4. Will any trees be affected by this project?

No trees will be affected, harmed, or removed during the installation of the sunroom.

Yours truly.
Jim Pitre, P.Eng.
Engineering Director
Lifestyle Home Products

