ITEM: 6.3

REPORT SUMMARY MINOR VARIANCE APPLICATION FILE NUMBER A160/23

Report Date: Friday, January 26, 2024

THIS REPORT CONTAINS COMMENTS FROM THE FOLLOWING DEPARTMENTS & AGENCIES (SEE SCHEDULE B):

Additional comments from departments and agencies received after the publication of the report will be made available on the City's <u>website</u>.

Internal Departments *Comments Received	Conditions Required		Nature of Comments
Committee of Adjustment	Yes □	No ⊠	General Comments
Building Standards (Zoning) *See Schedule B	Yes □	No ⊠	General Comments
Development Planning	Yes □	No □	Application Under Review
Development Engineering	Yes □	No ⊠	General Comments
Forestry	Yes □	No ⊠	General Comments
Fire	Yes □	No ⊠	General Comments

External Agencies *Comments Received	Conditions Required		Nature of Comments *See Schedule B for full comments
Alectra	Yes □	No ⊠	General Comments
TRCA	Yes □	No ⊠	General Comments

PUBLIC & APPLICANT CORRESPONDENCE (SEE SCHEDULE C)

All personal information collected because of this public meeting (including both written and oral submissions) is collected under the authority of the Municipal Act, the Municipal Freedom of Information and Protection of Privacy Act (MFIPPA), the Planning Act and all other relevant legislation, and will be used to assist in deciding on this matter. All personal information (as defined by MFIPPA), including (but not limited to) names, addresses, opinions and comments collected will become property of the City of Vaughan, will be made available for public disclosure (including being posted on the internet) and will be used to assist the Committee of Adjustment and staff to process this application.

Correspondence Type	Name	Address	Date Received (mm/dd/yyyy)	Summary
Applicant		7611 Pine Valley Drive	10/03/2023	Cover Letter
Applicant		7611 Pine Valley Drive	11/10/2023	Planning Justification Report

BACKGROUND (SCHEDULE D, IF REQUIRED)		
* Background Information contains historical development approvals considered to be related to this file. This information should not be considered comprehensive.		
	Application Description (i.e. Minor Variance Application; Approved by COA / OLT)	
A072/21	APPROVED COA	

ADJOURNMENT HISTORY		
* Previous hearing dates where this application was adjourned by the Committee and public notice issued.		
Hearing Date	Reason for Adjournment (to be obtained from NOD_ADJ)	
None	None	

SCHEDULES		
Schedule A	Drawings & Plans Submitted with the Application	
Schedule B	Comments from Agencies, Building Standards & Development Planning	
Schedule C (if required)	Public & Applicant Correspondence	
Schedule D (if required)	Background	



MINOR VARIANCE APPLICATION FILE NUMBER A160/23

CITY WARD #:	3
APPLICANT:	International Missionary Society (Morris Lowe)
AGENT:	International Missionary Society (Han Beom Song)
PROPERTY:	7611 Pine Valley Dr Bldg A, Vaughan
ZONING DESIGNATION:	See below.
VAUGHAN OFFICIAL PLAN	Vaughan Official Plan 2010 ('VOP 2010'): "Mid-Rise Mixed-Use"
(2010) DESIGNATION:	
RELATED DEVELOPMENT	None
APPLICATIONS:	
PURPOSE OF APPLICATION:	Relief from the Zoning By-law is being requested to permit a Place of Worship within a multi-unit building The Place of Worship will be located in Unit 9.

The following variances are being requested from the City's Zoning By-law to accommodate the above proposal:

The subject lands are zoned GMU – General Mixed-Use Zone and subject to the provisions of Exception 14.553 under Zoning By-law 001-2021, as amended.

#	#	Zoning By-law 01-2021	Variance requested
1	1	A Place of Worship is not permitted within a	To permit a Place of Worship within a multi-unit
		multi-unit building [Section 3.0, definition of Place of Worship].	building (Unit 9).
		Place of Worshipj.	

HEARING INFORMATION

DATE OF MEETING: Thursday, February 1, 2024

TIME: 6:00 p.m.

MEETING LOCATION: Vaughan City Hall, Woodbridge Room (2nd Floor), 2141 Major Mackenzie Drive

LIVE STREAM LINK: Vaughan.ca/LiveCouncil

PUBLIC PARTICIPATION

If you would like to speak to the Committee of Adjustment at the meeting, either remotely or in person, please complete the Request to Speak Form and submit to cofa@vaughan.ca

If you would like to submit written comments, please quote file number above and submit by mail or email to:

Email: cofa@vaughan.ca

Mail: City of Vaughan, Office of the City Clerk, Committee of Adjustment, 2141 Major Mackenzie Drive, Vaughan, ON, L6A 1T1

To speak electronically, pre-registration is required by completing the Request to Speak Form on-line and submitting it to cofa@vaughan.ca no later than NOON on the last business day before the meeting.

THE DEADLINE TO REGISTER TO SPEAK ELECTRONICALLY OR SUBMIT WRITTEN COMMENTS ON THE ABOVE NOTED FILE(S) IS <u>NOON</u> ON THE LAST BUSINESS DAY BEFORE THE MEETING.

INTRODUCTION

Staff and Agencies act as advisory bodies to the Committee of Adjustment. The comments contained in this report are presented as recommendations to the Committee.

INTRODUCTION

Section 45(1) of the Planning Act sets the criteria for authorizing minor variances to the City of Vaughan's Zoning By-law. Accordingly, review of the application may consider the following:

That the general intent and purpose of the by-law will be maintained.

That the general intent and purpose of the official plan will be maintained.

That the requested variance(s) is/are acceptable for the appropriate development of the subject lands.

That the requested variance(s) is/are minor in nature.

Approval:

Public written and oral submissions relating to this application are taken into consideration by the Committee of Adjustment as part of its deliberations and final decision on this matter.

Committee of Adjustment as part of its deliberations and final decision on this matter.				
COMMITTEE OF ADJUSTMENT				
Date Public Notice Mailed:	January 18, 2024			
Date Applicant Confirmed Posting of Sign:	January 10, 2024			
Applicant Justification for Variances: *As provided in Application Form	Relief from the Zoning By-law is being requested to permit a Place of Worship within a multi-unit building The Place of Worship will be located in Unit 9.			
Was a Zoning Review Waiver (ZRW) Forn submitted by Applicant: *ZRW Form may be used by applicant in instances where a revised submission is made, and zoning staff do not have an opportunity to review and confirm variances prior to the issuance of public notice.				
COMMENTS: None				
Committee of Adjustment Recommended Conditions of Approval:	None			
BUILDING	STANDARDS (ZONING)			
**See Schedule B for Building Standards (Zo	oning) Comments			
Building Standards Recommended Conditions of Approval:	None			
DEVELOPMENT PLANNING				
**See Schedule B for Development Planning	Comments.			
Development Planning Recommended Conditions of Approval:	TBD			
DEVELOPMENT ENGINEERING				
Link to Grading Permit Link to Pool Permit Development Engineering does not object to	ermit Link to Curb Curt Permit Link Culvert Installation variance application A160/23			
Development Engineering Recommended Conditions of Approval:	None			
PARKS, FORES	TRY & HORTICULTURE (PFH)			
No comments received to date.	,			
PFH Recommended Conditions of Approval:	None			
DEVELOPMENT FINANCE				
No comment no concerns.				
Development Finance Recommended Conditions of Approval:	None			
	E, LICENSING AND PERMIT SERVICES			
No comments received to date.	La			
BCLPS Recommended Conditions of	None			

BUILDING INSPECTION (SEPTIC)		
No comments received to date.		
Building Inspection Recommended Conditions of Approval:	None	

FIRE DEPARTMENT

Questions and concerns:

- this permit is for a change of use from a restaurant to a place of worship. Is it permitted?
- Based on fire code the use will require a fire safety plan to be approved Priore to occupancy.
- Define the occupant load, the note on drawing reads max for whole building 130 persons, posting of occupant load for max on the 2nd floor and 1st floor to be clearly posted.
- Based on notes on drawing maximum occupant load is listed at 130. A fire alarm system would be required if occupant load was 150 or more in total.

Fire Department Reco	ommended	None
Conditions of Approv	al:	

RECOMMENDED CONDITIONS OF APPROVAL SUMMARY

Should the Committee find it appropriate to approve this application in accordance with request and the sketch submitted with the application, as required by Ontario Regulation 200/96, the following conditions have been recommended:

#	DEPARTMENT / AGENCY	CONDITION
1	Development Planning	TBD
	Joshua.cipolletta@vaughan.ca	

All conditions of approval, unless otherwise stated, are considered to be incorporated into the approval "if required". If a condition is no longer required after an approval is final and binding, the condition may be waived by the respective department or agency requesting conditional approval. A condition cannot be waived without written consent from the respective department or agency.

IMPORTANT INFORMATION

CONDITIONS: It is the responsibility of the owner/applicant and/or authorized agent to obtain and provide a clearance letter from respective department and/or agency (see condition chart above for contact). This letter must be provided to the Secretary-Treasurer to be finalized. All conditions must be cleared prior to the issuance of a Building Permit.

APPROVALS: Making any changes to your proposal after a decision has been made may impact the validity of the Committee's decision.

An approval obtained from the Committee of Adjustment, where applicable, is tied to the building envelope shown on the plans and drawings submitted with the application and subject to the variance approval.

A building envelope is defined by the setbacks of the buildings and/or structures shown on the plans and drawings submitted with the application, as required by Ontario Regulation 200/96. Future development outside of an approved building envelope, where a minor variance was obtained, must comply with the provisions of the City's Zoning By-law.

Elevation drawings are provided to reflect the style of roof (i.e. flat, mansard, gable etc.) to which a building height variance has been applied. Where a height variance is approved, building height is applied to the style of roof (as defined in the City's Zoning By-law) shown on the elevation plans submitted with the application.

Architectural design features that are not regulated by the City's Zoning By-law are not to be considered part of an approval unless specified in the Committee's decision.

DEVELOPMENT CHARGES: That the payment of the Regional Development Charge, if required, is payable to the City of Vaughan before issuance of a building permit in accordance with the Development Charges Act and the Regional Development Charges By-law in effect at the time of payment.

That the payment of the City Development Charge, if required, is payable to the City of Vaughan before issuance of a building permit in accordance with the Development Charges Act and the City's Development Charges By-law in effect at the time of payment.

That the payment of the Education Development Charge if required, is payable to the City of Vaughan before issuance of a building permit in accordance with the Development Charges Act and the Boards of Education By-laws in effect at the time of payment

That the payment of Special Area Development charge, if required, is payable to the City of Vaughan before issuance of a building permit in accordance with the Development Charges Act and The City's

IMPORTANT INFORMATION

Development Charge By-law in effect at the time of Building permit issuance to the satisfaction of the Reserves/Capital Department.


NOTICE OF DECISION: If you wish to be notified of the decision in respect to this application or a related Ontario Land Tribunal (OLT) hearing you must complete a Request for Decision form and submit to the Secretary Treasurer (ask staff for details). In the absence of a written request to be notified of the Committee's decision you will **not** receive notice.


SCHEDULE A: DRAWINGS & PLANS



VAUGHAN LOCATION MAP A160/23

7611 Pine Valley Drive Bldg A, Vaughan

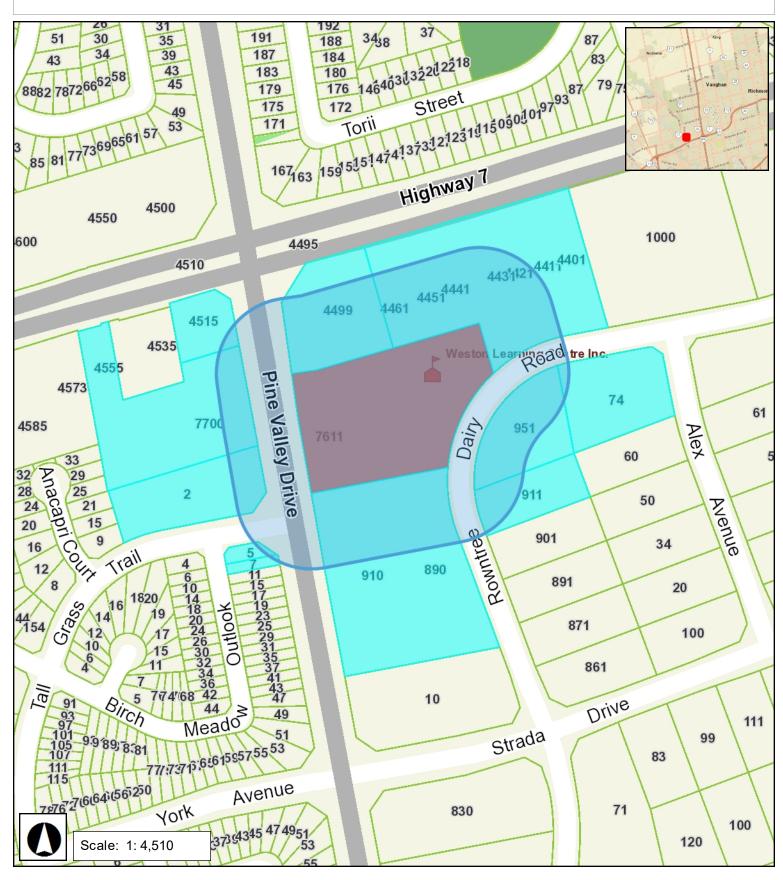

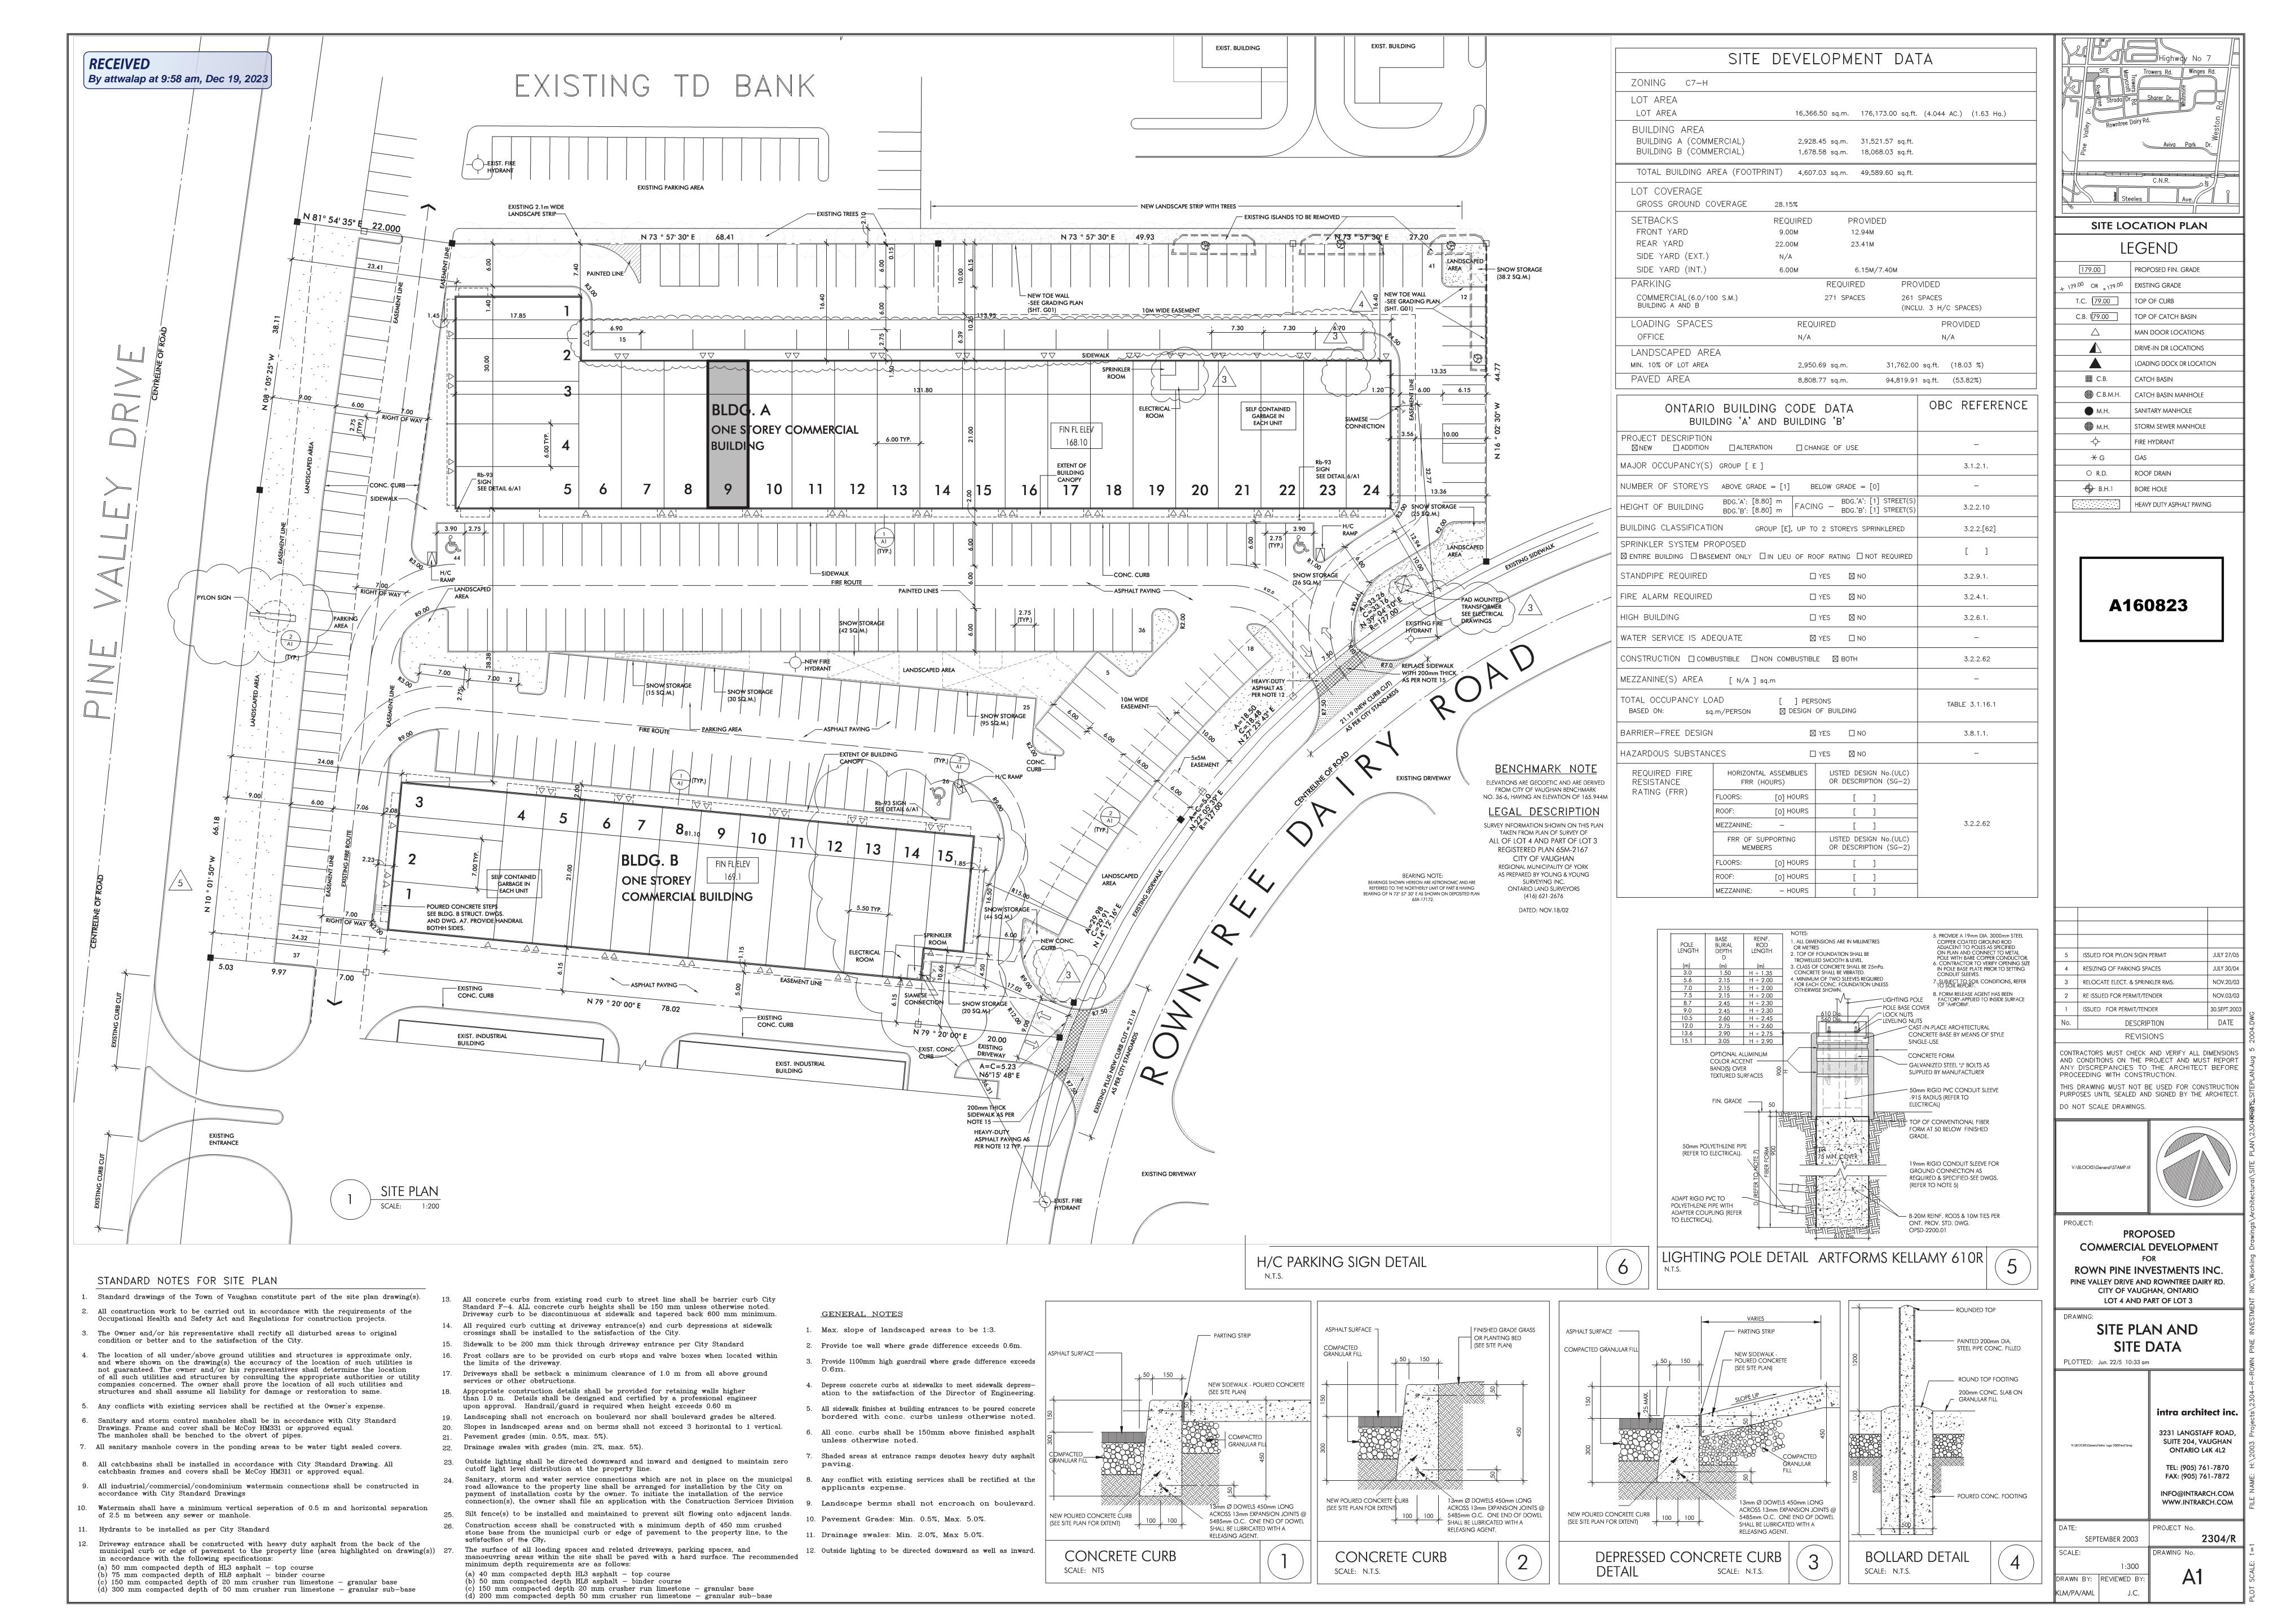

BUILDING CODE SUMMARY

STATISTICS

Lot area: 2,928.45 Sq.M (176,173 Sq.ft.)

Height 1 and 2 storey (facing One street)

Total Building "A" Area: 31, 521.57 Sq.ft (2,928 Sq.m) Total Building "B" Area: 18,068.03 Sq. ft (1,678.58 Sq.m)

Total GFA area of Gr. Fl. for interior alterations for "Place of Worship", 1,356 sq.ft. Maintain GFA Area of 2nd Fl. as Offices for use of "Place of Worship": 1,356 sq,ft.

Ex. Total GFA Area of unit # 9 remain unchanged: 2,712 Sq.Ft.

EXISTING BUILDING OCCUPANCY: Group E RETAIL CONVERT OCCUPANCY TO PLACE OF WORSHIP. Group A2

Group A, Division, up to 2 storeys, increased Area, Sprinklered (3.2.2.26) Group E, up to 3 storeys, Sprinklered (3.2.2.60)

Combustible or Non - Combustible construction

PLUMBING FIXTURE FOR PLACES OF WORSHIP - AS PER 3.7.4.3 (16)

Propsed One unisex WC - Universal Toilet Room on main floor. Existing three unisex WC on Second Floor to remain unchanged

EXTERIOR WALLS CONSTRUCTION Precast Conc. wall (back) and Metal planet fin. (Front) (Existing) SECOND FLOOR CONSTRUCTION: Concrete Floor (to be confirmed) (Existing)

FIRE SEPARATIONS:

- No rating required Roof - 1 Hr fire resistance rating. Floor assemblies

Loadbearing walls - 1 Hr fire resistance rating. (or non combustible const.)

Emergency Lights as per 3.2.7.3 Location of Exits as per 3.4.2.5 Building is Sprinklered

EXITS CAPACITY SCHEDULE							
GROUND FLOOR	E1-1 E1-1	E1-2	CAPACITY	DESIGNED CAPACITY	REMARK		
EXIT DOOR - EX1	36"		144		EXTERIOR DOOR - EXISTING		
EXIT DOOR - EX2	60"		240 N/A		ACCESS TO EXTERIOR DOOR		
EXIT DOOR - DO2	60"		240 N/A	00	ACCESS TO EXTERIOR DOOR		
EXIT DOOR - EX3		41"	164	90	EXTERIOR DOOR - EXISTING		
TOTAL			308				
NON-FIXED SEATS	720, SF. (AT 8 SF. PER PERSON)		90				
TOTAL CAPACITY				90			



		A05 DOOR & PARTIT A06 GENERAL NOTE S01 STRUCTURAL N	S	
	PROJECT INT. ALTERATIONS - NEW SEVENTH -	SCALE:		
ĒD	DAY ADVENTIST CHURCH REFORM MOVEMENT	PROPERTY OWNER:	DRAWING NO. A01	
	7611 PINE VALLEY DRIVE - UNIT 9 VAUGHAN, ONTARIO	DATE: DECEMBER 06,	2023	NORTH:
	DRAWING TITLE COVER PAGE	DRAWN:	CHECKED:	

DRAWING INDEX

A01 COVER PAGE

A04 SECTION AA

A02 GROUND FLOOR PLAN

A03 SECOND FLOOR PLAN

SECOND FLOOR FRAMING PLAN & DETAILS

CONSTRUCTION ACCORDING OBC. ALL DIMENSIONS ARE NOMINAL. REPORT ANY INCONSISTENCIES TO DESIGNER BEFORE COMMENCEMENT OF WORK.

THIS DRAWING IS THE PROPERTY OF THE ARCHITECT AND MAY NOT BE REPRODUCED OR USED WITHOUT EXPRESSED CONSENT OF THE ARCHITECT.

THE CONTRACTOR IS RESPONSIBLE FOR CHECKING AND VERIFYING ALL LEVELS AND DIMENSIONS AND SHALL REPORT ALL DISCREPANCIES TO THE ARCHITECT AND OBTAIN CLARIFICATIONS PRIOR TO COMMENCING WORK

	5 MAX OCCUPANCY REV.	DEC. 06. 2023	EXISTING:
)	4 REVISIONS	MAR. 13. 2020	ASSEMBLY OCCUPAN
Γ	3 ISSUED FOR PERMIT	MAR. 09. 2012	
	2 ISSUED FOR CLIENT	FEB. 06. 2012	PROPOSED:
כ	1 EXISTING LAYOUT	SEP. 21. 2011	PLACE OF WORSHIP
	NO REVISIONS	CH'D DATE	


ASSEMBLY OCCUPANCY RESTAURANT


THESE DOCUMENTS SHALL ONLY BE USED FOR THE PURPOSE INDICATED BELOW WHEN SO NOTE AND INSTALLED BY THE ARCHITECT :

PRELIMINARY

SET NUMBER

SITE PLAN CONTROL **PERMIT**

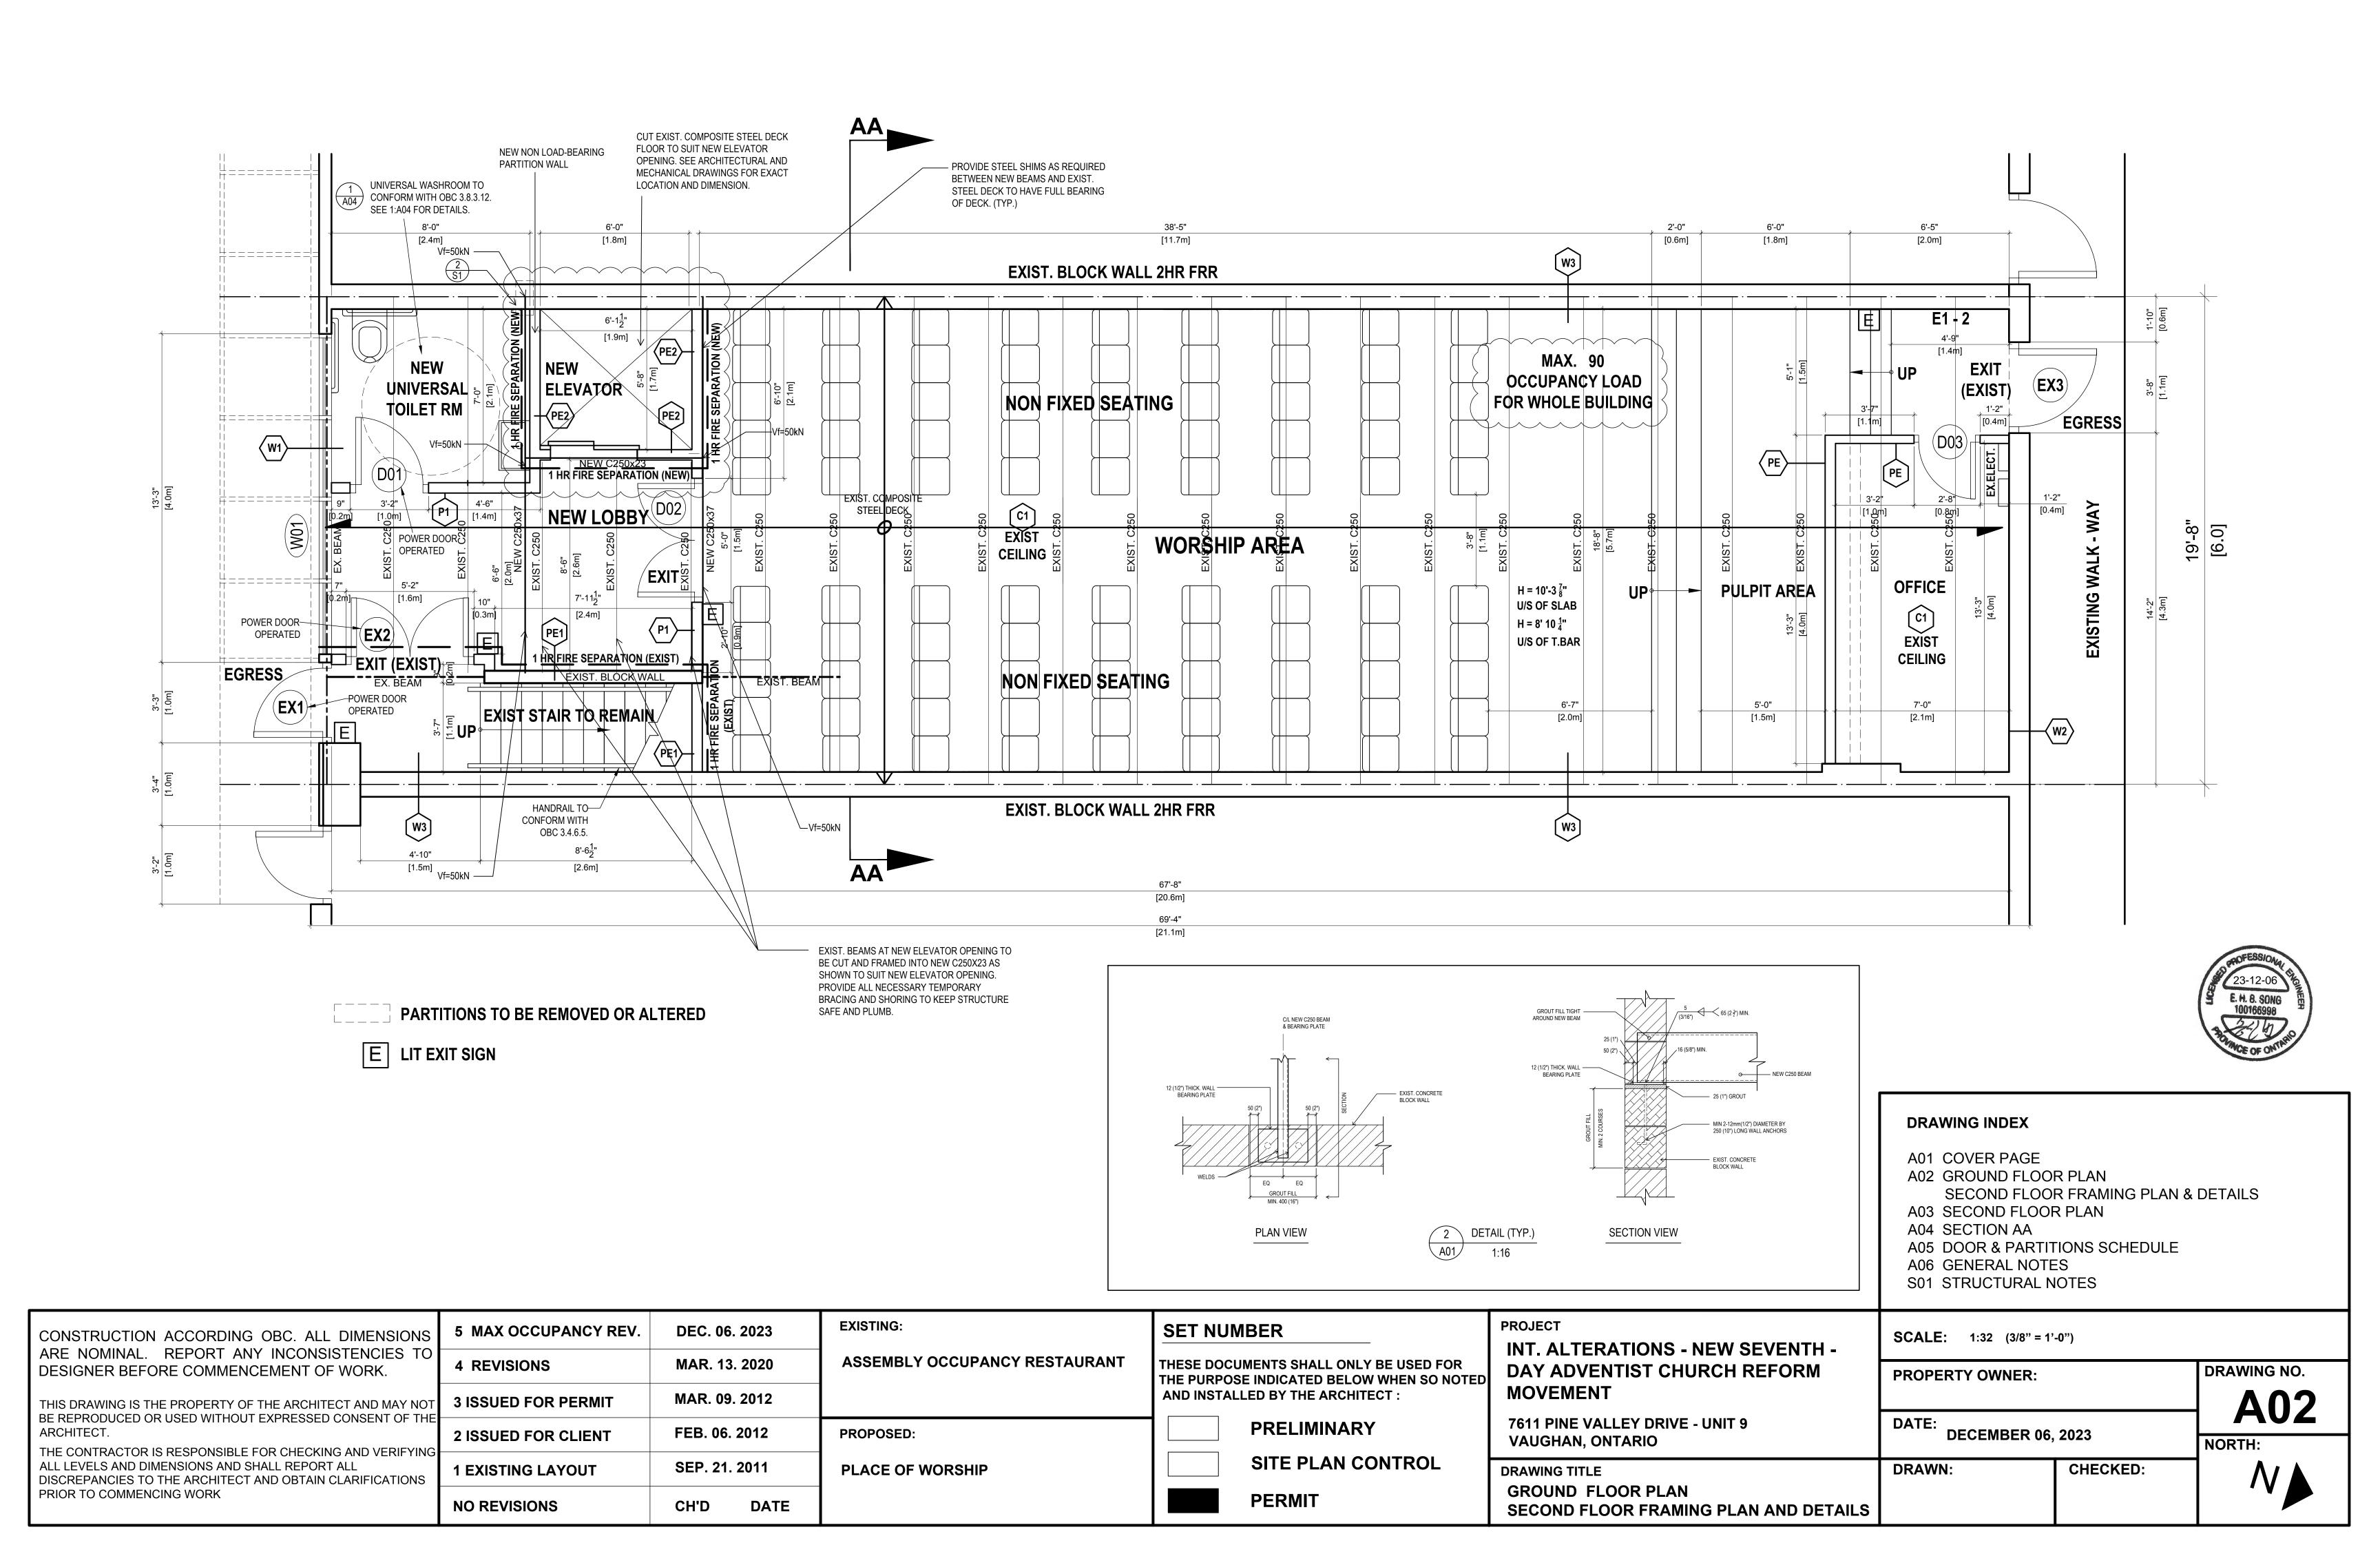

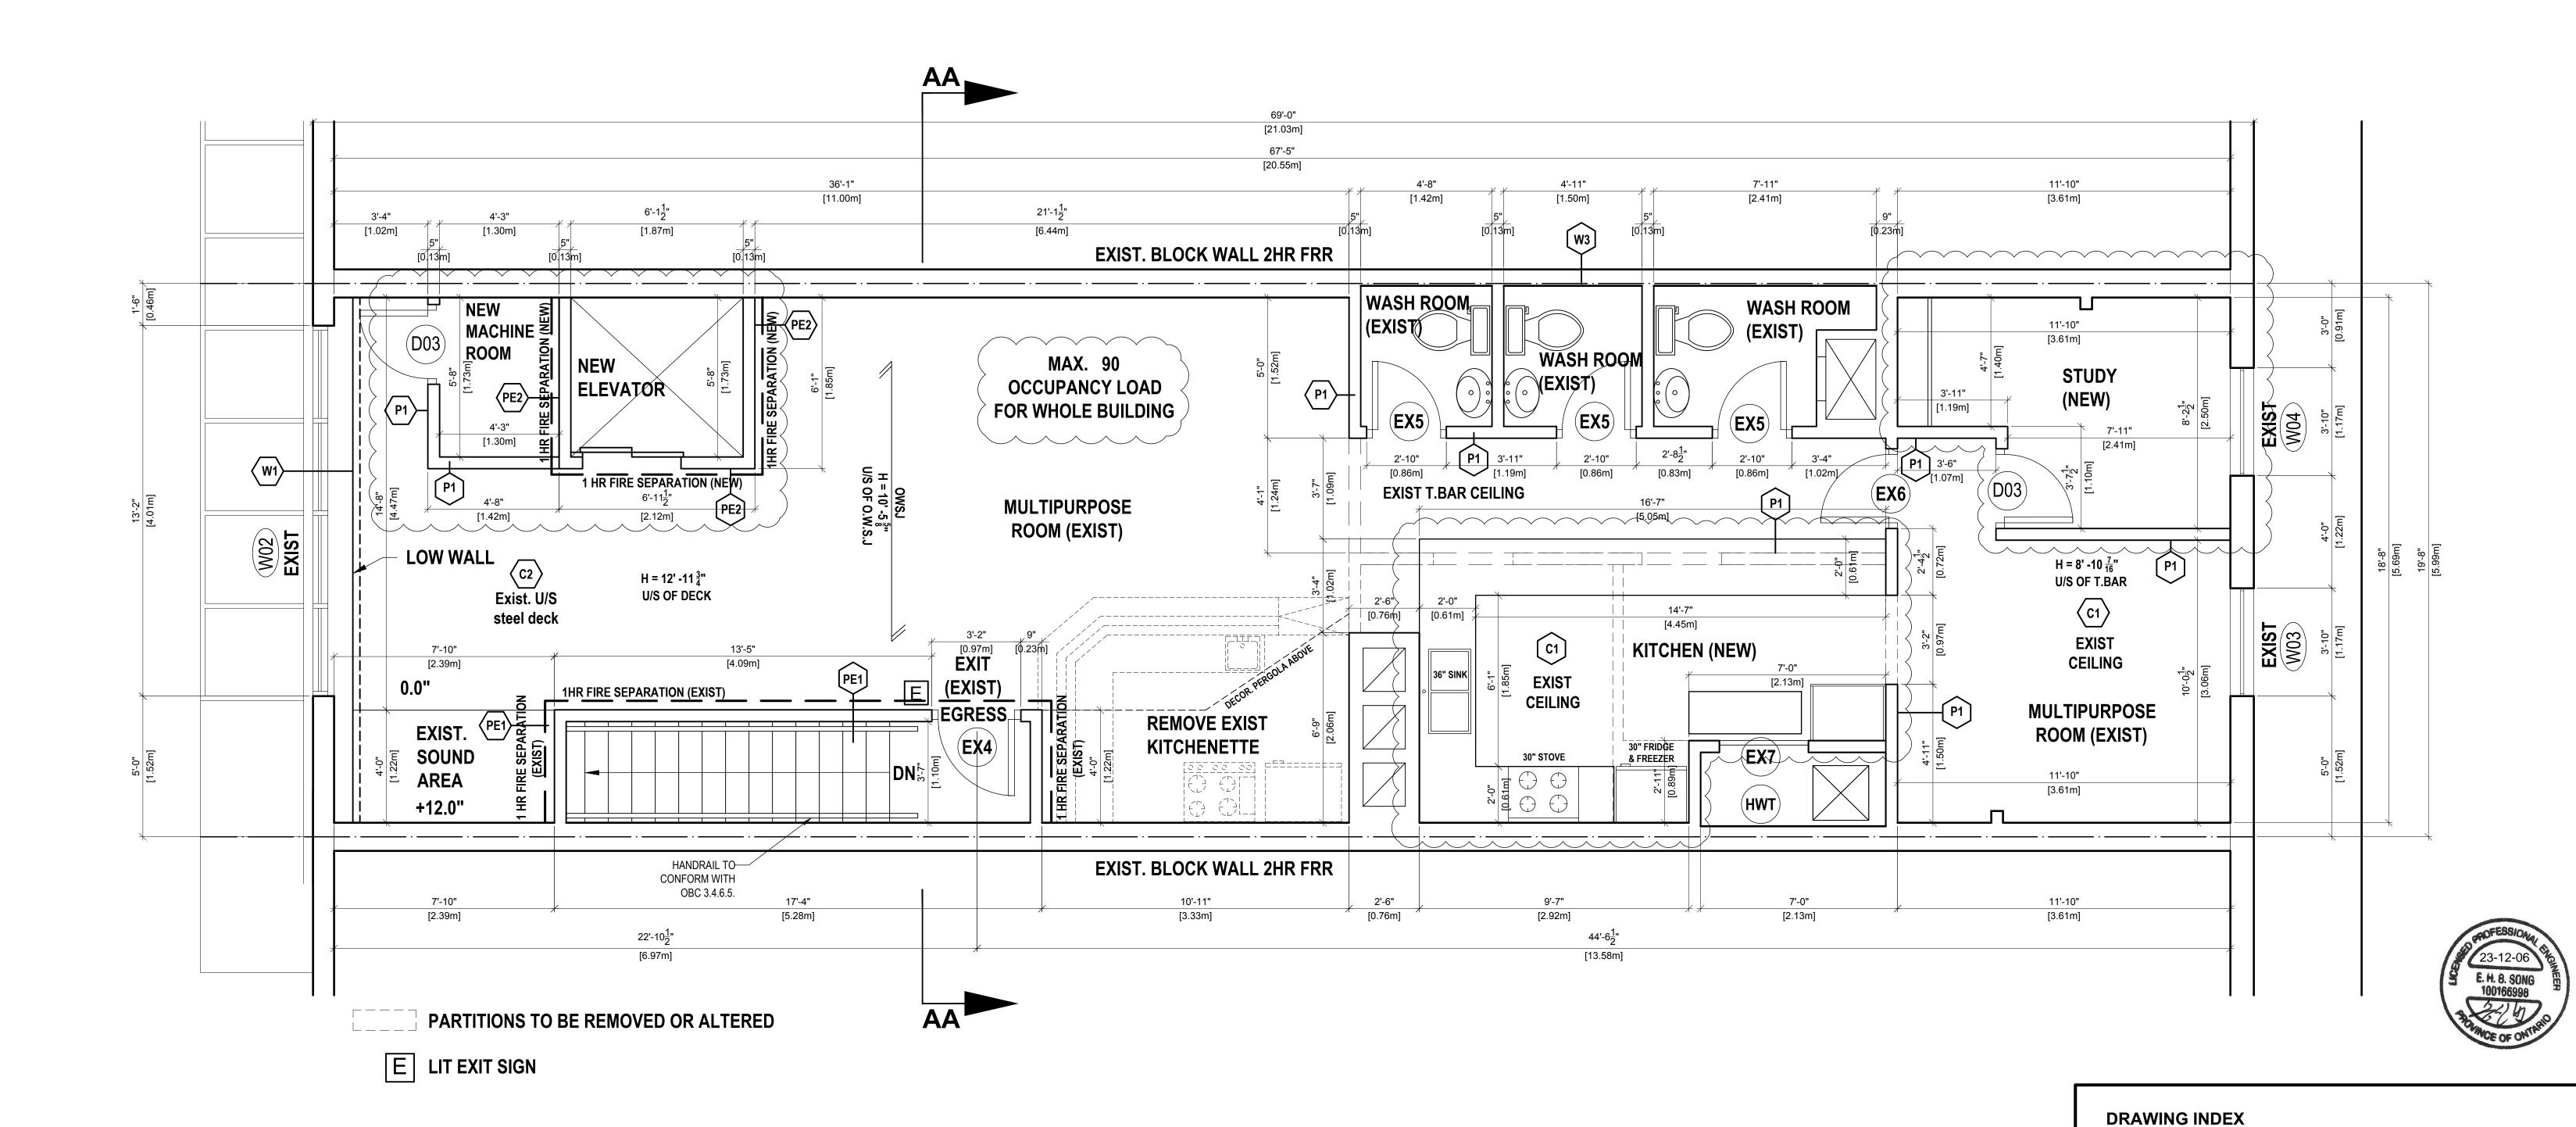

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NS	5 MAX OCCUPANCY REV.	DEC. 06. 2023	EXISTING:	SET
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THE	2 ISSUED FOR CLIENT	FEB. 06. 2012	PROPOSED:] L
NS	1 EXISTING LAYOUT	SEP. 21. 2011	PLACE OF WORSHIP	
	NO REVISIONS	CH'D DATE		

T NUMBER

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PRELIMINARY

SITE PLAN CONTROL **PERMIT**

PROJECT

INT. ALTERATIONS - NEW SEVENTH -DAY ADVENTIST CHURCH REFORM MOVEMENT

IVIO V LIVILIVI	
7611 PINE VALLEY DRIVE - UNIT 9 VAUGHAN, ONTARIO	

7611 PINE VALLEY DRIVE - UNIT 9 VAUGHAN, ONTARIO	

7611 PINE VALLEY DRIVE - UNIT 9 VAUGHAN, ONTARIO
DRAWING TITLE

SECOND FLOOR PLAN

ROOF FRAMING PLAN

DATE: DRAWN:

DRAWING NO. PROPERTY OWNER: **A03 DECEMBER 06, 2023** NORTH:

SECOND FLOOR FRAMING PLAN & DETAILS

A01 COVER PAGE

A04 SECTION AA

A06 GENERAL NOTES


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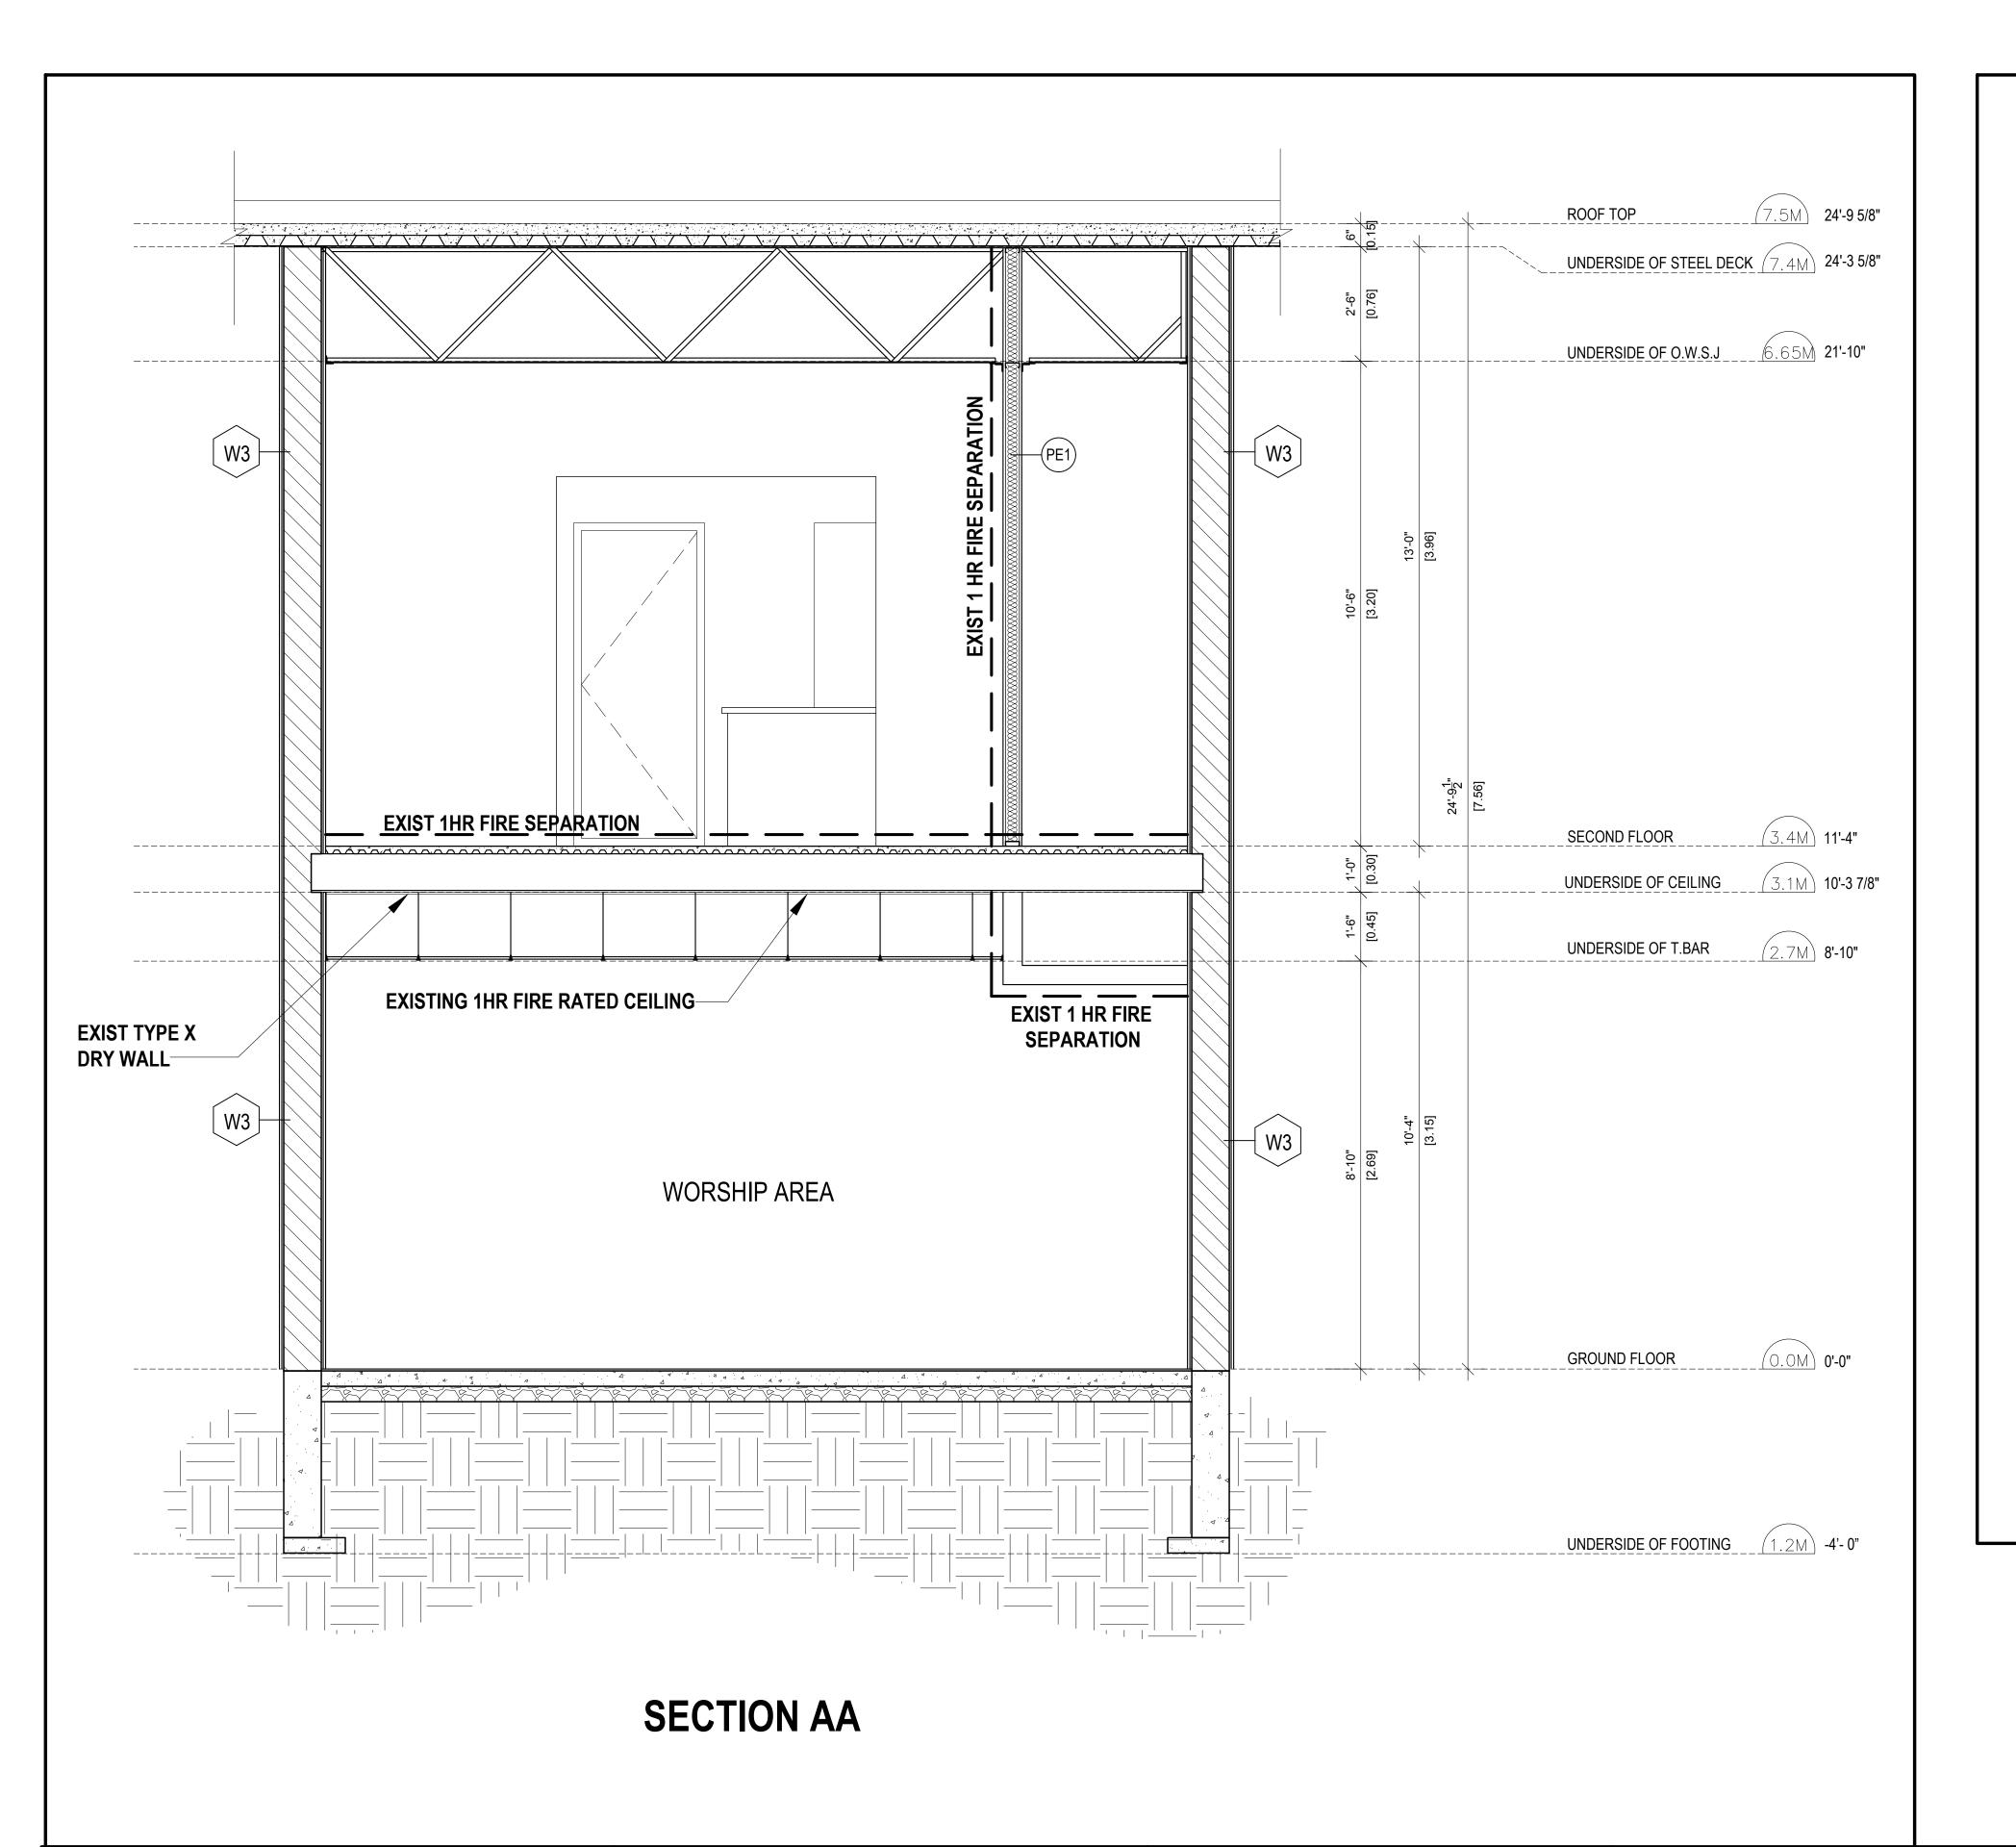
S01 STRUCTURAL NOTES

A02 GROUND FLOOR PLAN

A03 SECOND FLOOR PLAN

A05 DOOR & PARTITIONS SCHEDULE




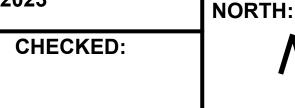



1:A04

GROUND FLOOR UNIVERSAL WASHROOM TO CONFORM WITH OBC 3.8.3.12.

UNIVERSAL WASHROOM DETAILS

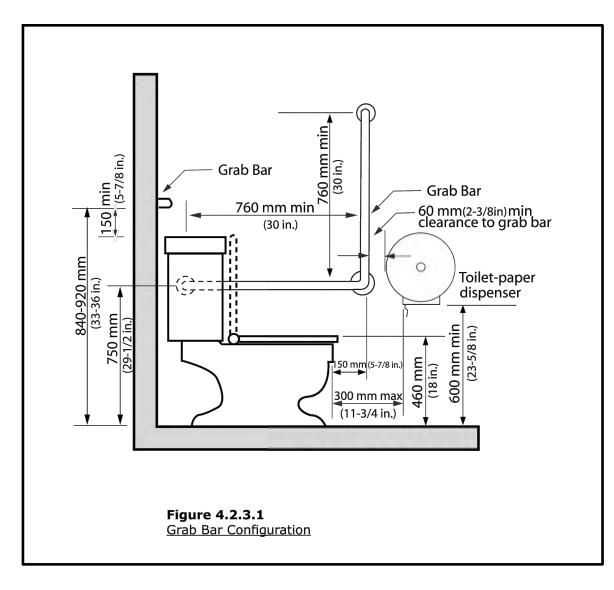

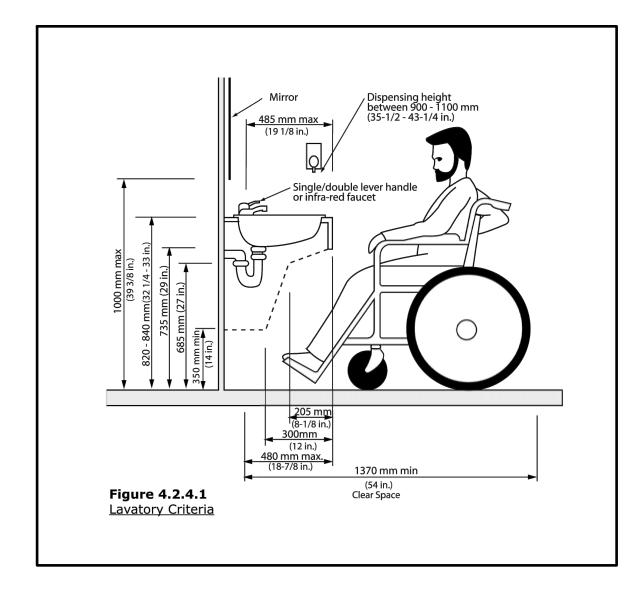

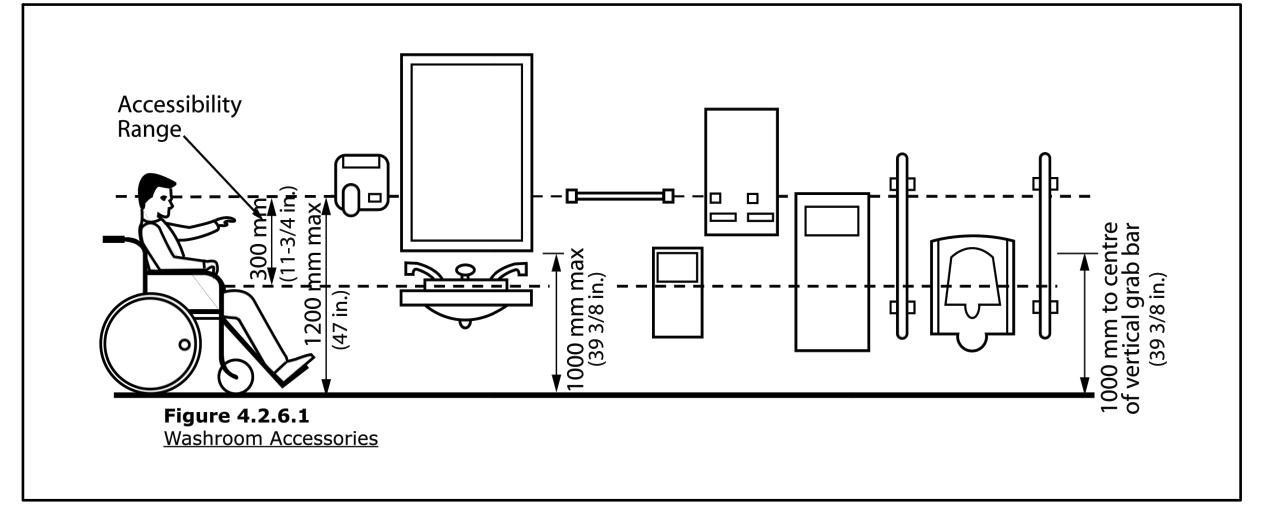



DRAWING INDEX

- A01 COVER PAGE
- A02 GROUND FLOOR PLAN SECOND FLOOR FRAMING PLAN & DETAILS
- A03 SECOND FLOOR PLAN
- A04 SECTION AA
- A05 DOOR & PARTITIONS SCHEDULE
- A06 GENERAL NOTES
- S01 STRUCTURAL NOTES
- **SCALE:** 1:24 (1/2" = 1'-0") INT. ALTERATIONS - NEW SEVENTH -DAY ADVENTIST CHURCH REFORM **PROPERTY OWNER:**

7611 PINE VALLEY DRIVE - UNIT 9

PROJECT

MOVEMENT

DRAWING TITLE

SECTION AA &

VAUGHAN, ONTARIO

UNIVERSAL WASHROOM DETAILS

DATE: MARCH 13, 2020

DRAWN:

NORTH: CHECKED:

DRAWING NO.

THESE DOCUMENTS SHALL ONLY BE USED FOR THE PURPOSE INDICATED BELOW WHEN SO NOTED AND INSTALLED BY THE ARCHITECT :

PRELIMINARY

SITE PLAN CONTROL

THE CONTRACTOR IS RESPONSIBLE FOR CHECKING AND VERIFYING ALL LEVELS AND DIMENSIONS AND SHALL REPORT ALL DISCREPANCIES TO THE ARCHITECT AND OBTAIN CLARIFICATIONS PRIOR TO COMMENCING WORK

CONSTRUCTION ACCORDING OBC. ALL DIMENSIONS

ARE NOMINAL. REPORT ANY INCONSISTENCIES TO

THIS DRAWING IS THE PROPERTY OF THE ARCHITECT AND MAY NOT

BE REPRODUCED OR USED WITHOUT EXPRESSED CONSENT OF THE

DESIGNER BEFORE COMMENCEMENT OF WORK.

ARCHITECT.

SET NUMBER ASSEMBLY OCCUPANCY RESTAURANT 4 REVISIONS MAR. 13. 2020 MAR. 09. 2012 **3 ISSUED FOR PERMIT** FEB. 06. 2012 PROPOSED: **2 ISSUED FOR CLIENT** SEP. 21. 2011 PLACE OF WORSHIP **1 EXISTING LAYOUT NO REVISIONS** CH'D DATE

EXISTING:

PERMIT

DOOR SCHEDULE

EXISTING GROUND FLOOR

- Existing 36" X 7'-0" X 1 3/4" Alum. Glazing Door, to remain on thermally Broken Alum. Frames, existing closer and positive latch to remain. Power door operated.
- Existing 2 x 24" X 7'-0" X 1 3/4" Solid wood doors, to remain on wood frames, existing closer and positive latch to remain. Power door operated.
- Existing 41" X 7'-0" X 1 3/4" Hollow Metal door to remain on Hollow metal frames, existing closer and positive latch to remain. 45 min. FRR.

EXISTING SECOND FLOOR

- Existing 3'-0" X 7'-0" X 1 3/4" Hollow Metal Door, to remain on Hollow Metal Frames, existing closer and positive latch to remain, EX4 45 min. FRR.
- Existing 34" X 7'-0" X 1 3/4" Solid wood doors, to remain on wood frames, existing closer and positive latch to remain.
- Existing 34" X 7'-0" X 1 3/4" Hollow Metal Door, to remain on Hollow Metal Frames, existing closer and positive latch to remain -Office Doors
- Existing 3'-0" X 7'-0" X 1 3/4" Hollow Metal Door, to remain on Hollow Metal Frames, existing closer and positive latch to remain, 45 min FRR. - Furnace Room door

PROPOSED NEW DOORS

DISCREPANCIES TO THE ARCHITECT AND OBTAIN CLARIFICATIONS

PRIOR TO COMMENCING WORK

- Proposed 3'-0" X 7'-0" X 1 3/4" Solid wood door with solid wood frames w/ closer and positive latch H.C door as per 3.8 OBC. Power door operated.
- Proposed 2 x 30" X 7'-0" X 1 3/4" Solid wood door with glass window proposed w/ closer and positive latch Assembly (D02)
- Proposed 32" X 7'-0" X 1 3/4" Solid wood door on wood frames, proposed closer and positive latch storage Door

CH'D

DATE

NO REVISIONS

PARTITIONS TYPES:

- Existing Aluminum & Glass Storefront wall to remain with insulation / studs / GWB (thickness varies)
- Existing exterior Precast concrete wall to remain with insulation / studs / GWB (thickness varies)
- Existing Concrete Block Demising wall to remain with GWB on each side 2 hr FRR to remain.
- Existing 1/2" gypsum wall board, on each side of 3 5/8" steel studs @ 16" O.C thickness varies
- Existing 5/8" type 'X' gypsum wall board, on each side of 3 5/8" steel studs @ 16" O.C 1 hr Fire Rating to remain as per PE1 **ULC W407**
- New 5/8" type 'X' gypsum wall board, on each side of 3 5/8" steel studs @ 16" O.C 1 hr Fire Rating to remain as per ULC PE2
- Proposed 1/2" gypsum wall board on each side of 3 5/8" steel studs @ 16" O.C thickness varies, Provide sound insulation if required by Client.

CEILING TYPE AT GR. FL 2ND FL. AT OFFICES AND WC AREA

Existing T- Bar ceiling to remain at 8'- 10" height throughout the entire floor - repair / replace when required

CEILING TYPE AT 2ND FL. MULTI - PURPOSE ROOM

DOOR & PARTITIONS SCHEDULE

Existing exposed (painted) steel deck and OWSJ to remain throughout the entire Room - Repair / Replace when required. approx. height of 12'-11" to remain

DRAWING INDEX

A01 COVER PAGE

A02 GROUND FLOOR PLAN

SECOND FLOOR FRAMING PLAN & DETAILS



						A03 SECOND FLOO A04 SECTION AA A05 DOOR & PARTI A06 GENERAL NOT S01 STRUCTURAL	TIONS SCHEDULE ES	
CONSTRUCTION ACCORDING OBC. ALL DIMENSIONS ARE NOMINAL. REPORT ANY INCONSISTENCIES TO			EXISTING:	SET NUMBER	PROJECT INT. ALTERATIONS - NEW SEVENTH -	SCALE:		
DESIGNER BEFORE COMMENCEMENT OF WORK.	4 REVISIONS	MAR. 13. 2020	ASSEMBLY OCCUPANCY RESTAURANT	THESE DOCUMENTS SHALL ONLY BE USED FOR THE PURPOSE INDICATED BELOW WHEN SO NOTED	DAY ADVENTIST CHURCH REFORM	PROPERTY OWNER:		DRAWING NO.
THIS DRAWING IS THE PROPERTY OF THE ARCHITECT AND MAY NOT	3 ISSUED FOR PERMIT	MAR. 09. 2012		AND INSTALLED BY THE ARCHITECT :	MOVEMENT			A05
BE REPRODUCED OR USED WITHOUT EXPRESSED CONSENT OF THE ARCHITECT.	2 ISSUED FOR CLIENT	FEB. 06. 2012	PROPOSED:	PRELIMINARY	7611 PINE VALLEY DRIVE - UNIT 9 VAUGHAN, ONTARIO	DATE: MARCH 13, 202	0	NORTH:
THE CONTRACTOR IS RESPONSIBLE FOR CHECKING AND VERIFYING ALL LEVELS AND DIMENSIONS AND SHALL REPORT ALL	1 EXISTING LAYOUT	SEP. 21. 2011	PLACE OF WORSHIP	SITE PLAN CONTROL	DRAWING TITLE	DRAWN:	CHECKED:	

PERMIT

GENERAL NOTES:

GENERAL

IN THE EVENT OF CONFLICT BETWEEN CONTENT OF DRAWINGS AND THE CONSTRUCTION NOTES, CONTRACTOR SHALL NOTIFY ARCHITECT IN WRITING DISCREPANCIES IN THE DOCUMENTS PRIOR TO COMMENCEMENT OF THE WORK.

Workmanship and materials shall be in accordance with requirements of latest issue of Ontario Building Code, CSA specifications, NBC, Industrial Safety Act, Public Health Act, Ontario Fire Code, Manufacturer's Instructions and Applicable Regulations of Authorities having Jurisdiction.

Protect property and work, materials and existing construction. Keep work site free of debris during construction, clean finished work on completion, remove debris from site

SELECTION OF TYPES AND QUALITY OF PRODUCTS TO BE USED IN THE CONSTRUCTION ARE TO BE AGREED BETWEEN THE OWNER AND THE CONTRACTOR. THE ARCHITECT ASSUMES NO RESPONSIBILITY AS TO THE CHOICE OF MATERIAL USED AND RELATED INSTALLATION PROCEDURES. ALL MATERIALS NOTED HEREIN ARE TO BE INSTALLED IN ACCORDANCE WITH THE MANUFACTURES SPECIFICATIONS AND RECOMMENDATIONS.

Use materials as specified or equals all to be approved by Architect and/or Owner.

All service penetrations (piping, ducts, cables, etc.) through fire separations (floors, stairs, shafts, wall, etc.) shall be protected at the penetration by tight—fitting or stop material of same degree of fire resistance rating as the fire separation itself

All ductwork penetrations through rated separations shall further protected at the penetrations by fire dampers.

The General Contractor shall check and verify all dimensions.

Do not scale drawings. The General Contractor shall report all errors and omissions on these drawings and specifications to Owner and/or Architect prior to construction or fabrication of the work.

The general intent is that the respective trade shall supply and install all materials required to complete his part of the work. Items obviously required to satisfy the intent of the contract documents whether or not indicated on the drawings or specifications, shall be included.

All alternatives (construction or materials) to be approved by the Owner before commencement of the work. The general contractor to provide samples and/or technical literature to the Owner regarding alternative desired.

Installations of damaged or otherwise non—conforming material will not be accepted.

Use all means necessary to protect the installed work and materials of all other trades.

In the event of damage, immediately make all repairs and replacement necessary to the approval of the Owner, and of no additional cost to the Owner.

Individual sub-trades ore responsible for inspecting installed work of other trades to verify that all such work is complete to the point that their own work may properly commence.

General Contractor is to coordinate all dimensions in regards to selected fixtures and schedules.

SEALANTS

Clear silicone up all edges where wall covering meets molding, vanities, sinks, etc.

PAINTING

Provide appropriate primer (necessary coats) before applying minimum of two coats of paint (colour to owner's choice)

METAL STUDS

All metal studs and accessories shall be galvanized steel.

Studs and runners shall be channel type formed 25 gauge, size as noted on the drawings.

Accurately layout all partitions and wall lines from the dimensions and details plans as shown.

Space studs at maximum 16" on center, coordinate requirements for backing support for wall mounted items and make allowance for other items such as piping and work of other trades within the partition.

Securely stabilize all partitions to horizontal structural members so as to fully eliminate potential partition movement. system.

All gypsum wall board shall be the product of one manufacture, shall be tapered edge for finished surfaces and butt edge for concealed surfaces.

All fasteners to be metal screws designed for application of G.W.B. to metal studs.

All metal corner, head, trim and all necessary items shall be as per recommended by the manufacturer.

SHOP DRAWINGS + INTERIOR DESIGN DRAWINGS FROM TENANT

General Contractor to provide Shop Drawings if required for Tender Submissions and coordinate with all Interior Design Drawings from "Seventh—Day Adventist"

DEMOLITION:

Clontractor to remove interior finishes as per Architect's or Tenant instructions Contractor is to repare and prepare the removed surfaces for the new proposed finish and if necessary replace the entire back-up material before applying the new finish. This item applies for all walls, ceilings, floors and doors to be re-used or new. Support all items within ceiling space.

DRAWING INDEX

A01 COVER PAGE

A04 SECTION AA

A02 GROUND FLOOR PLAN

A03 SECOND FLOOR PLAN

A05 DOOR & PARTITIONS SCHEDULE

SECOND FLOOR FRAMING PLAN & DETAILS



						A06 GENERAL NOTE S01 STRUCTURAL N		
CONSTRUCTION ACCORDING OBC. ALL DIMENSIONS ARE NOMINAL. REPORT ANY INCONSISTENCIES TO			EXISTING:	SET NUMBER	PROJECT INT. ALTERATIONS - NEW SEVENTH -	SCALE:		
	4 REVISIONS	MAR. 13. 2020	ASSEMBLY OCCUPANCY RESTAURANT	THESE DOCUMENTS SHALL ONLY BE USED FOR THE PURPOSE INDICATED BELOW WHEN SO NOTED	DAY ADVENTIST CHURCH REFORM	PROPERTY OWNER:		DRAWING NO.
	3 ISSUED FOR PERMIT	MAR. 09. 2012		AND INSTALLED BY THE ARCHITECT :	MOVEMENT			A06
BE REPRODUCED OR USED WITHOUT EXPRESSED CONSENT OF THE ARCHITECT.	2 ISSUED FOR CLIENT	FEB. 06. 2012	PROPOSED:	PRELIMINARY	7611 PINE VALLEY DRIVE - UNIT 9	DATE: MARCH 13, 2020	·O	
THE CONTRACTOR IS RESPONSIBLE FOR CHECKING AND VERIFYING	2 1000LD 1 OK 02.12.K1			CITE DI ANI CONTROI	VAUGHAN, ONTARIO			NORTH:
ALL LEVELS AND DIMENSIONS AND SHALL REPORT ALL DISCREPANCIES TO THE ARCHITECT AND OBTAIN CLARIFICATIONS	1 EXISTING LAYOUT	SEP. 21. 2011	PLACE OF WORSHIP	SITE PLAN CONTROL	DRAWING TITLE	DRAWN:	CHECKED:	
PRIOR TO COMMENCING WORK	NO REVISIONS	CH'D DATE		PERMIT	GENERAL NOTES			

DESIGN CRITERIA NOTES:

- 1. TOP OF ALL TRIMMING STEEL AT UNDERSIDE OF STEEL DECK.
- 2.NEW OPENING FRAMES ARE DESIGNED FOR THE FOLLOWING LOADS (MAX.)
- SDL=1.5kPa
- LIVE=4.8kPa
- 3. LOCATION OF OPENING THROUGH FLOOR IS BASED ON INFORMATION SHOWN
- ON ARCHITECTURAL DRAWINGS. THE STRUCTURAL STEEL SUB-CONTRACTOR MUST CONFIRM ALL THESE DIMENSIONS AND SIZES WITH THE ARCHITECT.
- 4. IF ACTUAL LOCATIONS OR DETAILS VARY FROM THOSE SHOWN. THE STRUCTURAL CONSULTANT MUST BE INFORMED AND INSTRUCTIONS RECEIVED BEFORE PROCEEDING WITH THE WORK.

GENERAL NOTES:

- 1. DESIGN AND CONSTRUCTION IS TO CONFORM TO THE REQUIREMENTS OF THE 2012 ONTARIO BUILDING CODE, AND ANY APPLICABLE REQUREMENTS OR BY-LAW OF THE AUTHORITY HAVING JURISDICTION. REFER ALSO TO TYPICAL DETAILS. NOTES UNDER PLANS AND SCHEDULES ON THE STRUCTURAL DRAWINGS. AND TO THE SPECIFICATION.
- ALL DIMENSIONS, OTHER THAN PURELY STRUCTURAL DIMENSIONS SHOWN ON THE STRUCTURAL DRAWINGS MUST BE CHECKED AGAINST THE ARCHITECTURAL DRAWINGS AND ANY INCONSISTENCIES REPORTED TO THE ARCHITECT BEFORE PROCEEDING WITH THE WORK. STRUCTURAL DRAWINGS MUST NOT BE SCALED.
- 2. REFER TO ARCHITECTURAL, MECHANICAL AND ELECTRICAL DRAWINGS FOR LOCATIONS AND SIZES OF OPENINGS, TRENCHES, PITS, SUMPS, EQUIPMENT, SLEEVES, DEPRESSIONS, GROOVES AND CHAMFERS NOT INDICATED ON THE STRUCTURAL DRAWINGS. UNLESS SPECIFICALLY NOTED OTHERWISE, THE ABOVE ITEMS WHERE SHOWN ON THE STRUCTURAL DRAWINGS ARE INDICATED ONLY APPROXIMATELY AS TO SIZE AND LOCATION.
- 3. UNLESS SPECIFICALLY NOTED OTHERWISE ON THE DRAWINGS, NO PROVISION HAS BEEN MADE IN THE DESIGN FOR CONDITIONS OCCURRING DURING CONSTRUCTION. THE CONTRACTOR IS TO PROVIDE ALL NECESSARY BRACING AND SHORING REQUIRED FOR STRESSES AND INSTABILITY OCCURRING FROM ANY CAUSE DURING CONSTRUCTION. THE CONTRACTOR SHALL ACCEPT FULL RESPONSIBILTY FOR ALL SUCH MEASURES. IT SHALL ALSO BE THE RESPONSIBLITY OF THE CONTRACTOR TO PROVIDE ALL NECESSARY BRACING, SHORING, SHEET PILING OR OTHER TEMPORARY SUPPORTS OF SAFEGUARD ALL EXISTING OR ADJACENT STRUCTURES AFFECTED BY THIS WORK, CONTRACTOR TO PROVIDE SHOP DRAWINGS FOR CONSULTANTS REVIEW.

NO REVISIONS

CH'D

DATE

STEEL NOTES:

AND ERECTION.

- 1. STRUCTURAL STEEL DESIGN DETAILS AND CONNECTIONS SHALL CONFORM TO CSA STANDARD S16 AND SHALL BE DESIGNED BY A PROFESSIONAL ENGINEER EXPERIENCED IN THIS TYPE OF WORK.
- 2. WELDING SHALL CONFORM TO CSA STANDARD W59 AND BE PERFORMED BY A FABRICATOR CERTIFIED TO CSA W47.1. 3. BEAM CONNECTIONS SHALL BE DESIGNED FOR A MINIMUM OF FACTORED VERTICAL SHEAR FORCE OF 50% OF THE BEAM SHEAR CAPACITY. UNLESS OTHERWISE NOTED, AND IN NO CASE BE LESS THAN THE LOADS SHOWN ON OR IMPLIED BY THE DRAWINGS. WHERE BOLTED CONNECTINS ARE UTILIZED, A MINIMUM OF TWO BOLTS PER CONNECTION SHALL BE USED. 4. MEMBER CONNECTIONS SHALL BE DESIGNED BY A LICENSED PROFESSIONAL ENGINEER FOR FORCES AND MOMENTS INDICATED. SHOP DRAWINGS [AND CALCULATIONS] BEARING THE STAMP AND SIGNATURE OF THE REGISTERED PROFESSIONAL ENGINEER RESPONSIBLE FOR THE DESIGN SHALL BE SUBMITTED FOR REVIEW PRIOR TO FABRICATION
- 5. STRUCTURAL STEEL SECTIONS SHALL CONFORM TO CSA-G40.20/G40.21
- 5.1.S SHAPES, CHANNELS, ANGLES, PLATES AND RODS: GRADE 300 W
- 6. BOLTS FOR CONNECTIONS TO CONFORM TO ASTM F3125/3125M, GRADE A325 OR A325M, UNLESS NOTED. 7. ANCHOR RODS FOR BASE PLATES, BEARING PLATES AND WELD PLATES TO CONFORM TO ASTM F1554, GRADE 36, UNLESS NOTED.
- 8. NUTS AND WASHERS TO CONFORM TO ASTM A563 AND ASTM F436.
- 9. WELDING MATERIALS TO CONFORM TO CSA W48.
- 10. SURFACE PREPARATION AND PRIMER PAINT FOR STRUCTURAL STEEL MEMBERS INSIDE VAPOUR BARRIER TO CONFORM
- TO CISC/CPMA 1.73a OR CISC/CPMA 2.75 (IF EXPOSED TO VIEW), UNLESS NOTED ON DRAWINGS OR SPECIFICATIONS
- 11. FABRICATION, HANDLING AND ERECTION TO CONFORM TO CAN/ CSA S16.
- 12. PROVIDE A MINIMUM OF 2-12 mm (1/2") DIAMETER BY 250 (10") LONG WALL ANCHORS FOR ALL BEAM AND JOIST WALL PLATES ON MASONRY, OR AN APPROVED EQUAL, UNLESS OTHERWISE NOTED. BEAMS AND JOIST SHOES TO BE WELDED TO BEARING PLATES.
- 13. PROVIDE ADJUSTABLE ANCHORS TO ALL STEEL TO BE BUILT INTO, ABUTTED BY, OR FACED WITH MASONRY (REFER ALSO TO TYPICAL DETAILS IF SHOWN). SPACING OF ANCHORS TO BE:
- .. 600 (24") MAX. CENTRES. FOR VERTICAL SPACING
- 10 TIMES WALL THICKNESS* (MAX. 2000 (6'-8") CENTRES) FOR HORIZONTAL SPACING
- (* NOTE, USE BACK-UP WYTHE THICKNESS ONLY, FOR CAVITY WALLS.)
- 14. WHERE STEEL PROVIDES LATERAL BRACING ONLY TO MASONRY (I.E. DOES NOT SUPPORT MASONRY) ANCHORS SHALL PERMIT DIFFERENTIAL VERTICAL MOVEMENT BETWEEN STRUCTURAL MEMBERS AND MASONRY.
- 15. PROVIDE L76X76X6.4(MIN) ANGLE SEATS FOR ALL STEEL DECK AT LOCATIONS WHERE THE CONNECTION TO SUPPORTING FRAMING IS INTERRUPTED. (EG. AT COLUMNS)
- 16. CLEAN, PREPARE SURFACES AND SHOP PRIME STRUCTURAL STEEL WITH ONE COAT OF SPECIFIED PRIMER PAINT IN ACCORDANCE WITH CAN/CSA - S16, EXCEPT WHERE MEMBERS ARE TO BE ENCASED IN CONCRETE, OR TO RECEIVE SPRAY APPLIED FIRE PROOFING. FIELD "TOUCH-UP" BOLTS, WELDS, BURNED OR SCRAPED SURFACES AFTER ERECTION.
- 17. PROVIDE ALL NECESSARY TEMPORARY BRACING TO KEEP STRUCTURE SAFE AND PLUMB. BRACING SHOWN ON STRUCTURAL DRAWINGS IS PERMANENT FOR FINISHED BUILDING ONLY.
- 18. CO-ORDINATE WITH MECHANICAL AND ELECTRICAL CONSULTANTS AND SUB-TRADES WHOSE WORK MAY AFFECT DETAILING, FABRICATION AND ERECTION OF THE STEEL STRUCTURE.
- 19. TOLERANCES: VARIATION FROM PLUMB AND LEVEL EXTERIOR COLUMNS, COLUMNS AT ELEVATOR SHAFTS, AND SPANDREL BEAMS INCLUDING ANGLES.1:1000 MAX. 25 mm (1/8" IN 10'-0" MAX. 1")
- ...1:500 (1/4" IN 10'-0") OTHER PIECES.
- 20. NO HOLES OTHER THAN THOSE SHOWN ON REVIEWED SHOP DRAWINGS SHALL BE MADE IN ANY STEEL MEMBER WITHOUT WRITTEN PERMISSION OF THE STRUCTURAL CONSULTANT.

MASONRY NOTES:

- 1. GROUT TO CONFORM TO REQUIREMENTS OF CSA STANDARD A179-M CLAUSE 8.1 TABLE 3 "FINE GROUT". SLUMP SHALL BE ±200mm AND COMPRESSIVE STRENGTH SHALL BE A MINIMUM OF 15 MPa @ 28 DAYS. NOTE: MORTAR IS NOT ACCEPTABLE FOR USE AS GROUT.
- 2. ALL CELLS CONTAINING VERTICAL REINFORCING SHALL BE COMPLETELY FILLED WITH GROUT IN LIFTS NOT EXCEEDING 2400mm.GROUT SHALL BE CONSOLIDATED BY PUDDLING OR VIBRATING DURING POURING.



DRAWING INDEX

A01 COVER PAGE

A04 SECTION AA

A02 GROUND FLOOR PLAN

A03 SECOND FLOOR PLAN

SECOND FLOOR FRAMING PLAN & DETAILS

						A05 DOOR & PARTI A06 GENERAL NOT S01 STRUCTURAL N	ES	
ONSTRUCTION ACCORDING OBC. ALL DIMENSIONS			EXISTING:	SET NUMBER	PROJECT INT. ALTERATIONS - NEW SEVENTH -	SCALE:		
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IOR TO COMMENCING WORK	NO REVISIONS	CH'D DATE		PERMIT	STRUCTURAL NOTES			

SCHEDULE B: COMMENTS FROM AGENCIES, BUILDING STANDARDS & DEVELOPMENT PLANNING

Department / Agency *Comments Received	Conditions Required		Nature of Comments
Building Standards (Zoning) *See Schedule B	Yes □	No ⊠	General Comments
Development Planning	Yes □	No □	Application Under Review

External Agencies *Comments Received	Conditions Required		Nature of Comments *See Schedule B for full comments
Alectra	Yes □	No ⊠	General Comments
TRCA	Yes □	No ⊠	General Comments



Date: October 12th 2023

Attention: Christine Vigneault

RE: Request for Comments

File No.: A160-23

Related Files:

Applicant International Missionary Society of Seventh Day Adventists Reform

Movement Canadian Union

Location 7611 Pine Valley Drive, Unit 9



COMMENTS:

	We have reviewed the proposed Variance Application and have no comments or objections to its approval.
X	We have reviewed the proposed Variance Application and have no objections to its approval, subject to the following comments (attached below).
	We have reviewed the proposed Variance Application and have the following concerns (attached below).

Alectra Utilities (formerly PowerStream) has received and reviewed the proposed Variance Application. This review, however, does not imply any approval of the project or plan.

All proposed billboards, signs, and other structures associated with the project or plan must maintain minimum clearances to the existing overhead or underground electrical distribution system as specified by the applicable standards, codes and acts referenced.

In the event that construction commences, and the clearance between any component of the work/structure and the adjacent existing overhead and underground electrical distribution system violates the Occupational Health and Safety Act, the customer will be responsible for 100% of the costs associated with Alectra making the work area safe. All construction work will be required to stop until the safe limits of approach can be established.

In the event construction is completed, and the clearance between the constructed structure and the adjacent existing overhead and underground electrical distribution system violates the any of applicable standards, acts or codes referenced, the customer will be responsible for 100% of Alectra's cost for any relocation work.

References:

- Ontario Electrical Safety Code, latest edition (Clearance of Conductors from Buildings)
- Ontario Health and Safety Act, latest edition (Construction Protection)
- Ontario Building Code, latest edition (Clearance to Buildings)
- PowerStream (Construction Standard 03-1, 03-4), attached
- Canadian Standards Association, latest edition (Basic Clearances)

If more information is required, please contact either of the following:

Mr. Stephen Cranley, C.E.T

Supervisor, Distribution Design, ICI & Layouts (North)

Phone: 1-877-963-6900 ext. 31297

E-mail: stephen.cranley@alectrautilities.com

Mitchell Penner

Supervisor, Distribution Design-Subdivisions

Phone: 416-302-6215

Email: Mitchell.Penner@alectrautilities.com



Power Stream 1

Construction Standard

03-1

	SYSTEM VOLTAGE				
LOCATION OF WIRES, CABLES OR CONDUCTORS	SPAN GUYS AND COMMUNICATIONS WIRES		4.16/2.4kV TO 27.6/16kV (SEE NOTE 1)	44kV	
	MINIMUM VERTICAL CLEARANCES (SEE NOTE 2)				
OVER OR ALONGSIDE ROADS, DRIVEWAYS OR LANDS ACCESSIBLE TO <u>VEHICLES</u>	442cm	442cm	480cm	520cm	
OVER GROUND ACCESSIBLE TO PEDESTRIANS AND BICYCLES ONLY	250cm	310cm	340cm	370cm	
ABOVE TOP OF RAIL AT RAILWAY CROSSINGS	730cm	730cm	760cm	810cm	



MINIMUM ATTACHMENT HEIGHT = MAXIMUM SAG

- + MINIMUM VERTICAL CLEARANCE (FROM ABOVE TABLE)
 ± GRADE DIFFERENCE

- + 0.3m (VEHICLE OR RAILWAY LOCATION) + SNOW DEPTH (PEDESTRIAN LOCATION, SEE NOTE 3)

NOTES:

- THE MULTIGROUNDED SYSTEM NEUTRAL HAS THE SAME CLEARANCE AS THE 600V SYSTEM.
- 2. THE VERTICAL CLEARANCES IN THE ABOVE TABLE ARE UNDER $\underline{\text{MAXIMUM SAG}}$ CONDITIONS.
- 3. REFER TO CSA STANDARD C22.3 No.1, ANNEX D FOR LOCAL SNOW DEPTH
- 4. ALL CLEARANCES ARE IN ACCORDANCE TO CSA STANDARD C22.3.

<u>\G</u>	340cm	11'-4"		
	310cm	10'-4"		
VALUES.	250cm	8'-4"		
VALUES.				
R	EFERENCE:	S		
SAGS AND	FNSIONS 1	SECTION 02		

METRIC

810cm

760cm 730cm

520cm 480cm

442cm 370cm

CONVERSION TABLE

IMPERIAL (APPROX)

27'-0" 25'-4"

24'-4" 17'-4"

15'-5" 12'-4"

MINIMUM VERTICAL CLEARANCES OF WIRES, CABLES AND CONDUCTORS ABOVE GROUND OR RAILS

ORIGINAL ISSUE DATE: 2010-DEC-24 REVISION NO: R1 REVISION DATE: 2012-JAN-09

Certificate of Approval This construction Standard meets the safety requirements of Section 4 of Regulation 22/04			
Joe Crozier, P.Eng. Name	2012-JAN-09 Date		
P Fng. Annroyal By-	Ine Crozier		



Construction Standard

03 - 4





VOLTAGE	MINIMUM HORIZONTAL CLEARNACE UNDER MAXIMUM SWING CONDITIONS DIMENSION "X" (SEE NOTES 1, 3 & 4)	MINIMUM VERTICAL CLEARANCE UNDER MAXIMUM DESIGN SAG CONDITIONS DIMENSION "Y" (SEE NOTES 1, 2, 4 & 5)
0-600V AND NEUTRAL	100cm	250cm
4.16/2.4 TO 44kV	300cm	480cm

NOTES

- UNDER NO CIRCUMSTANCES SHALL A CONDUCTOR BE PERMITTED TO PENETRATE THE ENVELOPE SHOWN BY THE DOTTED LINE.
- 2. THE VERTICAL CLEARANCES ARE UNDER CONDITIONS OF MAXIMUM DESIGN SAG.
- THE HORIZONTAL CLEARANCES ARE UNDER CONDITIONS OF MAXIMUM SWING. WHERE THE CONDUCTOR SWING IS NOT KNOWN A HORIZONTAL CLEARANCE OF 480CM SHALL BE USED.
- 4. BUILDINGS THAT EXCEED 3 STOREYS OR 15M IN HEIGHT, THE MINIMUM HORIZONTAL CLEARANCE OF THE SECONDARY CONDUCTORS SHOULD BE INCREASED TO 300cm WHERE IT IS NECESSARY TO ALLOW FOR THE RAISING OF LADDERS BY LOCAL FIRE DEPARTMENTS.
- IN SITUATIONS SUCH AS MULTI-LEVEL GARAGES, WHERE ROOFS ARE NORMALLY USED BY PERSONS AND VEHICLES, THE VERTICAL CLEARANCES OF POWERSTREAM STANDARD 03-1 SHALL APPLY.
- 6. DISTRIBUTION LINES CONSTRUCTED NEAR BUILDINGS SHALL BE BUILT TO AVOID OVERHANG WHEREVER POSSIBLE. WHERE LINES MUST BE CONSTRUCTED OVER OR ADJACENT TO BUILDINGS THE APPLICABLE HORIZONTAL AND VERTICAL CLEARANCES SHALL BE AT CONDITIONS OF MAXIMUM CONDUCTOR SWING AND MAXIMUM SAG. THE ABOVE CLEARANCES ARE DESIGNED TO PREVENT PERSONS ON OR IN BUILDINGS AS WELL AS EXTERNAL MACHINERY USED IN CONJUCTION WITH A BUILDING TO COME IN CONTACT WITH CONDUCTORS. EFFORTS SHOULD BE MADE TO INCREASE THESE CLEARANCES WHERE POSSIBLE.
- 7. ALL CLEARANCES ARE IN ACCORDANCE TO CSA C22.3 NO.1-06 (TABLE-9).

ON TABLE
IMPERIAL
(APPROX)
16'-0"
10'-0"
8'-4"
3'-4"

MINIMUM VERTICAL & HORIZONTAL CLEARANCES OF CONDUCTORS FROM BUILDINGS OR OTHER PERMANENT STRUCTURES (CONDUCTORS NOT ATTACHED TO BUILDINGS)

ORIGINAL ISSUE DATE: 2010—MAY—05 REVISION NO: REVISION DATE:
PEgystem Planning and Standards/Standard Design/PowerStream Standards/soundard working (lighter/Seedlan 3/3-4/c/wg d3-4 Ro May 5, 2010, s/wg, 3/3/2010 8/2022 AM, Adobe POF



To: Committee of Adjustment

From: Lindsay Haviland, Building Standards Department

Date: October 12, 2023

Applicant: International Missionary Society

Location: 7611 Pine Valley Drive Bldg A Unit 9

PLAN 65M2167 Part of Lot 4

YCC 1051

File No.(s): A160/23

Zoning Classification:

The subject lands are zoned GMU – General Mixed-Use Zone and subject to the provisions of Exception 14.553 under Zoning By-law 001-2021, as amended.

#	Zoning By-law 01-2021	Variance requested
1	A Place of Worship is not permitted within a multi-unit building	To permit a Place of Worship
	[Section 3.0, definition of Place of Worship].	within a multi-unit building (Unit
		9).

Staff Comments:

Stop Work Order(s) and Order(s) to Comply:

There are no outstanding Orders on file

Building Permit(s) Issued:

Other Comments:

Ge	neral Comments
1	The applicant shall be advised that additional variances may be required upon review of detailed drawing for building permit/site plan approval.

Conditions of Approval:

If the committee finds merit in the application, the following conditions of approval are recommended.

^{*} Comments are based on the review of documentation supplied with this application.

Prabhdeep Kaur

From: Kristen Regier < Kristen.Regier@trca.ca>
Sent: Monday, October 16, 2023 10:31 AM

To: Committee of Adjustment

Cc: Lenore Providence; Christine Vigneault

Subject: [External] RE: A160/23 (7611 PINE VALLEY DRIVE, UNIT 9) - REQUEST FOR COMMENTS

Hello,

The subject property at 7611 Pine Valley Drive, Vaughan is not located within TRCA's Regulated Area. TRCA's Planning and Regulatory policy interests are not impacted.

As such, TRCA has no comments on the application.

Best,

Kristen Regier, MA (she / her)

Planner I

Development Planning and Permits | Development and Engineering Services Toronto and Region Conservation Authority (TRCA)

T: 437-880-2129

E: kristen.regier@trca.ca

A: 101 Exchange Avenue, Vaughan, ON, L4K 5R6 | trca.ca



SCHEDULE C: PUBLIC & APPLICANT CORRESPONDENCE

Correspondence Type	Name	Address	Date Received (mm/dd/yyyy)	Summary
Applicant		7611 Pine Valley Drive	` ''''	Cover Letter
Applicant		7611 Pine Valley Drive		Planning Justification Report



October 13, 2023

Dear committee of adjustment,

On behalf of our organization, International Missionary Society of Seventh Day Adventists Reform Movement Canadian Union (also known as Canadian Field), we are pleased to submit this application for a minor variance, which will facilitate the renovation of our church building located at 7611 Pine Valley Drive, Unit 9, Vaughan, ON, L4L 0A2.

During our building permit application process (Permit No. 17 000107 000 00 C), we were informed by the plans examiner (zoning) that the proposed place of worship is not permitted within a multi-unit building and that a church must be located within a single unit building only, must comply with the Zoning Standards of Schedule 'A' and the Parking Requirements of Section 3.8 of By-law 1-88, and therefore, a relief from the by-law is required.

We are requesting a relief from the by-law to have a place of worship within the multi-unit building given that the attached parking study finds that the existing parking supply support adequately the expected parking demand generated by our development proposal.

We hope that the information provided is sufficient and look forward to the committee's favorable consideration of our request.

Thank you.

Sincerely,

Wendy Eaton

Canadian Field Secretary

E. canadiansecretary@4truth.ca

Shudy Ergh

P. 905-699-1291



November 10, 2021

Great Life Group 6331-2100 Bloor Street West Toronto, ON M6S 5A5

Attention: Mr. John Fromosa

CEO

Re: Parking Study

7611 Pine Valley Drive -Place of Worship

City of Vaughan

1.0 INTRODUCTION

CGE Consulting was retained to prepare a Parking Study in support of a Committee of Adjustment application for a Place of Worship at a unit within an existing commercial building located at 7611 Pine Valley Drive in the City of Vaughan.


The subject unit (unit 9) was previously occupied by a 140-seat restaurant. The owner has vacated the restaurant and converted the space into a 120-seat Place of Worship known as the International Missionary Societies Seventh Day Adventist Church Reform Movement (IMSSDARM) occupying a Gross Floor Area (GFA) of approximately 252 square meters. The location of the existing building is in Block 36 and is currently zoned as *Commercial (C7)*. **Figure 1** shows the project location map.

The site plan shows that there are two one-storey commercial buildings within the subject property. The subject unit is in Building A that has a GFA of 2,928.45 square meters. The site plan shows that the total GFA of both commercial buildings is 4,607.03 square meters with a total shared parking supply of 261 spaces including three barrier free spaces. Access to the site is presently provided via two full-access connections to Rowntree Dairy Road. **Figure 2** shows the most recent site plan.

Discussions with the owner indicate that typical peak hours of operation for the previously occupied restaurant were on Friday and Saturday evenings between 6:30 p.m. to 8:30 p.m. The IMSSDARM church main service (divine service) operates on Saturdays from 11:00 a.m. to 12:15 p.m. Other IMSSDARM services are Wednesday night prayers from 7:30 p.m. to 8:30 p.m. and Sabbath School on Saturdays from 9:30 a.m. to 10:45 p.m.


Email: casey@cgeconsulting.ca | Phone: 416-602-1885 | CGE Consulting

Figure 1 Site Location

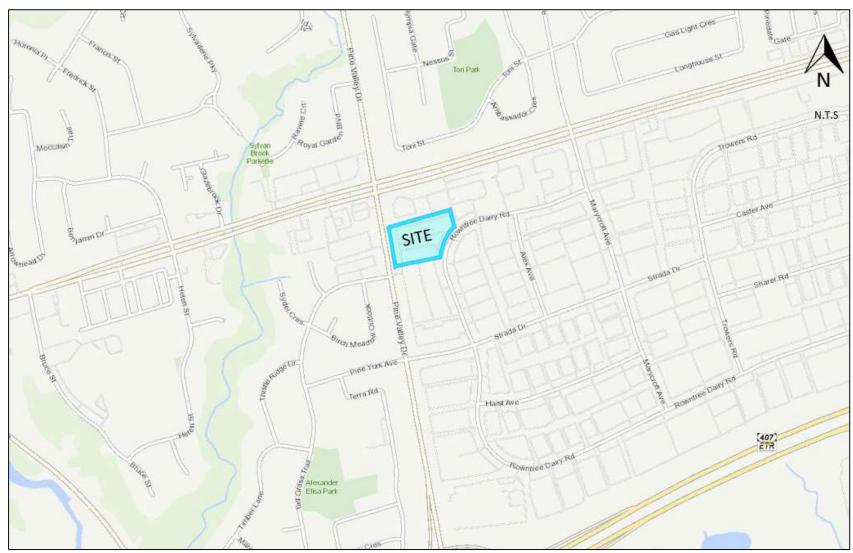

Source: York Region Maps



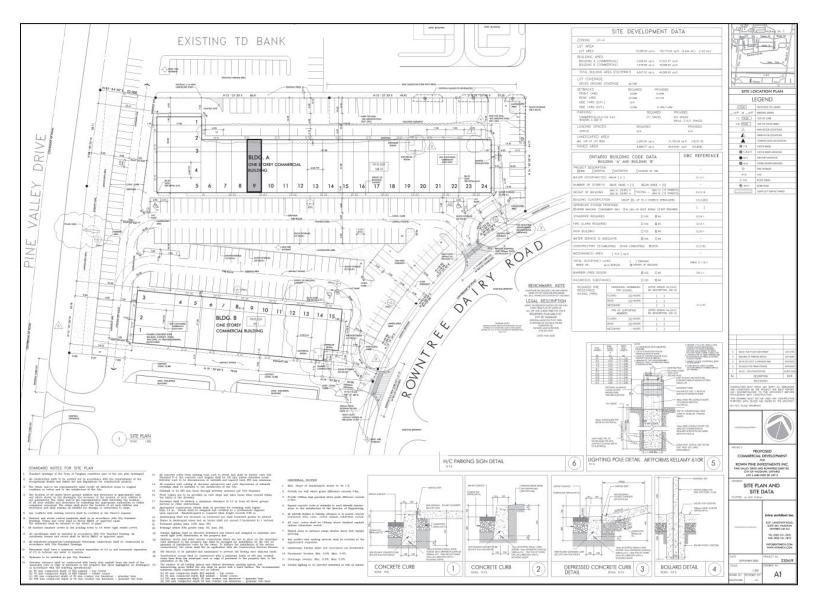

2.0 PARKING ASSESSMENT

2.1 City of Vaughan Zoning By-Law 1-88

The City of Vaughan Zoning By-Law 1-88 minimum parking standards for a Church is 11.0 spaces per 100 m² of GFA whereas for a commercial centre/store is 6.0 parking spaces per 100 m² of GFA. **Table 1** summarizes the minimum parking requirement calculations for the existing and proposed development under By-Law 1-88.

Table 1: Minimum Parking Requirements – Zoning By-Law 1-88

Type of Use	Total	Zoning By-Law 1-88		
	GFA	Rate Minimum Parking Supply		
	(SQM)		Required	
Unit 9 – Commercial	252	6.0 spaces per 100 m ²	15 spaces	
Unit 9 - Church	252	11.0 spaces per 100 m ² 28 spaces		
Difference			+ 13	

With the conversion of the subject unit to a Place of Worship, By-Law requirements increases the parking supply requirement by 13 spaces. The overall parking supply of 261 spaces represents a parking deficiency of approximately 5% as a result of the unit conversion.

2.2 City of Vaughan Recommended Parking Standards (Draft By-Law)

The City is presently reviewing its parking standards contained within By-Law 1-88 to be more reflective of the City's increasing urban environments and robust and frequent public transportation. As a result of the undertaking of the *Review of Parking Standards Contained within the City of Vaughan's Comprehensive Zoning By-Law: Final Report*, the subject site is recommended to be zoned as GMU (General Mixed-Use).

The recommended minimum parking standards in a GMU zone for a Place of Worship is 8.0 spaces per 100 m² of GFA whereas a commercial centre/store is 2.0 parking spaces per 100 m² of GFA to a maximum of 4.5 parking spaces per 100 m².

Based on the forgoing, the conversion of the subject unit to a Place of Worship, By-Law requirements increases the parking supply requirement by **only 5 spaces**. Furthermore, the commercial units/stores within the plaza will be subject to much lower parking standards under the new recommended requirements compared to By-Law 1-88.

As such, the overall parking supply of 261 spaces would meet the requirements of recommended parking standards including the IMSSDARM church operations.

While the parking supply of 261 spaces meets the Draft By-Law requirements and represents a parking deficiency of less than 10% of By-Law 1-88, a parking reduction justification was undertaken to ensure that the parking supply is adequate to accommodate the parking demands of the plaza. The following methodologies were analyzed:

- Parking Utilization Surveys.
- Shared Parking opportunities between and among neighbouring users.
- Assessment of non-auto/ Transportation Demand Management (TDM) opportunities within and in the vicinity of the site.

2.3 Parking Utilization Surveys

To determine if the proposed parking supply is adequate, parking utilization surveys at 7611 Pine Valley Drive on Wednesday, October 20th and Saturday, October 23rd, 2021. Surveys were conducted before, during and after IMSSDARM service times at 30-minute intervals on Wednesday from 7:00 p.m. to 9:00 p.m. and on Saturday from 10:30 a.m. to 12:30 p.m. The survey is included in the appendices.

The site plan shows that the two buildings at the plaza, Building A and Building B have a total of 24 and 15 units, respectively. During the survey, it was observed that all units were occupied expect for two units, unit 23 and 24, located in Building A. These two units have an approximate total GFA of 260 square meters. This unoccupied GFA was removed from the parking demand ratio calculation.

Observations also show that the units were occupied by a variety of services including, real estate and brokerage firms, medical, wellness and dental offices, catering spaces, professional general offices, retail spaces, animal grooming and daycare services, hair salons/spas, restaurants and a sports bar as well as places of worship. It is noted that these individual units and services operate with different opening and closing times.

At the time of survey, it was observed that two of the restaurants on site had their patios extended occupying approximately 5 parking spaces each. For this analysis these 10 parking spaces were removed from the available parking supply calculation.

Survey operations also noted another similar sized place of worship in Building A (Woodbridge Hispanic Church) with similar service time on Wednesdays from 7:30 p.m. However, this place of worship's main service in on Sundays and not Saturdays like IMSSDARM.

Based on the foregoing, below is a summary of the parking demand survey:

- Total **occupied** GFA 4,347.03 square meters (currently two units unoccupied)
- Total parking supply 251 parking spaces (10 spaces used as patio)
- Peak parking demand observed 107 spaces
- Surplus parking 144 spaces

Results of the parking survey indicate a peak parking demand of 107 cars or a parking demand ratio of **2.5 cars per 100 m²** occurring at 11:30 a.m. on Saturday, October 23rd.

At peak operations, including that of the IMSSDARM church, a surplus of 144 spaces was observed. It is therefore concluded that the parking supply of 261 spaces is sufficient to accommodate the demand of the entire development including the IMSSDARM church.

2.4 Shared Parking Opportunities

Institutional (church)

Shared parking arrangements amongst neighboring properties should be encouraged where possible to reduce over supply of parking spaces. The concept of shared parking takes advantage of different parking demand patterns based on the time of day for each type of use.

As mentioned earlier, the subject site is located within a commercial zone. Presently, the neighbours adjacent to the site include a TD Canada Bank Plaza as well as retail plazas with a variety of users.

The church hours of operation provide opportunity for shared parking among the different retail and office users within and outside the subject site that do not share similar parking demand patterns based on time-of-day factors as noted in the ITE Parking Generation Handbook and the Victoria Transport Policy Institute (VTPI). **Table 3** below shows the typical parking occupancy rates by land use based on time-of-day patterns.

		ncy Rates		0 4 0	0 (0	0 4 0
Uses	M-F	M-F	M-F	Sat. & Sun.	Sat. & Sun.	Sat. & Sun.
	8am-5pm	6pm-12am	12am-6am	8am-5pm	6pm-12am	12am-6am
Residential	60%	100%	100%	80%	100%	100%
Office/ Warehouse /Industrial	100%	20%	5%	5%	5%	5%
Commercial	90%	80%	5%	100%	70%	5%
Hotel	70%	100%	100%	70%	100%	100%
Restaurant	70%	100%	10%	70%	100%	20%
Movie Theater	40%	80%	10%	80%	100%	10%
Entertainment	40%	100%	10%	80%	100%	50%
Conference/Convention	100%	100%	5%	100%	100%	5%
Institutional (non- church)	100%	20%	5%	10%	10%	5%



Adjacent Commercial Site – TD Bank

2.5 On-site Transportation Demand Management (TDM)

Transportation Demand Management (TDM) refers to variety of strategies to reduce congestion, minimize the number of single-occupant vehicle, encourage non-auto modes of travel, and reduce vehicle dependency to create a sustainable transportation system. In short, TDM works to change how, when, where, and why people travel.

TDM strategies that can be applied to the subject site including the followings:

- Parking Reduction Based on the Region's Transportation Mobility Plan Guidelines for Development Applications parking reductions where appropriate is identified as a TDM measure to minimize vehicle dependency and single-occupant vehicle trips.
- **Encourage more carpooling -** Encourage and promote more carpooling among congregation where feasible
- **Bicycle Parking** If applicable and feasible, consider the implementation of bicycling parking racks at the front of the building to encourage cycling.
- **Promote transit usage** Church staff can be encouraged to provide transit information (i.e. maps and schedules) to patrons during service. The site is presently well served by transit including bus route #12, #77 and #501.
- Consider Church and Event Bus Rentals Many churches and event venues often use bus rentals to arrange for group transportation to and from the church or venue. Research shows a number of chartered or rental bus services for church groups within the GTA that have fleet ranging from 12 to 62 seaters.



7611 Pine Valley Drive – internal driveway & parking

3.0 CONCLUSIONS & RECOMMENDATIONS

The key findings are summarized below:

- With the conversion of the subject unit to a Place of Worship, By-Law (1-88) requirements increases the parking supply requirement by 11 spaces.
- The parking supply of 261 spaces is adequate to support the expected parking demand generated by the development proposal and it meets the recommendations of the Draft By-law parking requirements.
- The peak parking demand ratio following surveys at the Plaza including IMSSDARM church operations was calculated as 2.5 cars per 100 m² which is significantly lower than the By-law 1-88 requirement of 11.0 spaces per 100 m² of GFA for a Place of Worship and 6.0 parking spaces per 100 m² of GFA for a commercial centre/store.
- Observations show a surplus parking supply of 144 parking spaces during subject unit peak operations and is more that sufficient to accommodate parking demands of the proposed development including the IMSSDARM church.
- The subject site location and the proposed land use typology shows that opportunity
 exists for shared parking to occur between the church (operating during weekday
 evenings and Saturdays) and adjacent commercial uses within acceptable walking
 distances, if required.

It is our opinion that the subject site will have sufficient parking supply to accommodate the developmental needs, including the operations of IMSSDARM church. Should you have any questions regarding this study, please do not hesitate to contact the undersigned.

Yours truly,

CGE TRANSPORTATION CONSULTING

Casey Ge, P.Eng.

julyer

President

Parking Study – 7611 Pine Valley Road – Place of Worship, City of Vaughan
Appendix A. Parking Utilization Surveys (7611 Pine Valley Drive)
Page 9

7611 Pine Valley Drive, Vaughan

Wed	dnesday, October 20	, 2021	Saturday, October 23, 2021							
After	COVID Phase 3 (Reo	pening)	After COVID Phase 3 (Reopening)							
Time Period	Occupied Spaces	Total Supply	Time Period	Occupied Spaces	Total Supply					
7:00	53	251	10:30	91	251					
7:30	54	251	11:00	106	251					
8:00	40	251	11:30	107	251					
8:30	31	251	12:00	92	251					
9:00	27	251	12:30	89	251					

SCHEDULE D: BACKGROUND						
Application No. (City File)	Application Description					
	(i.e. Minor Variance Application; Approved by COA / OLT)					
A072/21	APPROVED COA					



Committee of Adjustment

2141 Major Mackenzie Drive, Vaughan, ON L6A 1T1 T 905 832 8585

E CofA@vaughan.ca

NOTICE OF DECISION

Minor Variance Application A072/21

Section 45 of the Planning Act, R.S.O, 1990, c.P.13

Date of Hearing: Thursday, June 10, 2021

Applicant: 2207922 Ontario Inc.

Agent 2MK Architects Inc.

Property: 7611 Pine Valley Drive, Unit 28, Woodbridge

Zoning: The subject lands are zoned C7 - Service Commercial Zone and are

subject to the provisions of Exception 9(864) under By-law 1-88 as

amended.

OP Designation: Vaughan Official Plan 2010 ('VOP 2010'): "Mid-Rise Mixed-Use"

Related Files: None

Purpose: Relief from By-law 1-88, as amended is being requested to permit the

construction of a proposed second floor within Unit #28.

The following variances are being requested from By-Law 1-88, as amended, to accommodate the above proposal:

By-law Requirement	Proposal
The by-law requires that a minimum of 285	A minimum of 261 parking spaces are
parking spaces shall be required on the lot. [3.8	proposed to be provided on the lot.
a) and 9(864) ei)]	

Sketch: A sketch illustrating the request has been attached to the decision.

Having regard to the requirements of Section 45 of the *Planning Act*, R.S.O. 1990, c. P. 13, as amended, including the written and oral submissions related to the application, it is the decision of the Committee:

THAT Application No. A072/21 on behalf of 2207922 Ontario Inc. be **APPROVED**, in accordance with the sketch submitted with the application (as required by Ontario Regulation 200/96)

For the following reasons:

- 1. The general intent and purpose of the by-law will be maintained.
- 2. The general intent and purpose of the official plan will be maintained.
- 3. The requested variance(s) is/are acceptable for the appropriate development of the subject lands.
- 4. The requested variance(s) is/are minor in nature.

Please Note:

It is the responsibility of the owner/applicant and/or authorized agent to address any condition(s) of approval noted in this decision to the satisfaction of the commenting department or agency. Once conditions have been satisfied, the Secretary Treasurer will be in a position to issue a clearance letter which is required prior to the issuance of a Building Permit.

Relief granted from the City's Zoning By-law is determined to be the building envelope considered and approved by the Committee of Adjustment.

Development outside of the approved building envelope (subject to this application) must comply with the provisions of the City's Zoning By-law or additional variances may be required.

Elevation drawings are provided to reflect the style of roof to which building height has been applied (i.e. flat, mansard, gable etc.) as per By-law 1-88 and the Committee of Adjustment

File No: A072/21 Page 1

approval. Please note, that architectural design features (i.e. window placement), that do not impact the style of roof approved by the Committee, are not regulated by this decision.

Written & oral submissions considered in the making of this decision were received from the following:

Public Written Submissions	Public Oral Submissions
* Public Correspondence received and considered by the	*Please refer to the approved Minutes of the Thursday,
Committee in making this decision	June 10, 2021 meeting for submission details.
None	None

Late Written Public Submissions: N/A

Public written submissions on an Application shall only be received by the Secretary Treasurer until **noon** on the last business day prior to the day of the scheduled Meeting.

File No: A072/21 Page 2

MEMBERS PRESENT WHO CONCUR IN THIS DECISION:

Hao Zheng	Assunta Perrella	Robert Buckler
H. Zheng	A. Perrella	R. Buckler
Member	Chair	Member
Steve Kerwin		Adolfo Antinucci
S. Kerwin		A. Antinucci
Vice Chair		Member

DATE OF HEARING:	June 10, 2021
DATE OF NOTICE:	June 18, 2021
LAST DAY FOR *APPEAL:	June 30, 2021
*Please note that appeals must be received by this office no later than 4:30 p.m. on the last day of appeal.	4:30 p.m.
CERTIFICATION:	
I hereby certify that this is a true copy of the decision of the City of Vaughan's Committee of Adjustment and this decision was concurred in by a majority of the members who heard the application.	
Christins Vignsault	
Christine Vigneault, AMP, ACST Manager Development Services & Secretary Treasurer to the Committee of Adjustment	

*Electronic signatures have been used to process this decision as approved by the Committee of Adjustment at the May 28, 2020 hearing.

Appealing to The Local Planning Appeal Tribunal The *Planning Act*, R.S.O. 1990, as amended, Section 45

The applicant, the Minister or any other person or public body who has an interest in the matter may within 20 days of the making of the decision appeal to the Local Planning Appeal Tribunal (LPAT) against the decision of the Committee by filing with the Secretary-Treasurer of the Committee a notice of appeal (A1 Appeal Form) setting out the objection to the decision and the reasons in support of the objection accompanied by payment to the Secretary-Treasurer of the fee prescribed by the Tribunal under the Local Planning Appeal Tribunal Act.

A notice of appeal may not be filed by an unincorporated association or group. However, a notice of appeal may be filed in the name of an individual who is a member of the association or group on its behalf.

When **no appeal is lodged** within twenty days of the date of the making of the decision, the decision becomes final and binding and notice to that effect will be issued by the Secretary-Treasurer.

PLEASE NOTE: As a result of COVID-19, Vaughan City Hall and all other City facilities are closed to the public at this time. Please mail or courier appeals and prescribed fees to:

Office of the City Clerk - Committee of Adjustment 2141 Major Mackenzie Drive Vaughan Ontario, L6A 1T1

If you have questions regarding the appeal process, please email cofa@vaughan.ca

Appeal Fees & Forms

Local Planning Appeal Tribunal: The LPAT appeal fee is \$400 plus \$25 for each additional consent/variance appeal filed by the same appellant against connected applications. The LPAT Appeal Fee must be paid by certified cheque or money order payable to the "Minister of Finance". Appeal forms (A1 Appeal Form – Minor Variance) can be obtained at www.elto.gov.on.ca or by contacting our office at 905-832-8585 Ext. 8332 or cofa@vaughan.ca

City of Vaughan LPAT Processing Fee: \$866.00 per application


*Please note that all fees are subject to change.


File No: A072/21 Page 3



VAUGHAN LOCATION MAP - A072/21

7611 PINE VALLEY DRIVE, UNIT 28, WOODBRIDGE

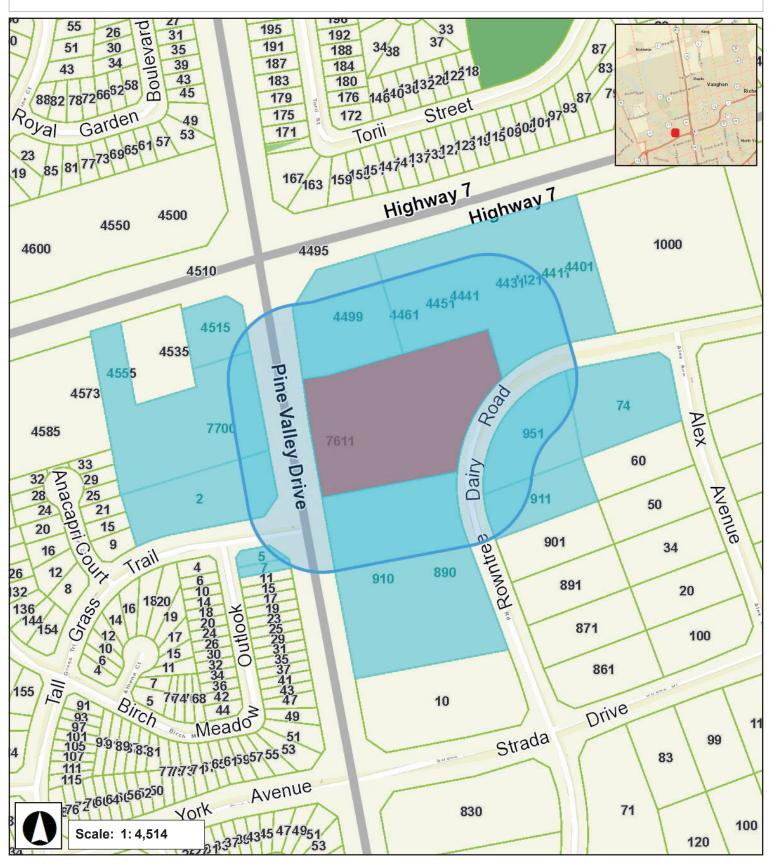

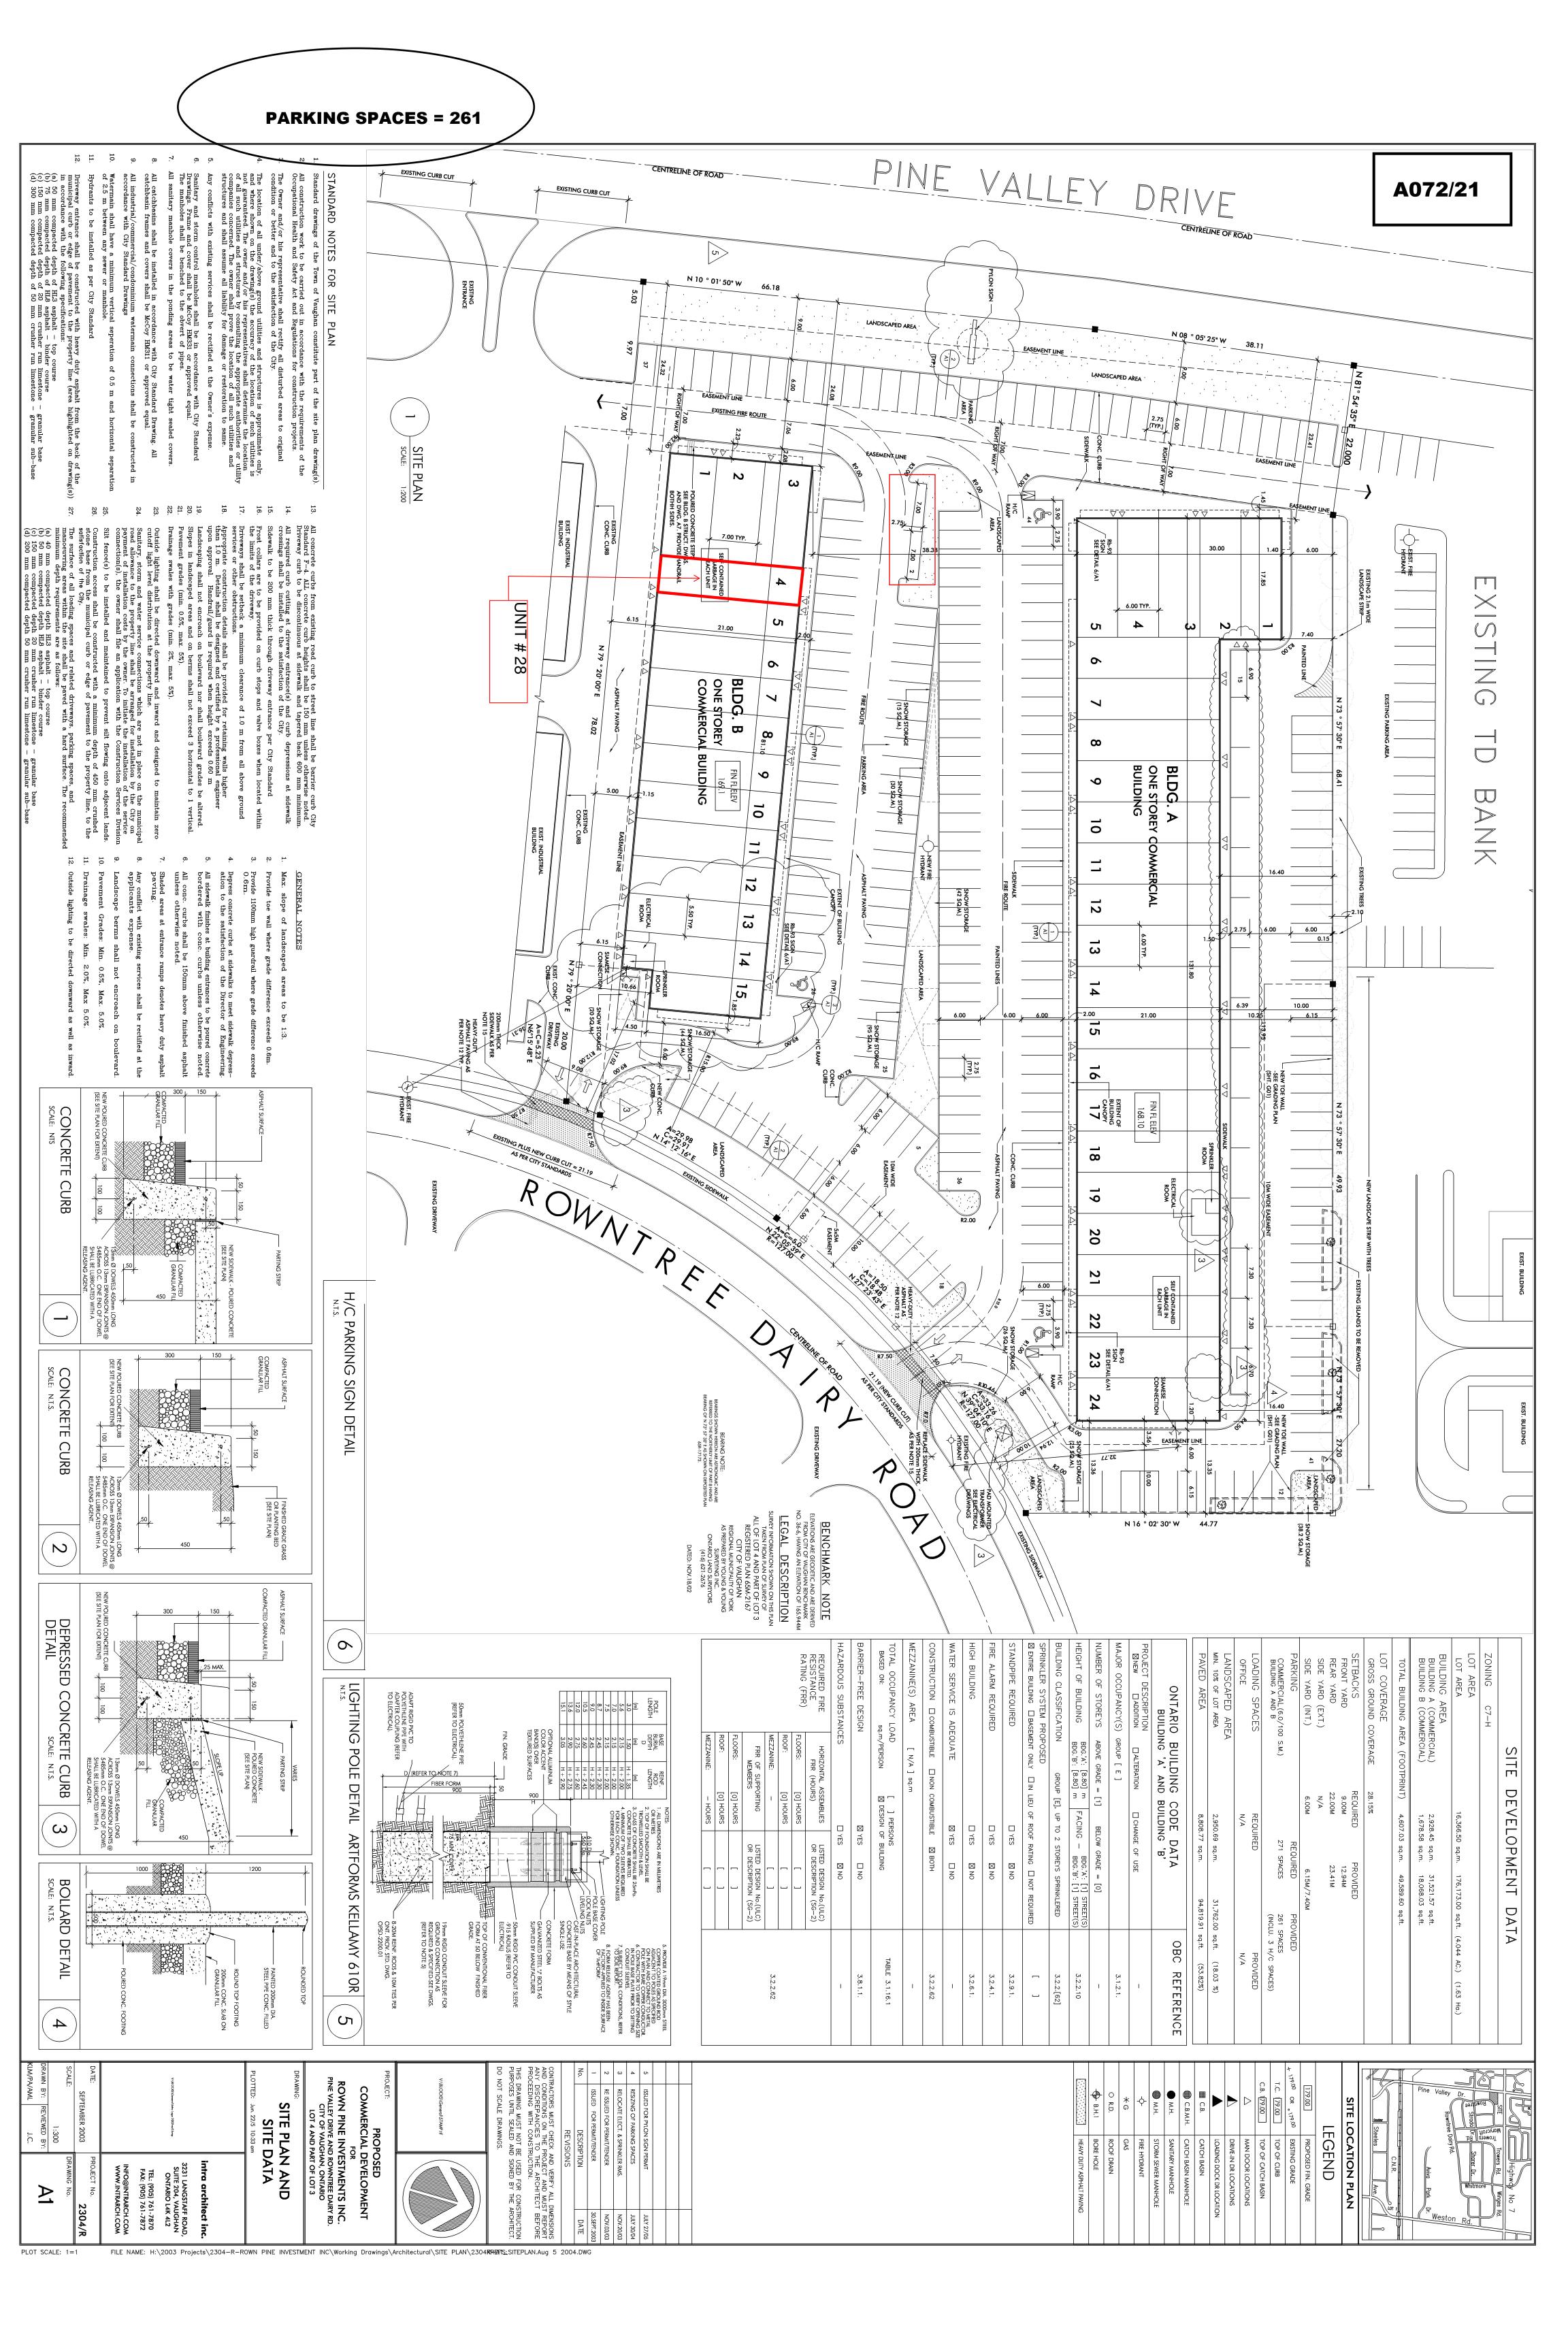

3.23		3.21	3.20	3.19	3.18	3.15	3.14	3.13	3.12	, <u>s</u>	3.10	3.09	3.08	3.07		3.06			3.05		3.04	3.03	3.02		3.01	3.00	
Plumbing Fixture Requirements Transfer actionnal lease as recorded.		Required Fire Resistance Ratings	Hazardous Substances:	Barrier-free Design:	Occupant Load	Construction Type:	Water Service / Supply is Adequate	Fire Alarm System	Standpipe System	Sprinkler System	Building Classification: (Size and Construction Relative to Cosupancy)	Number of Streets/ Firefighter access	High Building	Building Height	Insert additional lines as needed	Mezzanine Area (m²)	Insert additional lines as needed		Gross Area (m²)	hs ed additional lines as needed	Building Area (m²)	Superimposed Major Occupancies:	Major Occupancy Classification:		Project Type:	Building Code Version:	
Hadio: Male Female = 50.50 Except as noted otherwise Floor Level/Area Occupant DBC Fixtures Fixtures Required Provided Main Floor 10 3.7.4.7 2 2 Main Floor 2 10 3.7.4.7 2 2	Floors over basement	Horizontal Assembly Bating Supporting Noncombusible Assembly (H) in lieu of rating?	□ Yes <u>Explanation</u> ■ No	■ Yes Explanation: Barrier Free washroom existing in the unit. □ No	Hoor Level/Area Occupancy Based On Persons Occupant Load Persons Office employees. Design 10 persons	Bestriction: □ Combustible permitted □ Non-combustible required Actual: □ Combustible □ Non-combustible □ Combination Heavy Timber Construction: □ No □ Yes	□ No ⊠ Yes	☐ Required ⊠ Not required Proposed: ☐ Single stage ☐ Two stage ☐ None	Not required □ Required	⊠ Required □ Not Required <u>Proposed</u> : □ selected floor areas □ basement □ nieu of roof rating □ none		1 street(s)	⊠ No ☐ Yes		Total 75.8 m²	<u>u</u> <u>New</u> <u>Total</u> m² <u>33</u> 75.8 n		Area of Interior Alteration 192.8 m² 0 192.8 m² 0 0 0 0 0 0 0 0 0 0 0 0 0 0 0 0 0 0	Description: Existing New Total	Area of Interior Alteration 192.8 m² 0 192.8 m² Total area of interior atteration 192.8 m²	Description: Existing New Total	⊠ No □Yes Description:	Occupancy Use D Office	Description: Interior Alteration to an Existing Commercial Building	☐ New ☐ Addition ☐ ⊠ Renovation☐ Change of use ☐ Addition and renovation	O. Reg. 332/12 Last Amendment O. Reg. 191/14	Ontario Building Code Data Matrix Part 3
3.7.4.		3.2.2.20 83. & 3.2.1.4.	33.12.& 33.1.19.	3.8.	3.1.17.	3.2.2.2083. & 3.2.1.4.		3.2.4.	329.	3.2.1.5. & 3.2.2.17.	3.2.2.20 83.	322.10. & 3.2.5.	3.2.6.	[A] 1.4.1.2. & 3.2.1.1.		3.2.1.1.			[A] 1.4.1.2.		[A] 1.4.12	3227.	3.1.2.1.(1)		[A]1.1.2		Building Code Reference 1

STATISTICS

ADDRESS: 7611 Pine Valley Dr. Vaughan, ON. L4L 9A9. unit #28

PROPOSED UNIT USE: PROFESSIONAL OFFICE / BUSINESS	PREVIOUS UNIT USE: EATING ESTABLISHMENT/ CONVENIENCE
EXISTING UNIT COMMERCIAL FLOOR AREA=113 m²	
Mezzanine / SECOND FLOOR = 75.8 m ²	
Gr. Floor area = 117 m ²	Commercial
TOTAL PROPOSED GROSS FLOOR AREA=192.8 m²	ZONING: C7

MEZZANINE AREA CALCULATIONS

Existing mezzanine floor area = 42.8 m² Proposed addition to existing mezzanine floor area = 33 m² Total proposed mezzanine / second floor area = 75.8 m² Open Space area = 35.5 m^2

NOTE: WE PROPOSE THIS ADDITION AS SECOND FLOOR

CAR PARKING:

REQUIRED CAR PARKING FOR OFFICE USE = 3.5 FOR EVERY 100 m² GFA

= 7 CAR PARKING SPACES REQUIRED

TOTAL EXISTING CAR PARKING ALLOCATED FOR UNIT#28 = 6 (NO CHANGE)


TOTAL EXISTING CAR PARKING PROVIDED ON SITE = 261 (NO CHANGE)

BUILDING HEIGHT: EXISTING (NO CHANGE)

ALL SET-BACKS EXISTING, NO CHANGE FOR EXISTING SET-BACKS

PREVIOUS UNIT USE: EATING ESTABLISHMENT/ CONVENIENCE	PROPOSED UNIT USE: PROFESSIONAL OFFICE / BUSINESS
EXISTING BUILDING MAJOR OCCUPANCY : E - MERCANTILE OCCUPANCIES	O.B.C CLASSIFICATION OF THE WHOLE BUILDING: 3.2.2.62
existing building fully Sprinklered	NUMBER OF EXITS FOR EXISTING UNIT: 2
MAX. OCCUPANT LOAD : 10 PERSON	


Number of Barrier free Washrooms : 1 - existing (no change) number of regular Washrooms : 2

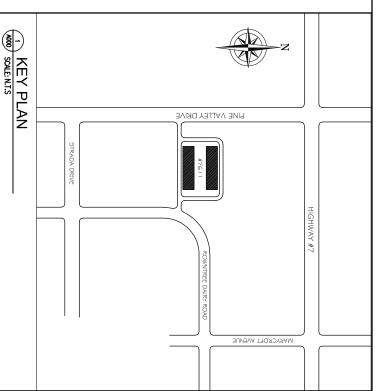



A000	COVER SHEET & O.B.C MATRIX
A001	EXISTING SITE PLAN & STATISTICS
A002	GENERAL NOTES
A100	EXISTING UNIT FLOOR PLANS
A101	PROPOSED UNIT FLOOR PLANS
A102	REFLECTED CEILING PLAN
A 501	INTERIOR SECTIONS / ELEVATIONS

Grand total: 10 Drawings

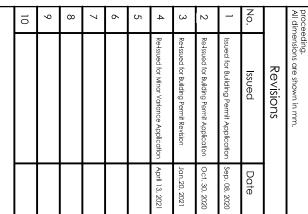

This drawing is protected by copyright Confractors must check all dimensions on site. Only figured dimensions are to be used. Discrepancies must be reported immediately to the architect before



R-Con Engineering Inc.

7611 Pine Valley Dr. Vaughan, ON. Unit #28

2MK Architects Inc.

501A-3461 DIXIE RD. Mississauga ON. L4Y3X4 phone 4162729435/6473000175

Existing Space Interior Alterations To an

7611 Pine Valley Dr. Vaughan, ON. Unit #28

Drawing Title

Cover Sheet

drawing No.	Project No.	Scale	Drawn by:	
•	202049	1:150	MK	
		Date Sep. 08, 2020	Checked by: MK	

