ITEM: 6.8

COMMITTEE OF ADJUSTMENT REPORT SUMMARY MINOR VARIANCE APPLICATION FILE NUMBER A132/23 2 BODDY COURT, WOODBRIDGE

THIS REPORT CONTAINS COMMENTS FROM THE FOLLOWING DEPARTMENTS & AGENCIES:

*Please see **Schedule B** of this report for a copy of Development Planning and Agency correspondence.

Additional comments from departments and agencies may be received after the publication of the Staff Report. These comments will be processed as an addendum and posted on the City's Website.

DEPARTMENTS	Circulated	Comments Received	Conditions	Nature of Comments
Committee of Adjustment	\boxtimes	\boxtimes		General Comments
Building Standards (Zoning Review)	\boxtimes	\boxtimes		General Comments
Building Inspection (Septic)	\boxtimes			No Comments Received to Date
Development Planning				Recommend Approval/No Conditions
Development Engineering		\boxtimes	\boxtimes	Recommend Approval w/Conditions
Parks, Forestry and Horticulture Operations				General Comments
By-law & Compliance, Licensing & Permits				No Comments Received to Date
Development Finance	\boxtimes			General Comments
Real Estate				
Fire Department	\boxtimes			No Comments Received to Date
AGENCIES	Circulated	Comments Received	Conditions	Nature of Comments
TRCA	\boxtimes	\boxtimes		General Comments
Ministry of Transportation (MTO)				
Region of York	\boxtimes	\boxtimes		General Comments
Alectra	\boxtimes	\boxtimes		General Comments
Bell Canada	\boxtimes			No Comments Received to Date
YRDSB				
YCDSB				
CN Rail				
CP Rail				
TransCanada Pipeline	\boxtimes			No Comments Received to Date
Metrolinx				
Propane Operator				

PUBLIC & APPLICANT CORRESPONDENCE

*Please see **Schedule C** of this report for a copy of the public & applicant correspondence listed below.

The deadline to submit public comments is noon on the last business day prior to the scheduled hearing date.

Comments and written public submissions received after the publication of this Staff Report will be processed as an addendum and posted on the City's Website.

All personal information collected because of this public meeting (including both written and oral submissions) is collected under the authority of the Municipal Act, the Municipal Freedom of Information and Protection of Privacy Act (MFIPPA), the Planning Act and all other relevant legislation, and will be used to assist in deciding on this matter. All personal information (as defined by MFIPPA), including (but not limited to) names, addresses, opinions and comments collected will become property of the City of Vaughan, will be made available for public disclosure (including being posted on the internet) and will be used to assist the Committee of Adjustment and staff to process this application.

Correspondence Type	Name	Address	Date Received (mm/dd/yyyy)	Summary
None				

PREVIOUS COA DECISIONS ON THE SUBJECT LAND		
*Please see Schedule D for a copy of the Decisions listed below		
File Number	Date of Decision	Decision Outcome

PREVIOUS COA DECISIONS ON THE SUBJECT LAND		
*Please see Schedule D for a copy of the Decisions listed below		
	MM/DD/YYYY	
None		

ADJOURNMENT HISTORY		
* Previous hearing dates where this application was adjourned by the Committee and public notice issued.		
None		



COMMITTEE OF ADJUSTMENT REPORT MINOR VARIANCE APPLICATION A132/23

2 BODDY COURT, WOODBRIDGE

ITEM NUMBER: 6.8	CITY WARD #: 3
APPLICANT:	Melanie & Sergio Di Carlantonio
AGENT:	Sunny Gervan
PROPERTY:	2 Boddy Court, Woodbridge
ZONING DESIGNATION:	See Below
VAUGHAN OFFICIAL PLAN (2010) DESIGNATION:	Vaughan Official Plan 2010 ('VOP 2010'): "Low-Rise Residential"
RELATED DEVELOPMENT APPLICATIONS:	None
PURPOSE OF APPLICATION:	Relief from the Zoning By-law is being requested to permit a proposed cabana.

The following variances have been requested from the City's Zoning By-law:

The subject lands are zoned R2A(EN), Second Density Residential Zone subject to the provisions of Exception 14.474 under Zoning By-law 001-2021, as amended.

#	Zoning By-law 001-2021	Variance requested
1	An accessory building or residential accessory structure shall	To permit a minimum exterior side
	not be closer to an exterior side lot line than the principal	yard setback of 2.51 metres to an
	building on the lot (5.38 metres).	accessory building (Cabana).

HEARING INFORMATION

DATE OF MEETING: Thursday, October 19, 2023

TIME: 6:00 p.m.

MEETING LOCATION: Vaughan City Hall, Woodbridge Room (2nd Floor), 2141 Major Mackenzie Drive

LIVE STREAM LINK: Vaughan.ca/LiveCouncil

PUBLIC PARTICIPATION

If you would like to speak to the Committee of Adjustment at the meeting, either remotely or in person, please complete the Request to Speak Form and submit to cofa@vaughan.ca

If you would like to submit written comments, please quote file number above and submit by mail or email to:

Email: cofa@vaughan.ca

Mail: City of Vaughan, Office of the City Clerk, Committee of Adjustment, 2141 Major Mackenzie Drive, Vaughan, ON, L6A 1T1

To speak electronically, pre-registration is required by completing the Request to Speak Form on-line and submitting it to cofa@vaughan.ca no later than NOON on the last business day before the meeting.

THE DEADLINE TO REGISTER TO SPEAK ELECTRONICALLY OR SUBMIT WRITTEN COMMENTS ON THE ABOVE NOTED FILE(S) IS <u>NOON</u> ON THE LAST BUSINESS DAY BEFORE THE MEETING.

INTRODUCTION

Staff and Agencies act as advisory bodies to the Committee of Adjustment. The comments contained in this report are presented as recommendations to the Committee.

Section 45(1) of the Planning Act sets the criteria for authorizing minor variances to the City of Vaughan's Zoning By-law. Accordingly, review of the application may consider the following:

That the general intent and purpose of the by-law will be maintained.

That the general intent and purpose of the official plan will be maintained.

INTRODUCTION

That the requested variance(s) is/are acceptable for the appropriate development of the subject lands. That the requested variance(s) is/are minor in nature.

Public written and oral submissions relating to this application are taken into consideration by the Committee of Adjustment as part of its deliberations and final decision on this matter.

COMMITTEE OF ADJUSTMENT COMMENTS		
Date Public Notice Mailed:	October 5, 2023	
Date Applicant Confirmed Posting of Sign:	September 28, 2023	
Applicant Justification for Variances: *As provided by Applicant in Application Form	Lot size and shape does not permit.	
Adjournment Requests (from staff): *Adjournment requests provided to applicant prior to issuance of public notice	None	
Was a Zoning Review Waiver (ZRW) Form submitted by Applicant:		
*ZRW Form may be used by applicant in instances where a revised submission is made, and zoning staff do not have an opportunity to review and confirm variances prior to the issuance of public notice.		
*A revised submission may be required to address staff / agency comments received as part of the application review process.		
*Where a zoning review has not been completed on a revised submission, an opportunity is provided to the applicant to adjourn the proposal prior to the issuance of public notice.		
Adjournment Fees:		
In accordance with Procedural By-law 069-2019, an Adjournment Fee is applicable to reschedule an application after the issuance of public notice where a request for adjournment has been provided to the applicant prior to the issuance of public notice.		

BUILDING STANDARDS (ZONING) COMMENTS	
**See Schedule B for Building Standards (Zoning) Comments	
Building Standards Recommended Conditions of Approval:	None

An Adjournment Fee can only be waived in instances where adjournment of an application is requested by the

Committee or staff after the issuance of public notice.

Committee of Adjustment Recommended None

Committee of Adjustment Comments:

Conditions of Approval:

DEVELOPMENT PLANNING COMMENTS	
**See Schedule B for Development Planning Comments.	
Development Planning Recommended Conditions of Approval:	None

DEVELOPMENT ENGINEERING COMMENTS

<u>Link to Grading Permit</u> <u>Link to Pool Permit</u> <u>Link to Curb Curt Permit</u> <u>Link Culvert Installation</u>

As the proposed cabana in the subject property is 33.49 sq. m, the Owner/ Applicant needs to obtain a 'Lot Grading Permit' from the Development Inspection and Lot Grading Division of the City's Development Engineering Department. Please note any in-ground structure over 10 sq. m requires a 'Grading Permit'. Please contact the Development Engineering Reviewer after receiving the Grading Permit to clear the condition. (Condition attached)

Permit to clear the condition. (Condition atta	cnea)
Development Engineering	The Owner / Applicant shall submit the final Lot Grading
Recommended Conditions of	and/or Servicing Plan to the Development Inspection and
Approval:	Lot Grading Division of the City's Development
	Engineering Department for final Lot Grading and/or
	Servicing Permit prior to any work being undertaken on
	the property. Please visit the Grading Permit page at City
	of Vaughan website to learn how to apply for the Grading
	Permit. If you have any questions about Grading Permit,
	please contact the Development Engineering Department
	by email at DEPermits@vaughan.ca.

PARKS, FORESTRY & HORTICULTURE (PFH) COMMENTS	
Forestry has no comment at this time.	
PFH Recommended Conditions of Approval:	None

DEVELOPMENT FINANCE COMMENTS			
No comment no concerns			
Development Finance Recommended Conditions of Approval:			

BY-LAW AND COMPLIANCE, LICENSING AND PERMIT SERVICES COMMENTS		
No comments received to date.		
BCLPS Recommended Conditions of Approval:		

BUILDING INSPECTION (SEPTIC) COMMENTS		
No comments received to date.		
Building Inspection Recommended None Conditions of Approval:		

FIRE DEPARTMENT COMMENTS		
No comments received to date.		
Fire Department Recommended None Conditions of Approval:		

SCHEDULES TO STAFF REPORT *See Schedule for list of correspondence			
Schedule A Drawings & Plans Submitted with the Application			
Schedule B	Schedule B Staff & Agency Comments		
Schedule C (if required) Correspondence (Received from Public & Applicant)			
Schedule D (if required)	Previous COA Decisions on the Subject Land		

Should the Committee find it appropriate to approve this application in accordance with request and the sketch submitted with the application, as required by Ontario Regulation 200/96, the following conditions have been recommended:

SUMMARY OF RECOMMENDED CONDITIONS OF APPROVAL All conditions of approval, unless otherwise stated, are considered to be incorporated into the approval "if required". If a condition is no longer required after an approval is final and binding, the condition may be waived by the respective department or agency requesting conditional approval. A condition cannot be waived without written consent from the respective department or agency. **CONDITION(S) DESCRIPTION** # **DEPARTMENT / AGENCY Development Engineering** The Owner / Applicant shall submit the final Jonal.hall@vaughan.ca Lot Grading and/or Servicing Plan to the **Development Inspection and Lot Grading** Division of the City's Development Engineering Department for final Lot Grading and/or Servicing Permit prior to any work being undertaken on the property. Please visit the Grading Permit page at City of Vaughan website to learn how to apply for the Grading Permit. If you have any questions about Grading Permit, please contact the **Development Engineering Department by** email at DEPermits@vaughan.ca.

IMPORTANT INFORMATION - PLEASE READ

CONDITIONS: It is the responsibility of the owner/applicant and/or authorized agent to obtain and provide a clearance letter from respective department and/or agency (see condition chart above for contact). This letter must be provided to the Secretary-Treasurer to be finalized. All conditions must be cleared prior to the issuance of a Building Permit.

IMPORTANT INFORMATION - PLEASE READ

APPROVALS: Making any changes to your proposal after a decision has been made may impact the validity of the Committee's decision.

An approval obtained from the Committee of Adjustment, where applicable, is tied to the building envelope shown on the plans and drawings submitted with the application and subject to the variance approval.

A building envelope is defined by the setbacks of the buildings and/or structures shown on the plans and drawings submitted with the application, as required by Ontario Regulation 200/96. Future development outside of an approved building envelope, where a minor variance was obtained, must comply with the provisions of the City's Zoning By-law.

Elevation drawings are provided to reflect the style of roof (i.e. flat, mansard, gable etc.) to which a building height variance has been applied. Where a height variance is approved, building height is applied to the style of roof (as defined in the City's Zoning By-law) shown on the elevation plans submitted with the application.

Architectural design features that are not regulated by the City's Zoning By-law are not to be considered part of an approval unless specified in the Committee's decision.

DEVELOPMENT CHARGES: That the payment of the Regional Development Charge, if required, is payable to the City of Vaughan before issuance of a building permit in accordance with the Development Charges Act and the Regional Development Charges By-law in effect at the time of payment.

That the payment of the City Development Charge, if required, is payable to the City of Vaughan before issuance of a building permit in accordance with the Development Charges Act and the City's Development Charges By-law in effect at the time of payment.

That the payment of the Education Development Charge if required, is payable to the City of Vaughan before issuance of a building permit in accordance with the Development Charges Act and the Boards of Education By-laws in effect at the time of payment


That the payment of Special Area Development charge, if required, is payable to the City of Vaughan before issuance of a building permit in accordance with the Development Charges Act and The City's Development Charge By-law in effect at the time of Building permit issuance to the satisfaction of the Reserves/Capital Department.

NOTICE OF DECISION: If you wish to be notified of the decision in respect to this application or a related Ontario Land Tribunal (OLT) hearing you must complete a Request for Decision form and submit to the Secretary Treasurer (ask staff for details). In the absence of a written request to be notified of the Committee's decision you will **not** receive notice.

SCHEDULE A: DRAWINGS & PLANS



2 Boddy Court, Woodbridge

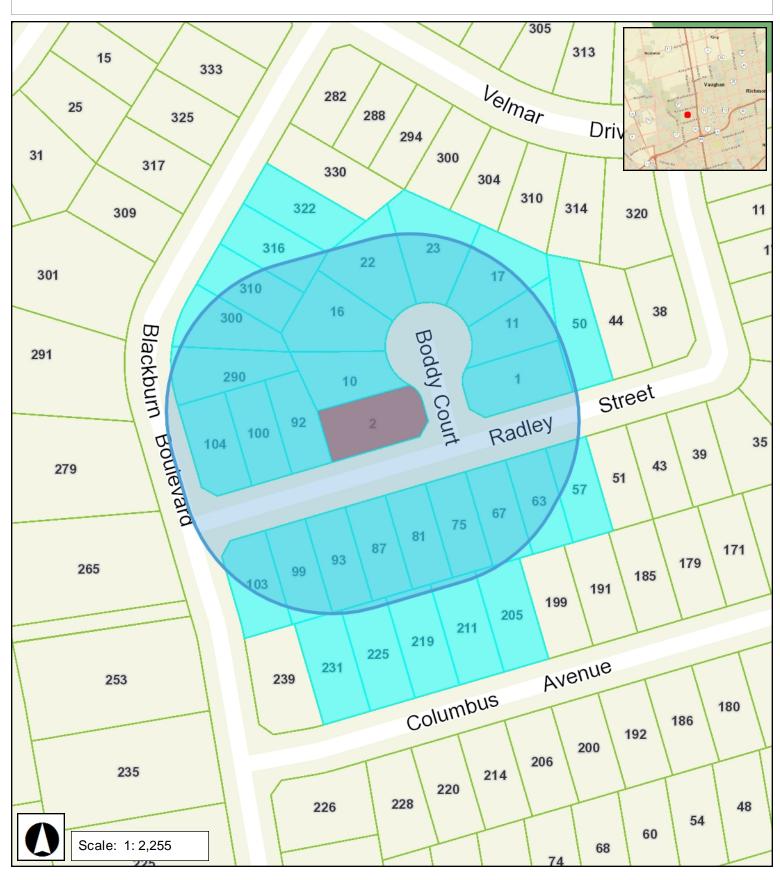

NOTIFICATION MAP - A132/23

Disclaimer:



Scale: 1: 4,514 0.07 km





WESTON

ROAD

Created By: Infrastructure Delivery Department August 30, 2023 9:28 AM

NAD 83 UTM Zone

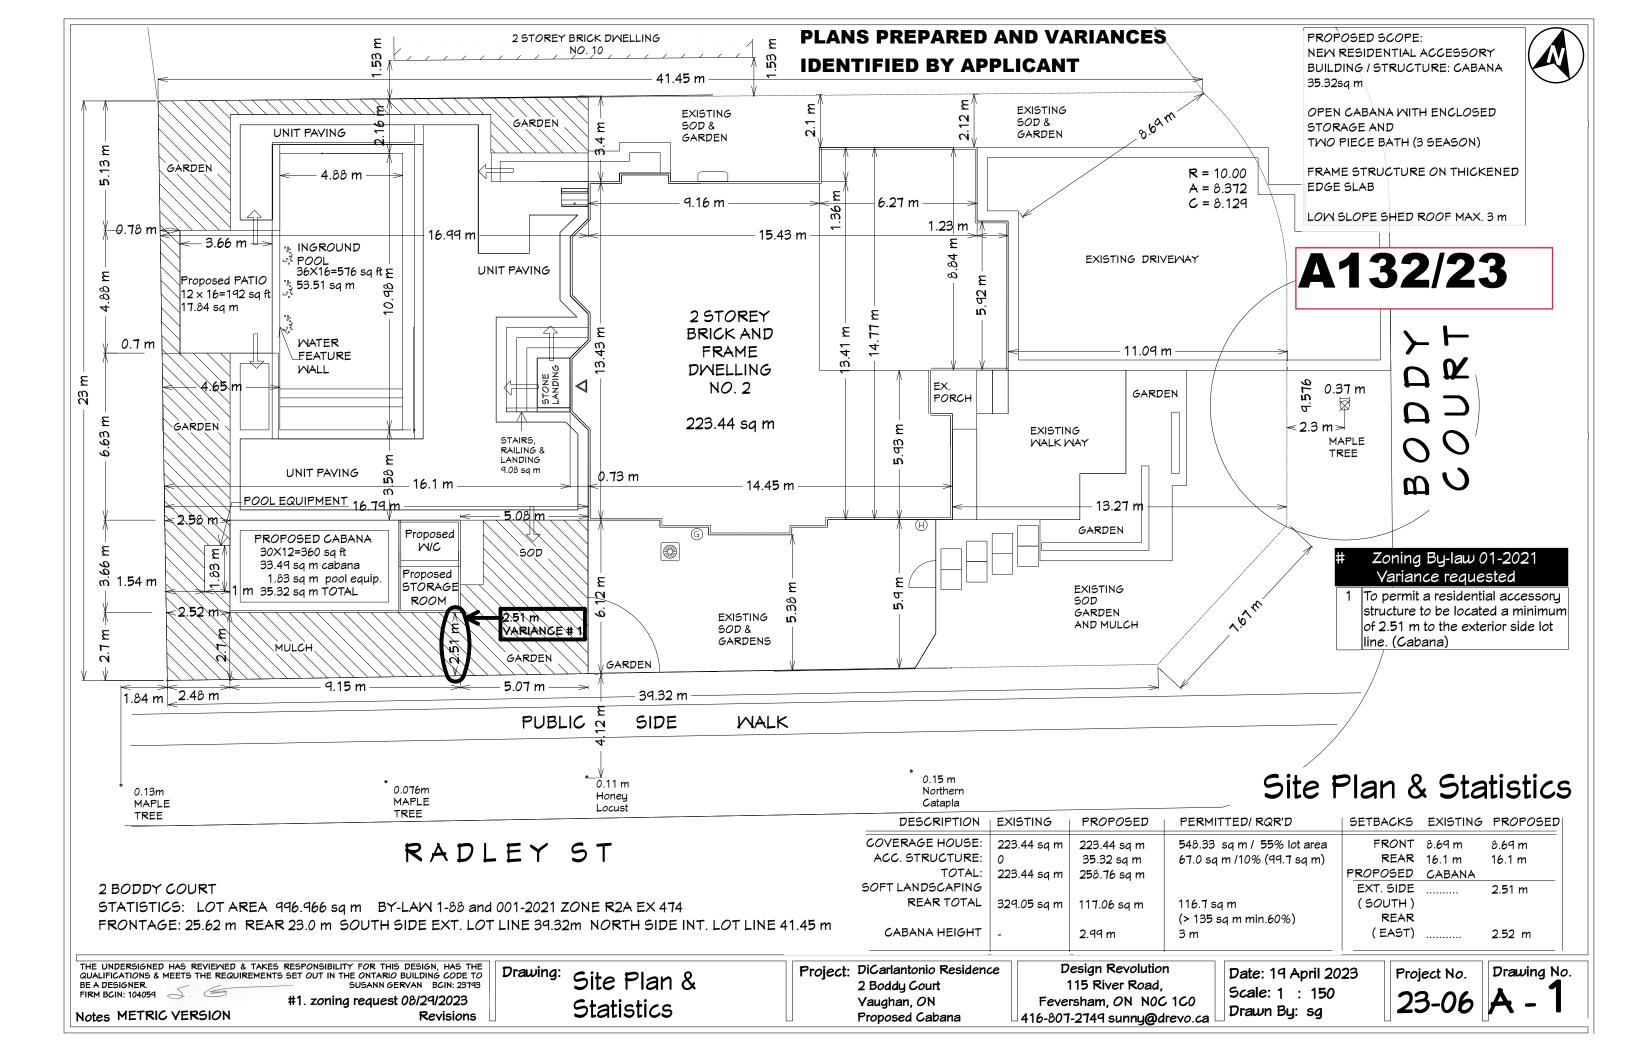

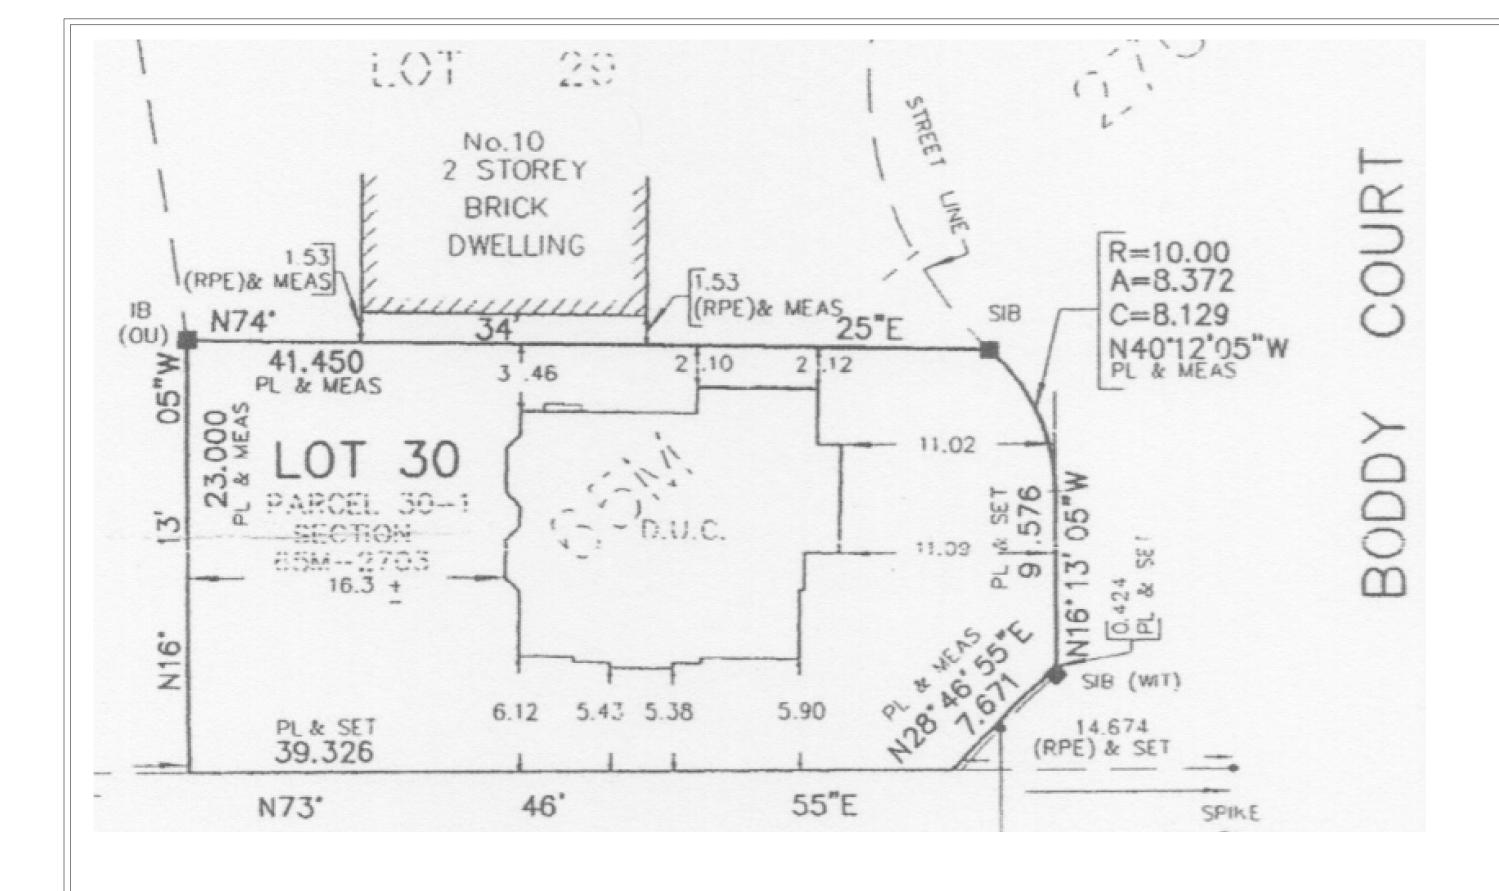



THE UNDERSIGNED HAS REVIEWED & TAKES RESPONSIBILITY FOR THIS DESIGN, HAS THE QUALIFICATIONS & MEETS THE REQUIREMENTS SET OUT IN THE ONTARIO BUILDING CODE TO BE A DESIGNER.

FIRM BCIN: 104059

#1. zoning request 08/29/2023

Notes METRIC VERSION


Drawing: SURVEY


Revisions

Project: DiCarlantonio Residence 2 Boddy Court Yaughan, ON Proposed Cabana Design Revolution
115 River Road,
Feversham, ON NOC 1C0
416-807-2749 sunny@drevo.ca

Date: 19 April 2023 Scale: n.t.s. = 1' - 0" Drawn By: sg Project No. **23-06**

Drawing No.

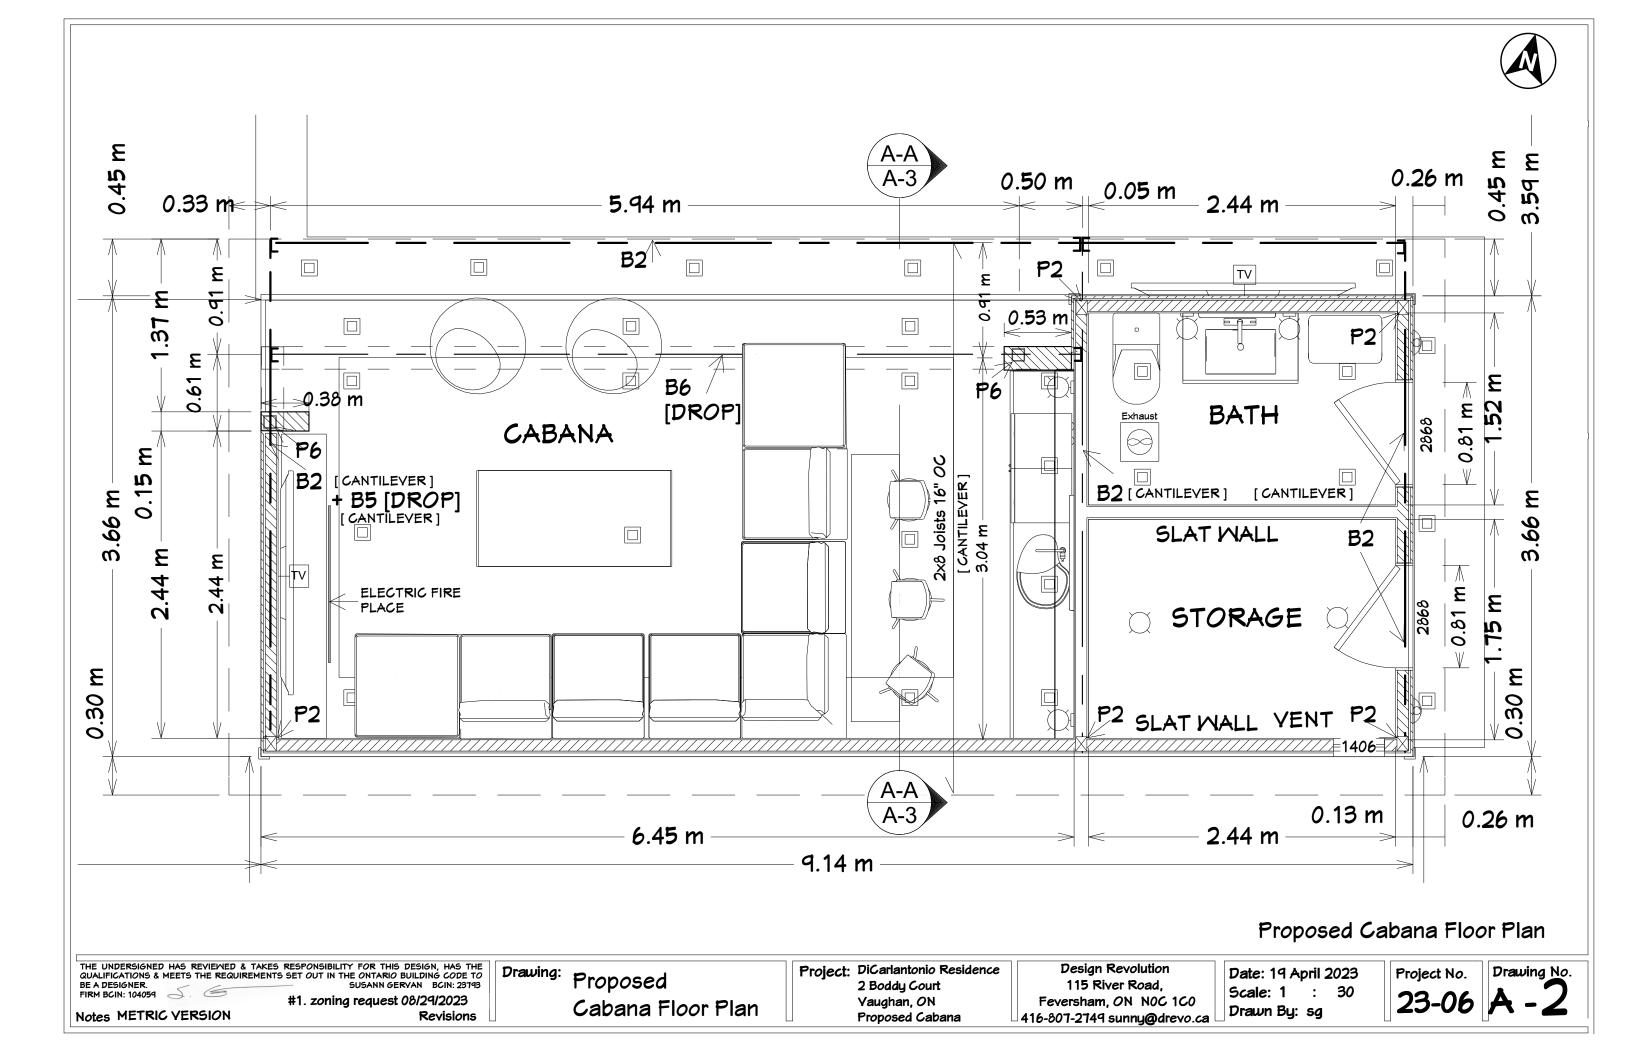

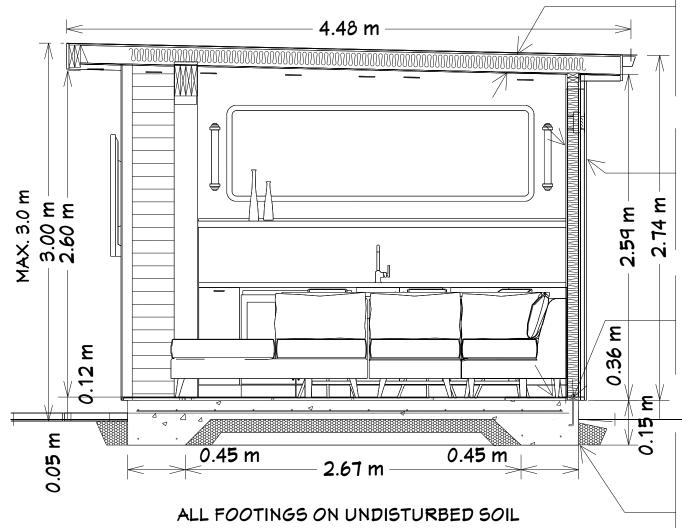

ROOF TYPICAL: MOD. BIT MEMBRANE ROLL ROOFING - PITCH 1/4:12 ICE AND WATER SHIELD TO MIN. 3'-0"AT EAVES 3/4" T&G EXTERIOR ROOF SHEATHING 2 x 8 RAFTERS@ 16"0/C RIGID INSULATION W/ VAPOUR BARRIER CEMENT BOARD STUCCO

EXTERIOR MALL: SIDING & STRAPPING OR STUCCO 5/8" EXTERIOR SHEATHING 2×4 STUDS @ 16" O/C DOUBLE TOP PLATE 1/2" CEMENT BOARD OR EQUIVALENT

TREATED WOOD SILL PLATE FASTENED TO FOUNDATION WALL W/ MINIMUM 12.7mm DIA ANCHOR BOLTS EMBEDDED MIN. 100mm IN CONCRETE @ 2400mm O/C MAX & PROVIDE CAULKING OR GASKET BETWEEN PLATE AND FOUNDATION WALL

GRADE TO SLOPE AWAY FROM FOUNDATION

TILE ON MIN. 75 mm POURED CONC. SLAB SLOPED TO DRAIN OUTSIDE CONTROL JOINT @ 4-5 m CAULKED 32 MPa @ 28 DAYS 5%-8% AIR ENTRAINMENT 18" WIDE THICKENED SLAB EDGE WITH 15 BAR @ 12" O/C EACH MAY 100 mm COMPACTED GRANULAR FILL FOOTING TO BEAR ON UNDISTURBED SOIL

Section A-A & Typical Details

THE UNDERSIGNED HAS REVIEWED & TAKES RESPONSIBILITY FOR THIS DESIGN, HAS THE QUALIFICATIONS & MEETS THE REQUIREMENTS SET OUT IN THE ONTARIO BUILDING CODE TO BE A DESIGNER. FIRM BCIN: 104059 SUSANN GERVAN BCIN: 23793

Notes METRIC YERSION

Drawing: Section A-A & **Typical Details** Project: DiCarlantonio Residence 2 Boddy Court Yaughan, ON Proposed Cabana


Design Revolution 115 River Road, Feversham, ON NOC 1C0 √416-807-2749 sunny@drevo.ca


Date: 19 April 2023 Scale: 1 : 30


Drawn By: sg

Project No.

Drawing No. 23-06 A - 3

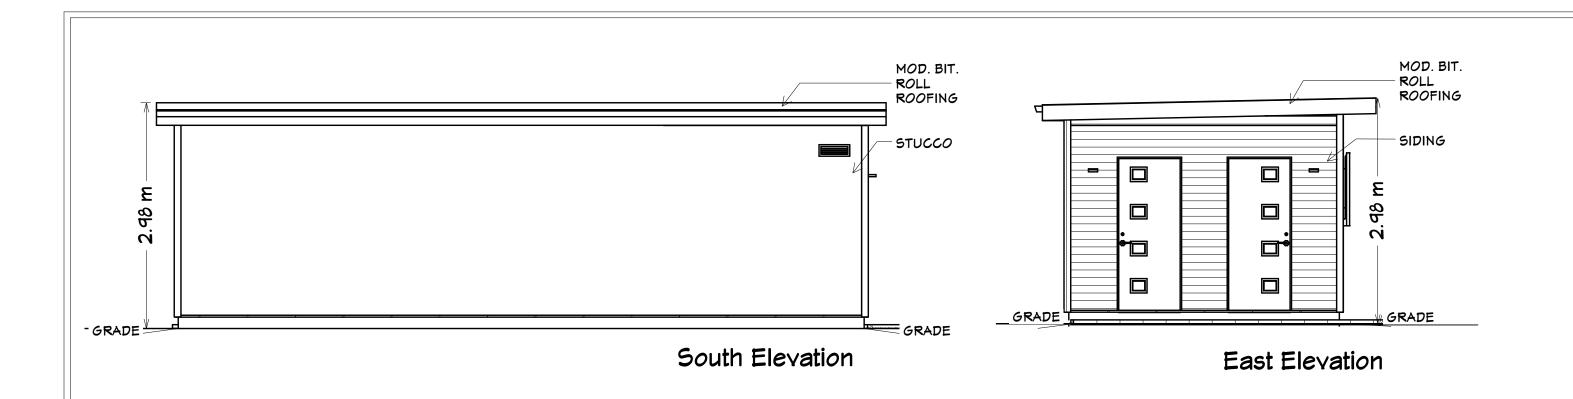

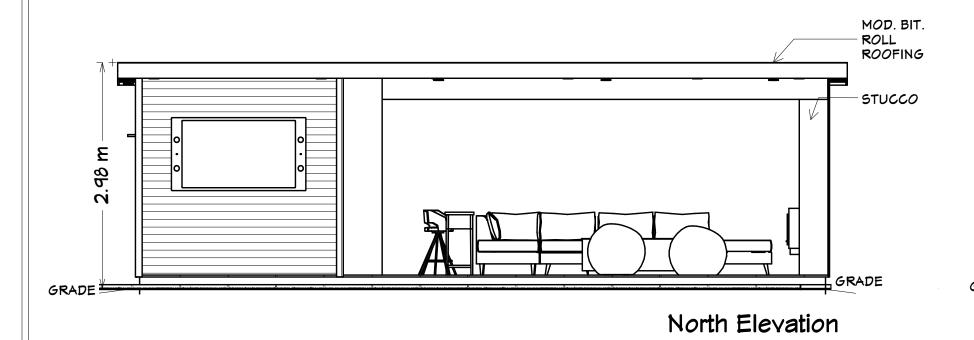

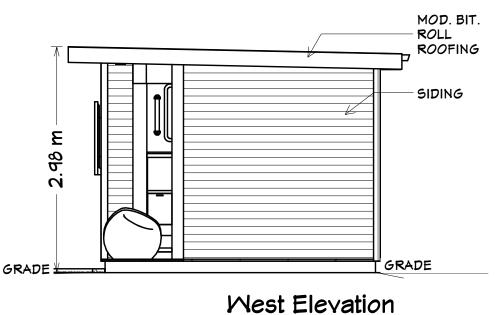

THE UNDERSIGNED HAS REVIEWED & TAKES RESPONSIBILITY FOR THIS DESIGN, HAS THE QUALIFICATIONS & MEETS THE REQUIREMENTS SET OUT IN THE ONTARIO BUILDING CODE TO BE A DESIGNER.

SUSANN GERVAN BCIN: 23793
FIRM BCIN: 104059

#11 zoning request 08/29/2023

Notes METRIC VERSION

#1. zoning request 08/29/2023 Revisions

Drawing: Proposed Elevations

Project: DiCarlantonio Residence 2 Boddy Court Yaughan, ON Proposed Cabana Design Revolution
115 River Road,
Feversham, ON NOC 1C0
416-807-2749 sunny@drevo.ca

Date: 19 April 2023 Scale: 1 : 50

Drawn By: sg

Project No. Drau

Drawing No.

A - 4

ALL LVL STRENGTH: 2900Fb-2.0E B1: 2-PLY 1³/₄" x 7¹/₄" LVL B2: 3-PLY 1³" x 7¹" LVL B3: 4-PLY 1³/₄" x 7¹/₄" LVL B4: 2-PLY 1¾" x 9¾" LVL B5: 3-PLY 1³/₄" x 9¹/₂" LVL B6: 4-PLY 1³/₄" x 9¹/₂" LVL B7: 2-PLY 1³" x 11⁷" LVL B8: 3-PLY 1³/₄" x 11⁷/₈" LVL B9: 4-PLY 1³/₄" x 11⁷/₈" LVL **ALL LVLS TO BE MIN. 2900Fb-2.0E** B10: W6 x 16 STEEL BEAM B11: W6 x 25 STEEL BEAM B12: W8 x 21 STEEL BEAM B13: W8 x 28 STEEL BEAM B14: W8 x 35 STEEL BEAM B15: W8 x 48 STEEL BEAM B16: W10 x 26 STEEL BEAM B17: W10 x 45 STEEL BEAM B18: 3-PLY 1 ³/₄" x 14" LVL B19: 4-PLY 1 ³/₄" x 14" LVL B20: 2-PLY 1 ³/₄" x 14" LVL **BP: BEAM POCKET:** MIN 4" SOLID BEARING CJ1: 2x6 SPF CEILING JOISTS @ 16" O/C CJ2: 2x8 SPF CEILING JOISTS @ 16" O/C CJ3: 2x10 SPF CEILING JOISTS @ 16" O/C F1: 36" x 36" x12" POURED CONCRETE PAD FOOTING WITH 15M @ 12" O/C EACH WAY F2: 24" x 24" x 10" POURED CONCRETE PAD FOOTING F3: 16" x 16" x 8" POURED CONCRETE PAD FOOTING F4: 42"x42"x16" POURED CONCRETE PAD FOOTING WITH 15M @ 10" O/C EACH WAY F5: 50"x50"x20" WITH 15M @8" O/C EACH WAY *ALL FOOTINGS ON UNDISTURBED SOIL; NOT GRAVEL FDN1: 8" CONCRETE BLOCK WITH 15M WITH 6" x 6" x $\frac{1}{4}$ " PATES VERTICAL REBAR @ 16" O/C DOWELED TO P11:HSS 5"X5"X3"WITH 10"X10"X3" TOP + TOP OF STRIP FOOTING BOTTOM PLATES FDN2: 10" CONCRETE BLOCK WITH 15M P/A: POST ABOVE VERTICAL REBAR @ 16" O/C DOWELED TO TOP OF STRIP FOOTING R1: 2 x 6 @ 16" O/C FDN3: 12" CONCRETE BLOCK WITH 15M R2: 2 x 8 @ 16" O/C VERTICAL REBAR @ 16" O/C DOWELED TO R3: 2 x 10 @ 16" O/C TOP OF STRIP FOOTING

*POURED CONCRETE MAY BE SUBSTITUTED FOR BLOCK: MAINTAIN SAME THICKNESS AND REINFORCEMENT H1: 2 x 8 SPF HIP RAFTER H2: 2 x 10 SPF HIP RAFTER H3: 2 x 12 SPF HIP RAFTER J1: 2 x 8 SPF @ 16" O/C J2: 2 x 10 SPF @ 16" O/C J3: 9½" TJI s31 @ 16" O/C J4: 9¹/₂" TJI s47 @ 16" O/C J5: 11⁷ TJI s31 @ 16" O/C J6: 11⁷/₈" TJI s47 @ 16" O/C J7: 14" TJI s47 @16" O/C WITH $\frac{3}{4}$ " SUBFLOOR DJ: DOUBLE JOIST TJ: TRIPLE JOIST L1: (2) - 2 x 8 SPF LINTEL L2: (3) - 2 x 8 SPF LINTEL L3: (2) - 2 x 10 SPF LINTEL L4: (3) - 2 x 10 SPF LINTEL LDGR1: 2 x 8 PT LEDGER FASTENED WITH ½" Ø ANCHOR BOLTS @ 16" O/C LDGR2: 2 x 10 PT LEDGER FASTENED WITH ½" Ø ANCHOR BOLTS @ 16" O/C N1: 2 x 8 SPF NAILER ON FLAT N2: 2 x10 SPF NAILER ON FLAT N3: 2 x 12 SPF NAILER ON FLAT P1: (3) - 2 x 4 POST P2: (4) - 2 x 4 POST P3: (3) - 2 x 6 POST P4: (4) - 2 x 6 POST P5: HSS $3\frac{1}{2}$ Ø x $\frac{1}{4}$ POST WITH 6" x 6" x $\frac{1}{4}$ " PLATES P6: HSS 4" x 4" x $\frac{1}{4}$ " POST WITH 6" x 6" x $\frac{1}{4}$ " PLATES P7: 4 x 4 PT POST P8: 6 x 6 PT POST P9: (5) - 2 x 6 POST P10: HSS 3 ½" x 3 ½" x ¼" POST

RB1: 2 x 8 RIDGE BOARD RB2: 2 x 10 RIDGE BOARD RB3: 2 x 12 RIDGE BOARD SL1: $3\frac{1}{2}$ " x $3\frac{1}{2}$ " x $\frac{1}{4}$ " STEEL ANGLE LINTEL SL2: $4" \times 3\frac{1}{2}" \times \frac{1}{4}"$ STEEL ANGLE LINTEL SL3: 5" x $3\frac{1}{2}$ " x $\frac{5}{16}$ " STEEL ANGLE LINTEL SL4: 6" x 4" x 3" STEEL ANGLE LINTEL V1: (2) 2 x 8 SPF VALLEY RAFTER V2: (2) 2 x 10 SPF VALLEY RAFTER V3: (2) 2 x 12 SPF VALLEY RAFTER SW1: TIMBER FRAMED SHEAR WALL. 2X6 STUDS AT 8" O/C WITH BLOCKING@24" O/C WITH $\frac{3}{4}$ " TICK PLYWOOD SHEATHING BOTH SIDES FASTENED WITH NAILS @2" O/C. FASTEN BOTTOM SILL PLATE TO FRAMING BELOW WITH ½" DIAMETER LAG SCREW @8" O/C OR TO FOUNDATION BELOW WITH $\frac{1}{2}$ " DIAMETER BOLTS @8" O/C. [ENSURE OVERALL WIDTH TO HEIGHT RATIO OF SHEAR WALL IS GREAT THAN 1:3.5]

SW2: TIMBER FRAMED SHEAR WALL. 2X4 STUDS AT 8" O/C WITH BLOCKING@24" O/C WITH $\frac{3}{4}$ " TICK PLYWOOD SHEATHING BOTH SIDES FASTENED WITH NAILS @2" O/C. FASTEN **BOTTOM SILL PLATE TO FRAMING BELOW** WITH ½" DIAMETER LAG SCREW @8" O/C OR TO FOUNDATION BELOW WITH $\frac{1}{2}$ " DIAMETER BOLTS @8" O/C. [ENSURE OVERALL WIDTH TO HEIGHT RATIO OF SHEAR WALL IS GREAT THAN 1:3.5]

ICFL1: MIN. 9" DEEP ICF LINTEL WITH (2)-15M REBAR + STIRRUPS @4" O.C.+SL3 **BRICK LINTEL**

ICFL2: MIN. 15" DEEP ICF LINTEL WITH +SL3 BRICK LINTEL (2)-15M REBAR+STIRRUPS @6" O.C.

ICFL3: MIN. 18" DEEP ICF LINTEL WITH

(2)-15M REBAR + 10M STIRRUPS @4" O.C. +SL4 BRICK LINTEL

NOTES:

THE BUILDING DEPARTMENT ULTIMATELY DETERMINES WHETHER TO APPROVE THE SUBMITTED PERMIT DRAWINGS AS-IS OR WITH REQUESTED CHANGES TO OUR DESIGN.

WE CANNOT BE RESPONSIBLE FOR ANY CONSTRUCTION MATERIALS ORDERED AND/OR COMMENCEMENT OF CONSTRUCTION PRIOR TO BUILDING PERMIT ISSUANCE.

YOUR CONTRACTOR IS RESPONSIBLE FOR SITE VERIFYING ALL ASSUMPTIONS AND DIMENSIONS INDICATED ON THE PERMIT DRAWINGS PRIOR TO CONSTRUCTION.

IN CASE OF DISCREPANCIES, YOUR CONTRACTOR IS TO REPORT THEM TO US FOR REVIEW PRIOR TO PROCEEDING WITH CONSTRUCTION AND ORDERING MATERIAL.

OUR PERMIT DRAWINGS ARE GUIDELINE DESIGN DRAWINGS. YOUR CONTRACTOR IS RESPONSIBLE FOR THE SAFE EXECUTION OF OUR DESIGN.

THIS MEANS ENSURING A SAFE CONSTRUCTION SITE IS MAINTAINED. INCLUDING PROVIDING ALL REQUIRED TEMPORARY SHORING/BRACING OF **EXISTING AND NEW STRUCTURES** DURING CONSTRUCTION.

CALLING FOR INSPECTIONS (INCLUDING DETERMINING THE MILESTONE EVENTS) DURING CONSTRUCTION IS THE RESPONSIBILITY OF YOUR CONTRACTOR.


FOR FOOTINGS AND UNDERPINNING, INSPECTIONS ARE CONDUCTED PRIOR TO CONCRETE PLACEMENT, WHILE FOR STEEL AND TIMBER FRAMING. INSPECTIONS ARE CONDUCTED AFTER **INSTALLATION BUT BEFORE FINISHES** (DRYWALL, INSULATION, ETC.)

PROVIDE STEEL SHOP DRAWINGS FOR REVIEW AND APPROVAL PRIOR TO **FABRICATION AND CONSTRUCTION**

GENERAL NOTES:

CALLING FOR INSPECTIONS BY THE

- ALL DIMENSIONS SHOWN ON STRUCTURAL, ARCHITECTURAL MECHANICAL AND ELECTRICAL DISCREPANCIES TO THE ENGINEERS O
- NEIGHBOURS HOUSE, SIDEWALK, ROAD UTILITIES, ETC.) WHERE EXCAVATION IS REQUIRED.
 ALL TEMPORARY SHORING AND BRACIN
- CONSTRUCTION IS THE RESPONSIBILIT OF THE CONTRACTOR. CONTRACTOR SHALL SITE VERIFY ALL
- AND REPORT AND DISCREPANCIES TO THE ENGINEER OF RECORD.
- DO NOT PROCEED WITH INSULATION OF DRYWALL UNTIL STRUCTURAL INSPECTIONS HAVE BEEN PASSED (WIT WRITTEN CONFIRMATION)

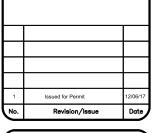



STRUCTURAL LEGEND

TORONTO ON





THE UNDERSIGNED HAS REVIEWED & TAKES RESPONSIBILITY FOR THIS DESIGN, HAS THE QUALIFICATIONS & MEETS THE REQUIREMENTS SET OUT IN THE ONTARIO BUILDING CODE TO BE A DESIGNER.

FIRM BCIN: 104059

#1 zoning request 08/29/2023

Notes METRIC VERSION

#1. zoning request 08/29/2023 Revisions

Design Revolution
115 River Road,
Feversham, ON N0C 1C0
416-807-2749 sunny@drevo.ca

Date: 19 April 2023 Scale: = 1' - 0"

Drawn By: sg

Project No.

o. Drawing No. **A** - **6**







THE UNDERSIGNED HAS REVIEWED & TAKES RESPONSIBILITY FOR THIS DESIGN, HAS THE QUALIFICATIONS & MEETS THE REQUIREMENTS SET OUT IN THE ONTARIO BUILDING CODE TO BE A DESIGNER.

SUSANN GERVAN BCIN: 23143
FIRM BCIN: 104059

#1 zoning request 08/29/2023

#1. zoning request 08/29/2023 Revisions

Drawing:

Project: DiCarlantonio Residence 2 Boddy Court Vaughan, ON Proposed Cabana

Design Revolution
115 River Road,
Feversham, ON NOC 1C0
416-807-2749 sunny@drevo.ca


Date: 19 April 2023

Scale: = 1' - 0"

Drawn By: sg

Project No.

Drawing No.

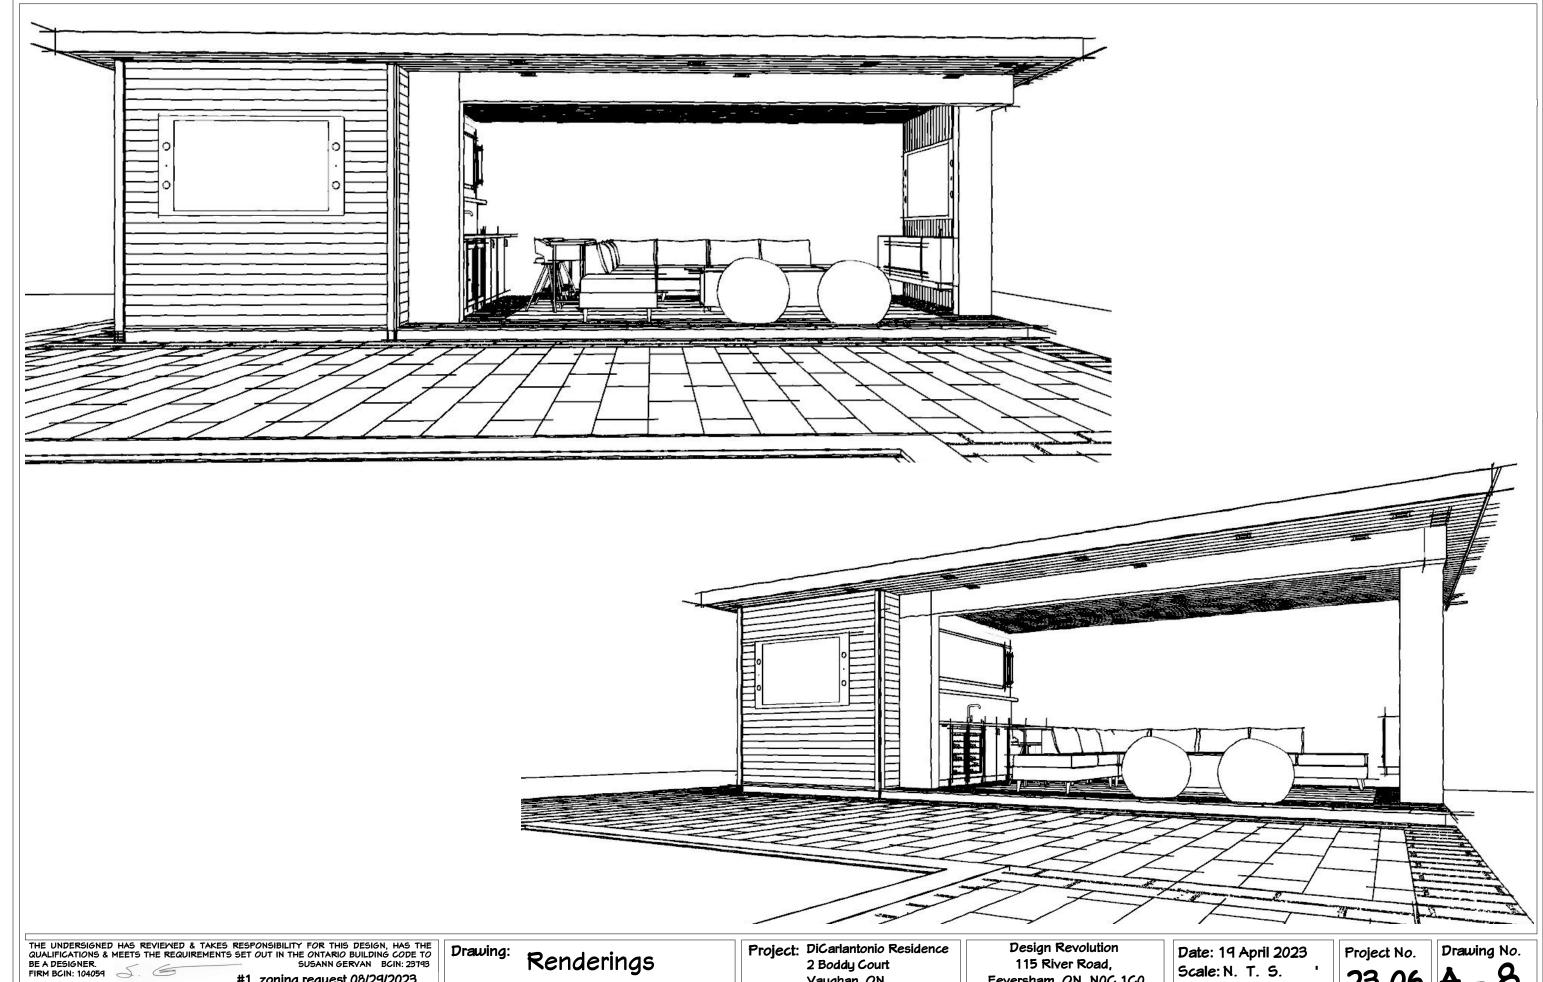

#1. zoning request 08/29/2023 Notes METRIC VERSION

Revisions

Renderings

Vaughan, ON Proposed Cabana

115 River Road, Feversham, ON NOC 1C0 416-807-2749 sunny@drevo.ca

Scale: N. T. S. Drawn By: sg

SCHEDULE B: STAFF & AGENCY COMMENTS				
DEPT/AGENCY	Circulated	Comments Received	Conditions	Nature of Comments
TRCA	\boxtimes			General Comments
Ministry of Transportation (MTO)				
Region of York	\boxtimes			General Comments
Alectra	\boxtimes			General Comments
Bell Canada	\boxtimes			No Comments Received to Date
YRDSB				
YCDSB				
CN Rail				
CP Rail				
TransCanada Pipeline	\boxtimes			No Comments Received to Date
Metrolinx				
Propane Operator				
Development Planning	\boxtimes			Recommend Approval/no conditions
Building Standards (Zoning)	\boxtimes			General Comments



Date: August 30th 2023

Attention: Christine Vigneault

RE: Request for Comments

File No.: A132-23

Related Files:

Applicant Design Revolution

Location 2 Boddy Court



COMMENTS:

	We have reviewed the proposed Variance Application and have no comments or objections to its approval.
X	We have reviewed the proposed Variance Application and have no objections to its approval, subject to the following comments (attached below).
	We have reviewed the proposed Variance Application and have the following concerns (attached below).

Alectra Utilities (formerly PowerStream) has received and reviewed the proposed Variance Application. This review, however, does not imply any approval of the project or plan.

All proposed billboards, signs, and other structures associated with the project or plan must maintain minimum clearances to the existing overhead or underground electrical distribution system as specified by the applicable standards, codes and acts referenced.

In the event that construction commences, and the clearance between any component of the work/structure and the adjacent existing overhead and underground electrical distribution system violates the Occupational Health and Safety Act, the customer will be responsible for 100% of the costs associated with Alectra making the work area safe. All construction work will be required to stop until the safe limits of approach can be established.

In the event construction is completed, and the clearance between the constructed structure and the adjacent existing overhead and underground electrical distribution system violates the any of applicable standards, acts or codes referenced, the customer will be responsible for 100% of Alectra's cost for any relocation work.

References:

- Ontario Electrical Safety Code, latest edition (Clearance of Conductors from Buildings)
- Ontario Health and Safety Act, latest edition (Construction Protection)
- Ontario Building Code, latest edition (Clearance to Buildings)
- PowerStream (Construction Standard 03-1, 03-4), attached
- Canadian Standards Association, latest edition (Basic Clearances)

If more information is required, please contact either of the following:

Mr. Stephen Cranley, C.E.T

Supervisor, Distribution Design, ICI & Layouts (North)

Phone: 1-877-963-6900 ext. 31297

E-mail: stephen.cranley@alectrautilities.com

Mitchell Penner

Supervisor, Distribution Design-Subdivisions

Phone: 416-302-6215

Email: Mitchell.Penner@alectrautilities.com



Power Stream 1

Construction Standard

03-1

	SYSTEM VOLTAGE				
LOCATION OF WIRES, CABLES OR CONDUCTORS	SPAN GUYS AND COMMUNICATIONS WIRES		4.16/2.4kV TO 27.6/16kV (SEE NOTE 1)	44kV	
	MINIMUM VERTICAL CLEARANCES (SEE NOTE 2)		NOTE 2)		
OVER OR ALONGSIDE ROADS, DRIVEWAYS OR LANDS ACCESSIBLE TO <u>VEHICLES</u>	442cm	442cm	480cm	520cm	
OVER GROUND ACCESSIBLE TO PEDESTRIANS AND BICYCLES ONLY	250cm	310cm	340cm	370cm	
ABOVE TOP OF RAIL AT RAILWAY CROSSINGS	730cm	730cm	760cm	810cm	



MINIMUM ATTACHMENT HEIGHT = MAXIMUM SAG

- + MINIMUM VERTICAL CLEARANCE (FROM ABOVE TABLE)
 ± GRADE DIFFERENCE

- + 0.3m (VEHICLE OR RAILWAY LOCATION) + SNOW DEPTH (PEDESTRIAN LOCATION, SEE NOTE 3)

NOTES:

- THE MULTIGROUNDED SYSTEM NEUTRAL HAS THE SAME CLEARANCE AS THE 600V SYSTEM.
- 2. THE VERTICAL CLEARANCES IN THE ABOVE TABLE ARE UNDER $\underline{\text{MAXIMUM SAG}}$ CONDITIONS.
- 3. REFER TO CSA STANDARD C22.3 No.1, ANNEX D FOR LOCAL SNOW DEPTH
- 4. ALL CLEARANCES ARE IN ACCORDANCE TO CSA STANDARD C22.3.

<u>\G</u>	340cm	11'-4"		
	310cm	10'-4"		
VALUES.	250cm	8'-4"		
VALUES.				
REFERENCES				
SAGS AND T	FNSIONS 1	SECTION 02		

METRIC

810cm

760cm 730cm

520cm 480cm

442cm 370cm

CONVERSION TABLE

IMPERIAL (APPROX)

27'-0" 25'-4"

24'-4" 17'-4"

15'-5" 12'-4"

MINIMUM VERTICAL CLEARANCES OF WIRES, CABLES AND CONDUCTORS ABOVE GROUND OR RAILS

ORIGINAL ISSUE DATE: 2010-DEC-24 REVISION NO: R1 REVISION DATE: 2012-JAN-09

Certificate of Approval This construction Standard meets the safety requirements of Section 4 of Regulation 22/04		
Joe Crozier, P.Eng. 2012-JAN-09 Name Date		
P Fng. Approval By:	Ine Crozier	



Construction Standard

03 - 4





VOLTAGE	MINIMUM HORIZONTAL CLEARNACE UNDER MAXIMUM SWING CONDITIONS DIMENSION "X" (SEE NOTES 1, 3 & 4)	MINIMUM VERTICAL CLEARANCE UNDER MAXIMUM DESIGN SAG CONDITIONS DIMENSION "Y" (SEE NOTES 1, 2, 4 & 5)
0-600V AND NEUTRAL	100cm	250cm
4.16/2.4 TO 44kV	300cm	480cm

NOTES

- UNDER NO CIRCUMSTANCES SHALL A CONDUCTOR BE PERMITTED TO PENETRATE THE ENVELOPE SHOWN BY THE DOTTED LINE.
- 2. THE VERTICAL CLEARANCES ARE UNDER CONDITIONS OF MAXIMUM DESIGN SAG.
- THE HORIZONTAL CLEARANCES ARE UNDER CONDITIONS OF MAXIMUM SWING. WHERE THE CONDUCTOR SWING IS NOT KNOWN A HORIZONTAL CLEARANCE OF 480CM SHALL BE USED.
- 4. BUILDINGS THAT EXCEED 3 STOREYS OR 15M IN HEIGHT, THE MINIMUM HORIZONTAL CLEARANCE OF THE SECONDARY CONDUCTORS SHOULD BE INCREASED TO 300cm WHERE IT IS NECESSARY TO ALLOW FOR THE RAISING OF LADDERS BY LOCAL FIRE DEPARTMENTS.
- IN SITUATIONS SUCH AS MULTI-LEVEL GARAGES, WHERE ROOFS ARE NORMALLY USED BY PERSONS AND VEHICLES, THE VERTICAL CLEARANCES OF POWERSTREAM STANDARD 03-1 SHALL APPLY.
- 6. DISTRIBUTION LINES CONSTRUCTED NEAR BUILDINGS SHALL BE BUILT TO AVOID OVERHANG WHEREVER POSSIBLE. WHERE LINES MUST BE CONSTRUCTED OVER OR ADJACENT TO BUILDINGS THE APPLICABLE HORIZONTAL AND VERTICAL CLEARANCES SHALL BE AT CONDITIONS OF MAXIMUM CONDUCTOR SWING AND MAXIMUM SAG. THE ABOVE CLEARANCES ARE DESIGNED TO PREVENT PERSONS ON OR IN BUILDINGS AS WELL AS EXTERNAL MACHINERY USED IN CONJUCTION WITH A BUILDING TO COME IN CONTACT WITH CONDUCTORS. EFFORTS SHOULD BE MADE TO INCREASE THESE CLEARANCES WHERE POSSIBLE.
- 7. ALL CLEARANCES ARE IN ACCORDANCE TO CSA C22.3 NO.1-06 (TABLE-9).

ON TABLE	
IMPERIAL	
(APPROX)	
16'-0"	
10'-0"	
8'-4"	
3'-4"	

MINIMUM VERTICAL & HORIZONTAL CLEARANCES OF CONDUCTORS FROM BUILDINGS OR OTHER PERMANENT STRUCTURES (CONDUCTORS NOT ATTACHED TO BUILDINGS)

ORIGINAL ISSUE DATE: 2010—MAY—05 REVISION NO: REVISION DATE:
PEgystem Planning and Standards/Standard Design/PowerStream Standards/soundard working (lighter/Seedlan 3/3-4/c/wg d3-4 Ro May 5, 2010, s/wg, 3/3/2010 8/2022 AM, Adobe POF



To: Committee of Adjustment

From: Christian Tinney, Building Standards Department

Date: August 29, 2023

Applicant: Design Revolution

Location: 2 Boddy Court

PLAN 65M2703 Lot 30

File No.(s): A132/23

Zoning Classification:

The subject lands are zoned R2A(EN), Second Density Residential Zone subject to the provisions of Exception 14.474 under Zoning By-law 001-2021, as amended.

#	Zoning By-law 001-2021	Variance requested
1	An accessory building or residential accessory structure shall	To permit a minimum exterior
	not be closer to an exterior side lot line than the principal	side yard setback of 2.51 metres
	building on the lot (5.38 metres).	to an accessory building
		(Cabana).

Staff Comments:

Stop Work Order(s) and Order(s) to Comply:

There are no outstanding Orders on file.

Building Permit(s) Issued:

Building Permit No. 23-119677 for Shed/Gazebo - New, Issue Date: (Not Yet Issued)

Other Comments:

General Comments

1 The applicant shall be advised that additional variances may be required upon review of detailed drawing for building permit/site plan approval.

Conditions of Approval:

If the committee finds merit in the application, the following conditions of approval are recommended.

^{*} Comments are based on the review of documentation supplied with this application.



To: Christine Vigneault, Committee of Adjustment Secretary Treasurer

From: Nancy Tuckett, Director of Development Planning

Date: October 6, 2023

Name of Owners: Sergio Di Carlantonio & Melanie Di Carlantonio

Location: 2 Boddy Court

File No.(s): A132/23

Proposed Variance (By-law 001-2021):

1. To permit a minimum exterior side yard setback of 2.51 metres to an accessory building (Cabana).

By-Law Requirement (By-law 001-2021):

1. An accessory building or residential accessory structure shall not be closer to an exterior side lot line than the principal building on the lot (5.38 metres).

Official Plan:

Vaughan Official Plan 2010 ('VOP 2010'): "Low-Rise Residential".

Comments:

The Owners are requesting relief to permit the construction an accessory structure (Cabana) at 2 Boddy Court with the above noted variance.

The Development Planning Department has no objection to Variance 1 to permit a minimum exterior side yard setback of 2.51 metres to an accessory building (cabana), which is closer to the exterior side lot line than the principal building on the lot. The cabana will be partially screened from the abutting street and sidewalk by the existing wood privacy fence. Three (3) trees are also proposed between the fence that runs along exterior side lot line and the cabana to provide additional screening. Two (2) additional trees are proposed at the rear of the structure and one (1) additional tree is proposed at the front entrance to the backyard in order to provide additional screening from the street. The proposed 2.51 m exterior side lot line setback is a sufficient depth to accommodate the proposed screening vegetation, and for access and maintenance. As such, the proposed cabana will not pose any adverse use or streetscape impacts to the abutting properties.

In support of the application, the Owners submitted an Arborist Report prepared by Noica Consulting Inc., revised October 2, 2023, and Tree Protection Plan prepared by Design Revolution, submitted October 3, 2023. The report inventoried fourteen (14) trees, all of which are proposed to be preserved throughout construction. Urban Design staff have reviewed the report and concur with its recommendations.

Accordingly, the Development Planning Department can support the requested variance and is of the opinion that the proposal is minor in nature, maintains the general intent and purpose of the Official Plan and Zoning By-law, and is desirable for the appropriate development of the land.

Recommendation:

The Development Planning Department recommends approval of the application.

memorandum



Conditions of Approval:

If the Committee finds merit in the application, the following conditions of approval are recommended:

None.

Comments Prepared by: Nicholas Del Prete, Planner I David Harding, Senior Planner

Lenore Providence

From: Kristen Regier < Kristen.Regier@trca.ca>

Sent: August-30-23 11:50 AM **To:** Committee of Adjustment

Cc: Lenore Providence; Christine Vigneault

Subject: [External] RE: A132/23 - 2 Boddy Court not 113 Anthony Lane - REQUEST FOR COMMENTS

Hello,

The subject property at 2 Boddy Court, Vaughan is not located within TRCA's Regulated Area. TRCA's Planning and Regulatory policy interests are not impacted.

As such, TRCA has no comments on the application.

Best,

Kristen Regier, MA (she / her)

Planner I

Development Planning and Permits | Development and Engineering Services Toronto and Region Conservation Authority (TRCA)

T: 437-880-2129

E: kristen.regier@trca.ca

A: 101 Exchange Avenue, Vaughan, ON, L4K 5R6 | trca.ca



Lenore Providence

From: Development Services <developmentservices@york.ca>

Sent: August-31-23 11:42 AM
To: Lenore Providence

Cc: Committee of Adjustment

Subject: [External] RE: A132/23 - 2 Boddy Court not 113 Anthony Lane - REQUEST FOR COMMENTS

Hi Lenore,

The Regional Municipality of York has completed its review of the above minor variance (A132/23) and has no comment.

Many thanks,

Our working hours may be different. Please do not feel obligated to reply outside of your scheduled working hours. Let's work together to help foster healthy work-life boundaries.

Niranjan Rajevan, M.PI. | Associate Planner, Development Services, Planning and Economic Development, Corporate Services

The Regional Municipality of York | 17250 Yonge Street | Newmarket, ON L3Y 6Z1 1-877-464-9675 ext. 71521 | niranjan.rajevan@york.ca | www.york.ca

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SCHEDULE C: PUBLIC & APPLICANT CORRESPONDENCE

None

SCHEDULE D: PREVIOUS COA DECISIONS ON THE SUBJECT LAND

None