ITEM #: 6.26

COMMITTEE OF ADJUSTMENT REPORT SUMMARY MINOR VARIANCE APPLICATION FILE NUMBER A313/22 67 OBERFRICK AVE, MAPLE

THIS REPORT CONTAINS COMMENTS FROM THE FOLLOWING DEPARTMENTS & AGENCIES:

*Please see **Schedule B** of this report for a copy of Development Planning and Agency correspondence.

Additional comments from departments and agencies may be received after the publication of the Staff Report. These comments will be processed as an addendum and posted on the City's Website.

DEPARTMENTS	Circulated	Comments Received	Conditions	Nature of Comments
Committee of Adjustment	\boxtimes	\boxtimes		General Comments
Building Standards (Zoning Review)	\boxtimes	\boxtimes		General Comments
Building Inspection (Septic)	\boxtimes			No Comments Received to Date
Development Planning	\boxtimes			Recommend Approval/No Conditions
Development Engineering	\boxtimes			Recommend Approval/No Conditions
Parks, Forestry and Horticulture Operations	\boxtimes			No Comments Received to Date
By-law & Compliance, Licensing & Permits	\boxtimes			No Comments Received to Date
Development Finance	\boxtimes			No Comments Received to Date
Real Estate				
Fire Department	\boxtimes			No Comments Received to Date
AGENCIES	Circulated	Comments Received	Conditions	Nature of Comments
TRCA	\boxtimes			No Comments Received to Date
Ministry of Transportation (MTO)				
Region of York	\boxtimes	\boxtimes		General Comments
Alectra	\boxtimes	\boxtimes		General Comments
Bell Canada	\boxtimes			No Comments Received to Date
YRDSB				
YCDSB				
CN Rail				
CP Rail				
TransCanada Pipeline	\boxtimes			No Comments Received to Date
Metrolinx				
Propane Operator				

PUBLIC & APPLICANT CORRESPONDENCE

*Please see **Schedule C** of this report for a copy of the public & applicant correspondence listed below.

The deadline to submit public comments is noon on the last business day prior to the scheduled hearing date.

Comments and written public submissions received after the publication of this Staff Report will be processed as an addendum and posted on the City's Website.

All personal information collected because of this public meeting (including both written and oral submissions) is collected under the authority of the Municipal Act, the Municipal Freedom of Information and Protection of Privacy Act (MFIPPA), the Planning Act and all other relevant legislation, and will be used to assist in deciding on this matter. All personal information (as defined by MFIPPA), including (but not limited to) names, addresses, opinions and comments collected will become property of the City of Vaughan, will be made available for public disclosure (including being posted on the internet) and will be used to assist the Committee of Adjustment and staff to process this application.

Correspondence Type	Name	Address	Date Received	Summary
31			(mm/dd/yyyy)	
None				

PREVIOUS COA DECISIONS ON THE SUBJECT LAND		
	*Please see Schedule D for	a copy of the Decisions listed below
File Number	Date of Decision MM/DD/YYYY	Decision Outcome
None		

ADJOURNMENT HISTORY	
* Previous hearing dates where this application was adjourned by the Committee and public notice issued.	
None	



COMMITTEE OF ADJUSTMENT REPORT MINOR VARIANCE APPLICATION A313/22

67 OBERFRICK AVE, MAPLE

CITY WARD #: 4
Xuda Zhang
Lhw Engineering Ltd.
67 Oberfrick Ave, Maple
See Below
Vaughan Official Plan 2010 ('VOP 2010'): "Low-Rise Residential"
None
Relief from the Zoning By-law is being requested to permit an existing deck.

The following variances have been requested from the City's Zoning By-law:

The subject lands are zoned R3(EN) – Estate Residential Zone (Established Neighbourhood) and subject to the provisions of Exception 14.877 under Zoning By-law 001-2021, as amended.

#	Zoning By-law 001-2021	Variance requested
1	none	

The subject lands are zoned RD3 –Residential Detached Zone and subject to the provisions of Exception 9(1234) under Zoning By-law 1-88, as amended.

	Zoning By-law 1-88	Variance requested
2	The maximum permitted encroachment for the basement deck is 1.8m into the required 7.5m rear yard setback.	To permit an encroachment for the existing basement deck of 2.64m into the required 7.5m rear
		yard setback.

HEARING INFORMATION

DATE OF MEETING: Thursday, January 26, 2023

TIME: 6:00 p.m.

MEETING LOCATION: Vaughan City Hall, Council Chamber, 2141 Major Mackenzie Drive, Vaughan

LIVE STREAM LINK: <u>Vaughan.ca/LiveCouncil</u>

PUBLIC PARTICIPATION

If you would like to speak to the Committee of Adjustment at the meeting, either remotely or in person, please complete the Request to Speak Form and submit to cofa@vaughan.ca

If you would like to submit written comments, please quote file number above and submit by mail or email

Email: cofa@vaughan.ca

Mail: City of Vaughan, Office of the City Clerk, Committee of Adjustment, 2141 Major Mackenzie Drive, Vaughan, ON, L6A 1T1

THE DEADLINE TO <u>REGISTER TO SPEAK</u> OR <u>SUBMIT WRITTEN COMMENTS</u> ON THE ABOVE NOTED FILE(S) IS <u>NOON</u> ON THE LAST BUSINESS DAY BEFORE THE MEETING.

INTRODUCTION

Staff and Agencies act as advisory bodies to the Committee of Adjustment. The comments contained in this report are presented as recommendations to the Committee.

Section 45(1) of the Planning Act sets the criteria for authorizing minor variances to the City of Vaughan's Zoning By-law. Accordingly, review of the application may consider the following:

INTRODUCTION

That the general intent and purpose of the by-law will be maintained.

That the general intent and purpose of the official plan will be maintained.

That the requested variance(s) is/are acceptable for the appropriate development of the subject lands.

That the requested variance(s) is/are minor in nature.

Public written and oral submissions relating to this application are taken into consideration by the Committee of Adjustment as part of its deliberations and final decision on this matter.

COMMITTEE OF ADJUSTMENT COMMENTS		
Date Public Notice Mailed:	January 12, 2023	
Date Applicant Confirmed Posting of Sign:	January 12, 2023	
Applicant Justification for Variances: *As provided by Applicant in Application Form	The relief will allow the subject prope shelter to cover the walk-out deck be	
Adjournment Requests (from staff): *Adjournment requests provided to applicant prior to issuance of public notice	None	
Was a Zoning Review Waiver (ZRW) Form	submitted by Applicant:	No
*ZRW Form may be used by applicant in instances where a revised submission is made, and zoning staff do not have an opportunity to review and confirm variances prior to the issuance of public notice.		
*A revised submission may be required to address staff / agency comments received as part of the application review process.		
*Where a zoning review has not been completed on a revised submission, an opportunity is provided to the applicant to adjourn the proposal prior to the issuance of public notice.		
Adjournment Fees:		
In accordance with Procedural By-law 069-2019, an Adjournment Fee is applicable to reschedule an application after the issuance of public notice where a request for adjournment has been provided to the applicant prior to the issuance of public notice. An Adjournment Fee can only be waived in instances where adjournment of an application is requested by the		
Committee or staff after the issuance of public notice.		
Committee of Adjustment Comments:	None	
Committee of Adjustment Recommended Conditions of Approval:	None	
BUILDING STANDARDS (ZONING) COMMENTS		

BUILDING STANDARDS (ZONING) COMMENTS	
**See Schedule B for Building Standards (Zoning) Comments	
Building Standards Recommended Conditions of Approval:	None

DEVELOPMENT PLANNING COMMENTS	
**See Schedule B for Development Planning Comments.	
Development Planning Recommended	None
Conditions of Approval:	

DEVELOPMENT ENGINEERING COMMENTS

<u>Link to Grading Permit</u> <u>Link to Pool Permit</u> <u>Link to Curb Curt Permit</u> <u>Link Culvert Installation</u>

The property at 67 Oberfrick Ave was issued a grading permit in September of 2011. After review of this permit, Development Engineering believes the proposed deck will not interfere with any existing drainage swales in the rear yard.

The Development Engineering Department does not object to the Minor Variance application A313/22

A313/22.	
Development Engineering	None
Recommended Conditions of	
Approval:	

PARKS, FORESTRY & HORTICULTURE (PFH) COMMENTS

No comments received to date.

PARKS, FORESTRY & HORTICULTURE (PFH) COMMENTS	
PFH Recommended Conditions of Approval:	None

DEVELOPMENT FINANCE COMMENTS					
No comments received to date.					
Development Finance Recommended Conditions of Approval:	None				

BY-LAW AND COMPLIANCE, LICENSING AND PERMIT SERVICES COMMENTS						
No comments received to date.						
BCLPS Recommended Conditions of Approval:	None					

BUILDING INSPECTION (SEPTIC) COMMENTS				
No comments received to date.				
Building Inspection Recommended Conditions of Approval:	None			

FIRE DEPARTMENT COMMENTS					
No comments received to date.					
Fire Department Recommended Conditions of Approval:	None				

SCHEDULES TO STAFF REPORT *See Schedule for list of correspondence					
Schedule A	Drawings & Plans Submitted with the Application				
Schedule B	Staff & Agency Comments				
Schedule C (if required)	Correspondence (Received from Public & Applicant)				
Schedule D (if required)	Previous COA Decisions on the Subject Land				

Should the Committee find it appropriate to approve this application in accordance with request and the sketch submitted with the application, as required by Ontario Regulation 200/96, the following conditions have been recommended:

All conditions of approval, unless otherwise stated, are considered to be incorporated into the approval "if required". If a condition is no longer required after an approval is final and binding, the condition may be waived by the respective department or agency requesting conditional approval. A condition cannot be waived without written consent from the respective department or agency. # DEPARTMENT / AGENCY CONDITION(S) DESCRIPTION

IMPORTANT INFORMATION – PLEASE READ

None

CONDITIONS: It is the responsibility of the owner/applicant and/or authorized agent to obtain and provide a clearance letter from respective department and/or agency (see condition chart above for contact). This letter must be provided to the Secretary-Treasurer to be finalized. All conditions must be cleared prior to the issuance of a Building Permit.

IMPORTANT INFORMATION - PLEASE READ

APPROVALS: Making any changes to your proposal after a decision has been made may impact the validity of the Committee's decision.

An approval obtained from the Committee of Adjustment, where applicable, is tied to the building envelope shown on the plans and drawings submitted with the application and subject to the variance approval.

A building envelope is defined by the setbacks of the buildings and/or structures shown on the plans and drawings submitted with the application, as required by Ontario Regulation 200/96. Future development outside of an approved building envelope, where a minor variance was obtained, must comply with the provisions of the City's Zoning By-law.

Elevation drawings are provided to reflect the style of roof (i.e. flat, mansard, gable etc.) to which a building height variance has been applied. Where a height variance is approved, building height is applied to the style of roof (as defined in the City's Zoning By-law) shown on the elevation plans submitted with the application.

Architectural design features that are not regulated by the City's Zoning By-law are not to be considered part of an approval unless specified in the Committee's decision.

DEVELOPMENT CHARGES: That the payment of the Regional Development Charge, if required, is payable to the City of Vaughan before issuance of a building permit in accordance with the Development Charges Act and the Regional Development Charges By-law in effect at the time of payment.

That the payment of the City Development Charge, if required, is payable to the City of Vaughan before issuance of a building permit in accordance with the Development Charges Act and the City's Development Charges By-law in effect at the time of payment.

That the payment of the Education Development Charge if required, is payable to the City of Vaughan before issuance of a building permit in accordance with the Development Charges Act and the Boards of Education By-laws in effect at the time of payment

That the payment of Special Area Development charge, if required, is payable to the City of Vaughan before issuance of a building permit in accordance with the Development Charges Act and The City's Development Charge By-law in effect at the time of Building permit issuance to the satisfaction of the Reserves/Capital Department.

NOTICE OF DECISION: If you wish to be notified of the decision in respect to this application or a related Ontario Land Tribunal (OLT) hearing you must complete a Request for Decision form and submit to the Secretary Treasurer (ask staff for details). In the absence of a written request to be notified of the Committee's decision you will **not** receive notice.

SCHEDULE A: DRAWINGS & PLANS






Disclaimer:



Scale: 1:3,040 0.05 km

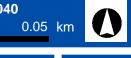


Created By: Infrastructure Delivery Department December 12, 2022 12:44 PM


NAD 83 UTM Zone DUFFERIN

TREET



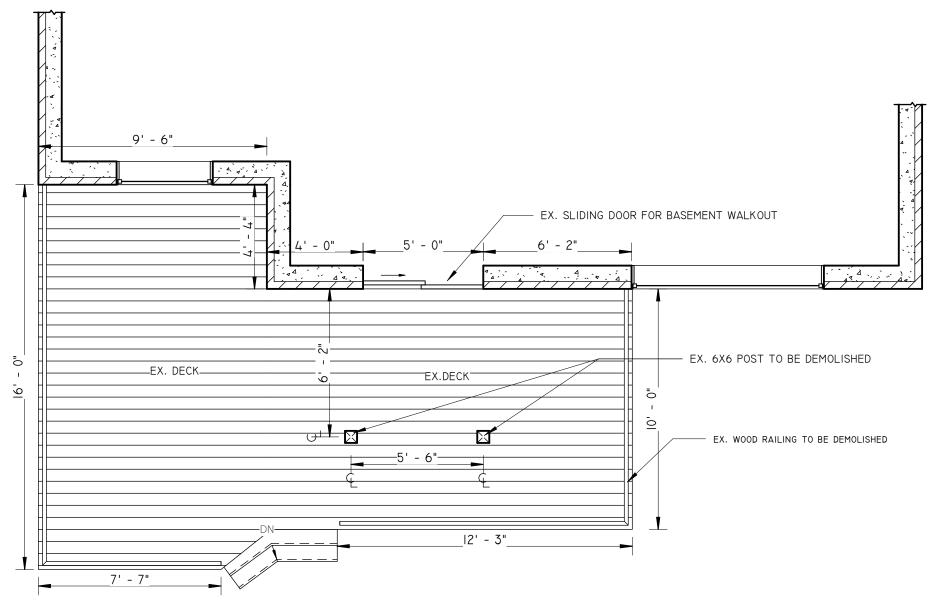



1 BASEMENT FLOOR GROUND DECK (EXISTING) 1/4" = 1'-0"

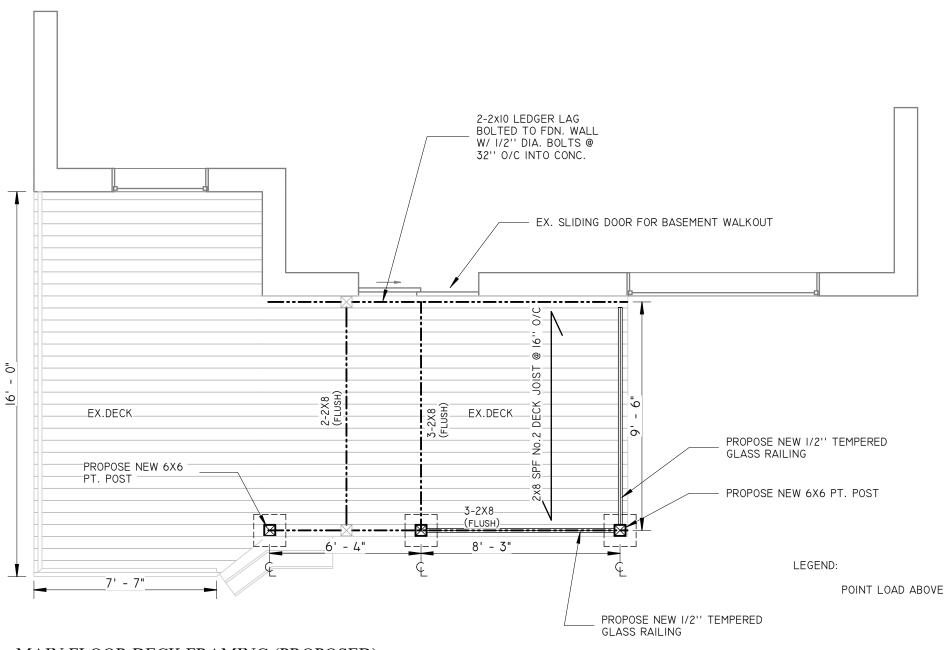

2 MAIN FLOOR DECK FRAMING (PROPOSED) 1/4" = 1'-0"

		No.	Description	Date	PROJECT TITLE	Date	Drawn By
LHW ENGINEERING LTD.					THOSE OF THEE	05/16/2022	AY
Unit 405, 2247 Kannady Pd		2	REVISION ISSUED	2022/05/16	67 Oberfrick Ave, Maple, ON L6A	Scale	Checked By
Unit 405, 2347 Kennedy Rd Toronto, ON M1T 3T8	2	2	REVISION ISSUED	2022/03/10	4T4	1/4" = 1'-0"	BW
T: 416-299-8837 LHW.ENGINEERING@GMAIL.COM					DRAWING TITLE BASEMENT DECK PLAN	Proj. No. 190715	DWG. No. A1.1

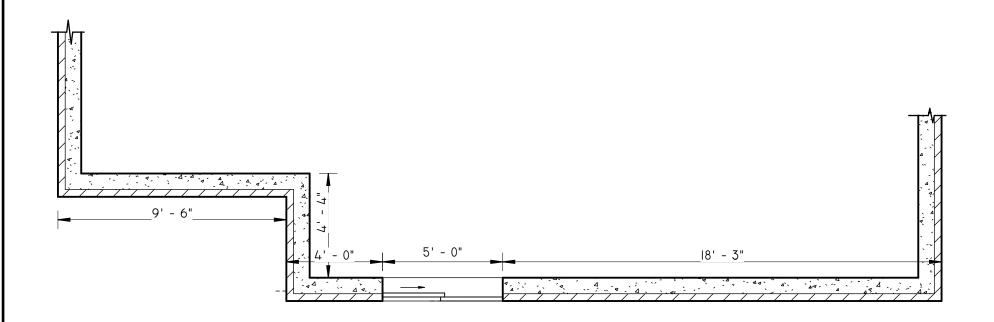


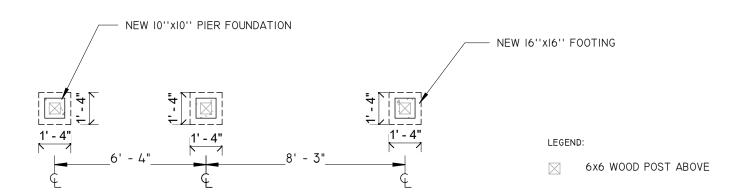


1) FOUNDATION PLAN (PROPOSED) 1/4" = 1'-0"

LHW ENGINEERING	LTD.
Unit 405, 2347 Kennedy Rd Toronto, ON M1T 3T8 T: 416-299-8837 LHW.ENGINEERING@GMAII	COM

No.	Description	Date	PROJECT TITLE	Date	Drawn By	
				05/16/2022	AY	
2	REVISION ISSUED	2022/05/16	67 Oberfrick Ave, Maple, ON L6A 4T4 Scale 1/4" = 1'		Checked By BW	
			DRAWING TITLE PROPOSED FOUNDATION PLAN	Proj. No. 190715	DWG. No. A1.2	

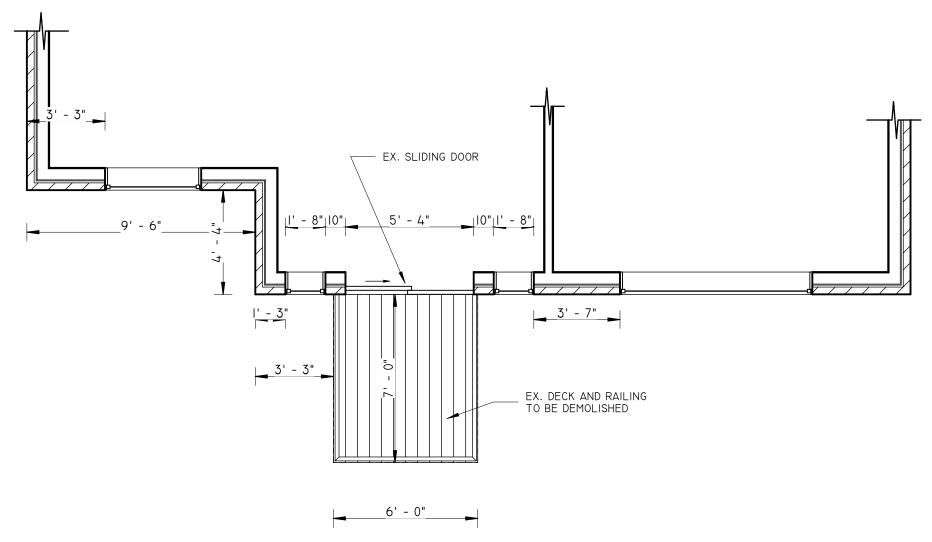


$1 \frac{\text{MAIN FLOOR (EXISTING/DEMOLISHED)}}{1/4" = 1'-0"}$

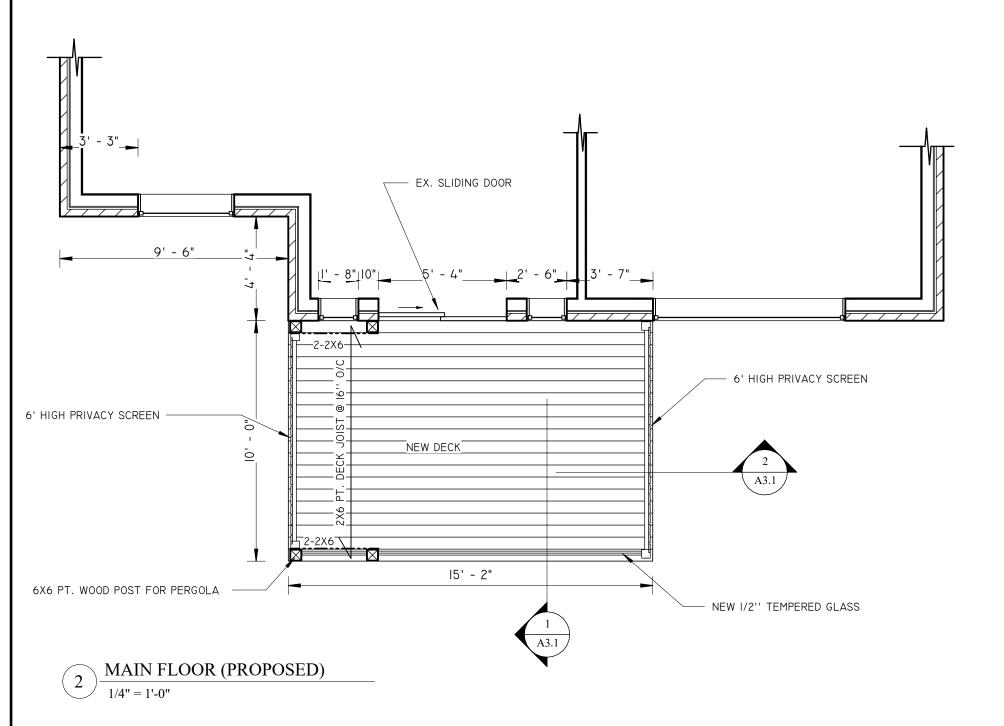


LHW ENGINEERING L	.TD.
Unit 405, 2347 Kennedy Rd Toronto, ON M1T 3T8 T: 416-299-8837 LHW.ENGINEERING@GMAIL	COM

No.	Description	Date	PROJECT TITLE	Date	Drawn By
			110020111122	05/16/2022	AY
2	REVISION ISSUED	2022/05/16	67 Oberfrick Ave, Maple, ON L6A 4T4 Scale 1/4" = 1'-0		Checked By BW
			DRAWING TITLE MAIN FLOOR PLAN	Proj. No. 190715	DWG. No. A1.3

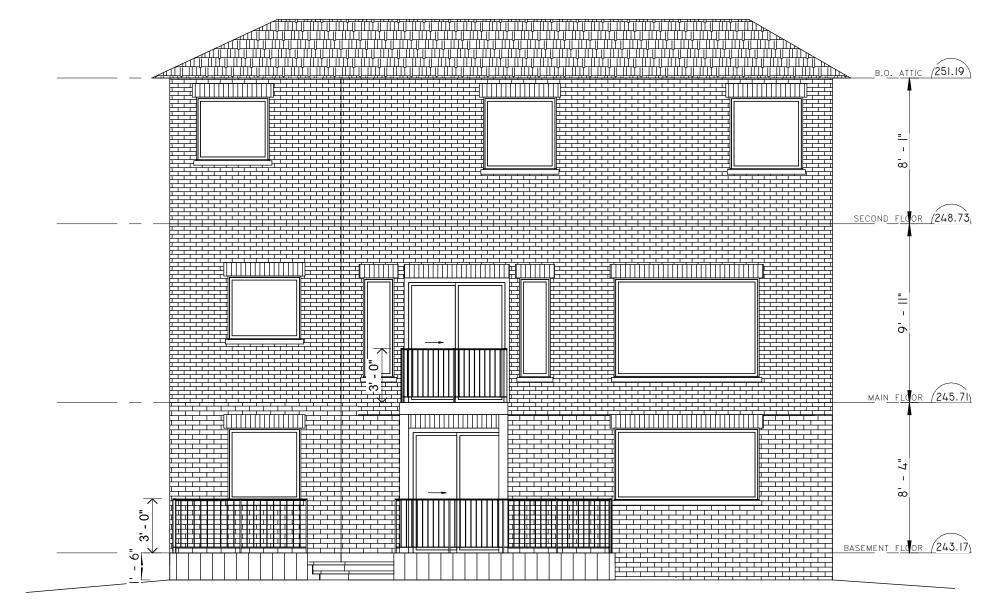


 $\frac{\text{REAR ELEVATION (EXISTING)}}{3/16" = 1'-0"}$

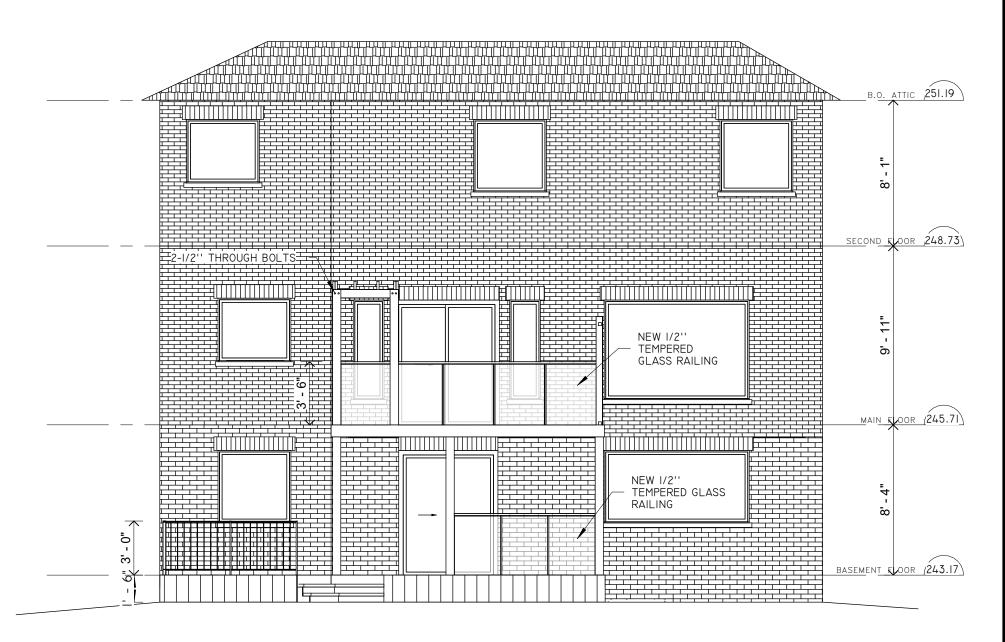


 $2 \frac{\text{REAR ELEVATION (PROPOSED)}}{3/16" = 1'-0"}$

	No.	Description	Date	PROJECT TITLE	Date	Drawn By
LHW ENGINEERING LTD.				1116020111122	05/16/2022	AY
Unit 405, 2347 Kennedy Rd	2	REVISION ISSUED	2022/05/16	67 Oberfrick Ave, Maple, ON L6A 4T4	Scale	Checked By
Toronto, ON M1T 3T8					3/16" = 1'-0"	BW
T: 416-299-8837 LHW.ENGINEERING@GMAIL.COM				DRAWING TITLE REAR ELEVATION	Proj. No. 190715	DWG. No. A2.1

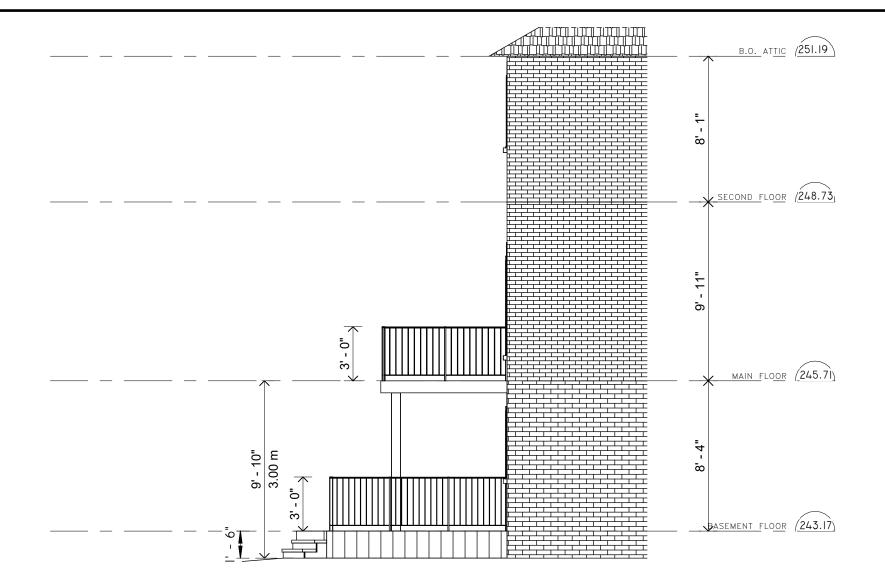


$1 \overline{\frac{\text{RIGHT ELEVATION (EXISTING)}}{3/16" = 1'-0"}}$

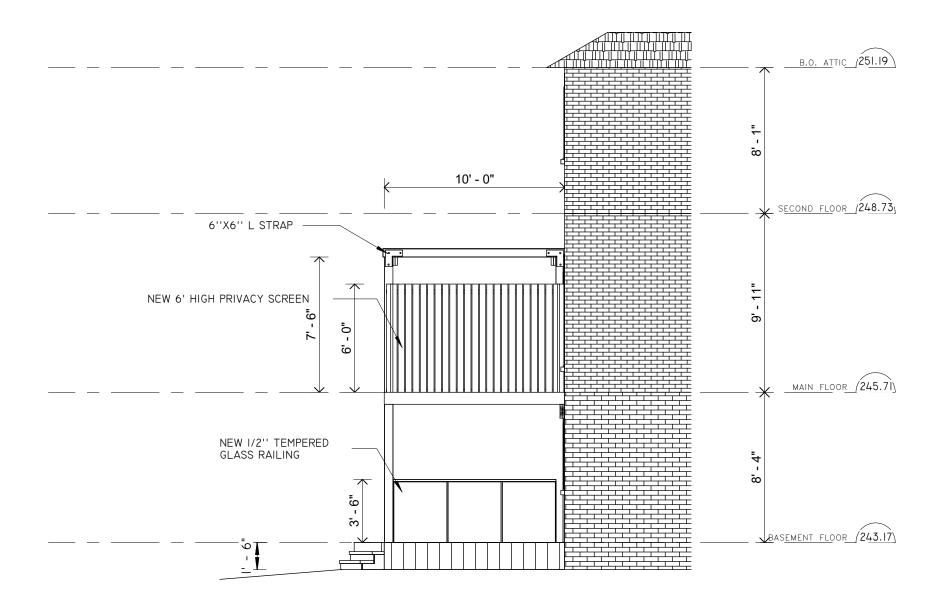


$2 \frac{\text{RIGHT ELEVATION (PROPOSED)}}{3/16" = 1'-0"}$

	NO.	Description	Date	PROJECT TITLE	Date	Drawn By
LHW ENGINEERING LTD.					05/16/2022	AY
Unit 405, 2347 Kennedy Rd Toronto, ON M1T 3T8 T: 416-299-8837 LHW.ENGINEERING@GMAIL.COM	2	REVISION ISSUED	2022/05/16	67 Oberfrick Ave, Maple, ON L6A 4T4	Scale	Checked By
				717	3/16" = 1'-0"	Checker
				DRAWING TITLE RIGHT ELEVATION	Proj. No.	DWG. No. A2.2
					190715	AZ.Z

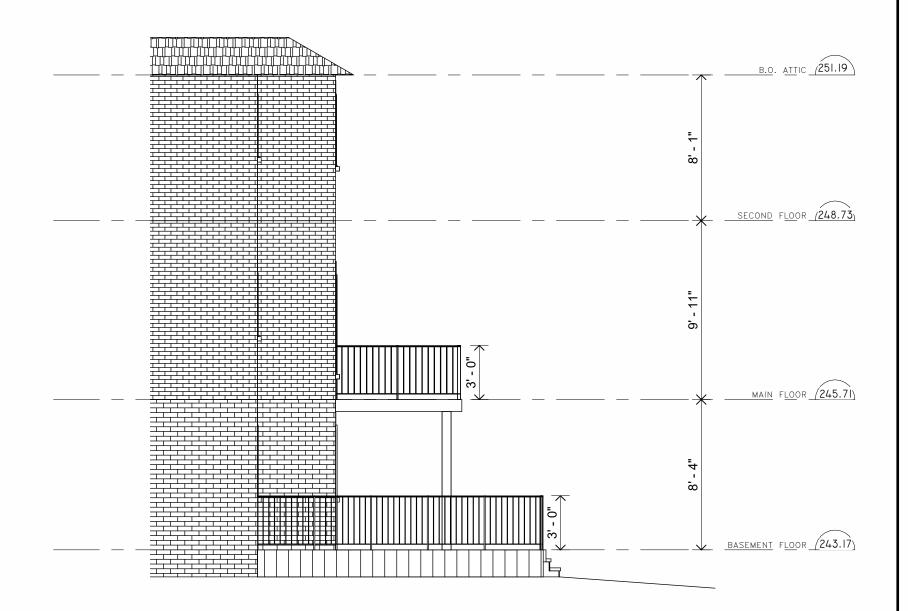




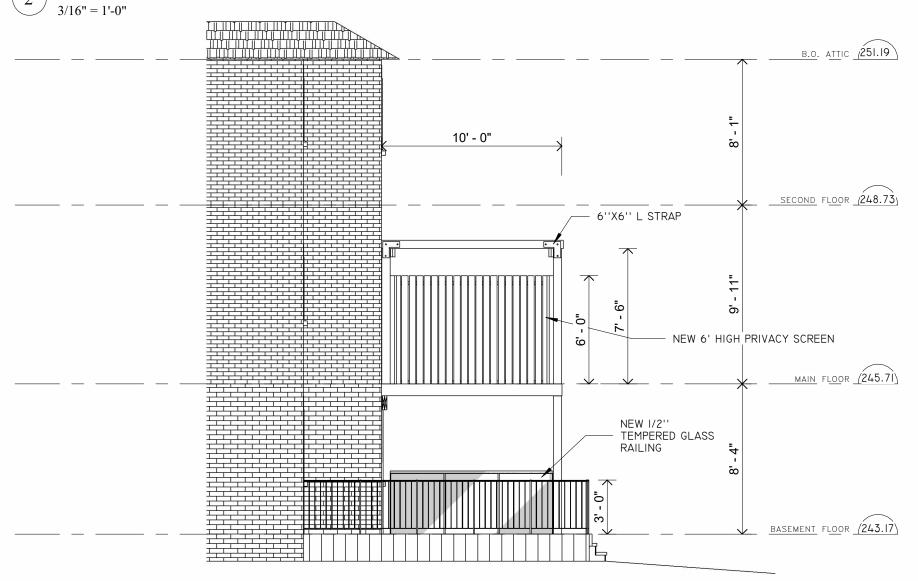


$1 \frac{\text{LEFT ELEVATION (PROPOSED)}}{3/16" = 1'-0"}$

	NO.	Description	Date	PROJECT TITLE	Date	Drawn By
LHW ENGINEERING LTD.				THOUSEN THEE	05/16/2022	AY
\wedge				67 Oberfrick Ave, Maple, ON L6A	Scale	Checked By
Unit 405, 2347 Kennedy Rd	2	REVISION ISSUED	2022/05/16	4T4		
Toronto, ON M1T 3T8 T: 416-299-8837					3/16" = 1'-0"	D W
LHW.ENGINEERING@GMAIL.COM				DRAWING TITLE LEFT ELEVATION	Proj. No.	DWG. No.
				LEFT ELEVATION	190715	A2.4

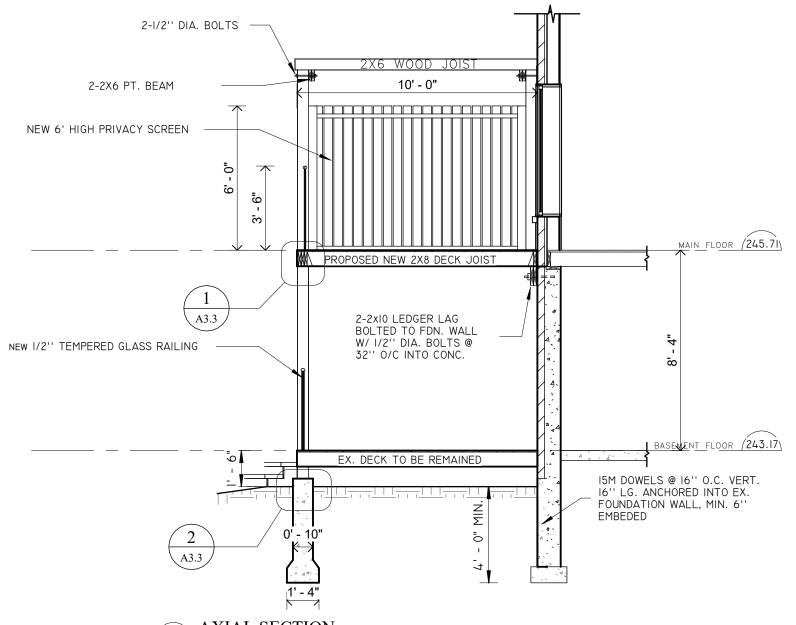


 $1 \frac{AXIAL SECTION}{1/4" = 1'-0"}$

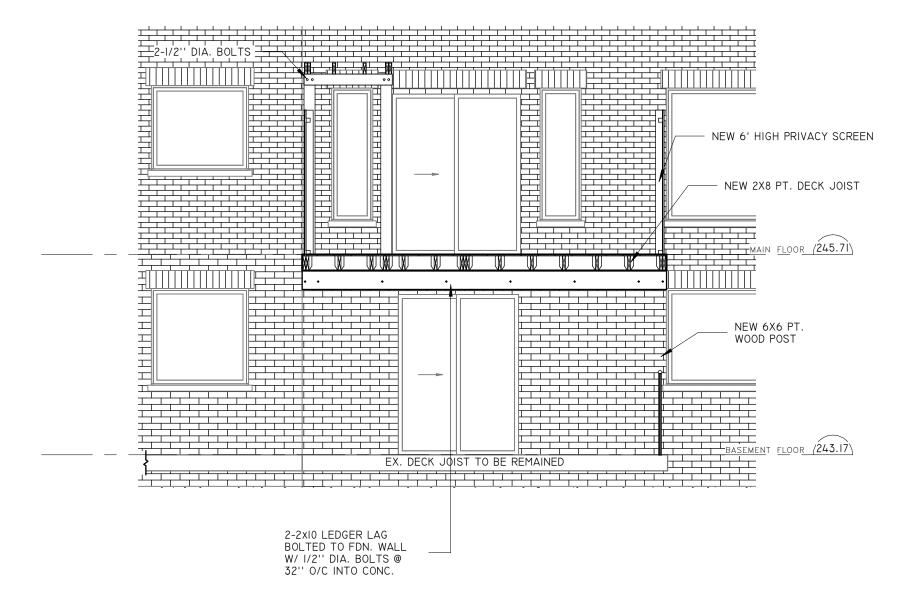


 $2 \frac{\text{CROSS SECTION}}{1/4" = 1'-0"}$

LHW ENGINEERING LTD.	-		
Unit 405, 2347 Kennedy Rd Toronto, ON M1T 3T8 T: 416-299-8837 LHW.ENGINEERING@GMAIL.COM		2	REVIS

No.	Description	Date	PROJECT TITLE	Date	Drawn By
				05/16/2022	AY
2	REVISION ISSUED	2022/05/16	67 Oberfrick Ave, Maple, ON L6A 4T4	Scale 1/4" = 1'-0"	Checked By BW
			DRAWING TITLE SECTION VIEW	Proj. No. 190715	DWG. No. A3.1

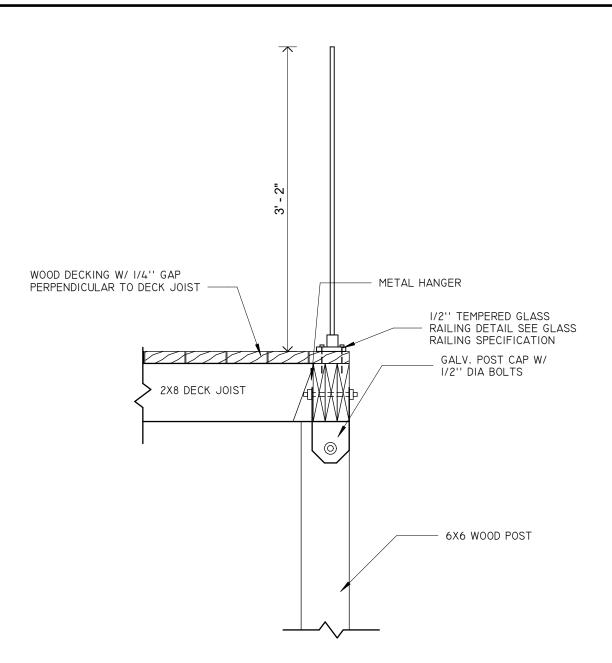


1 TYP. WOOD POST AND BEAM CONNECTION

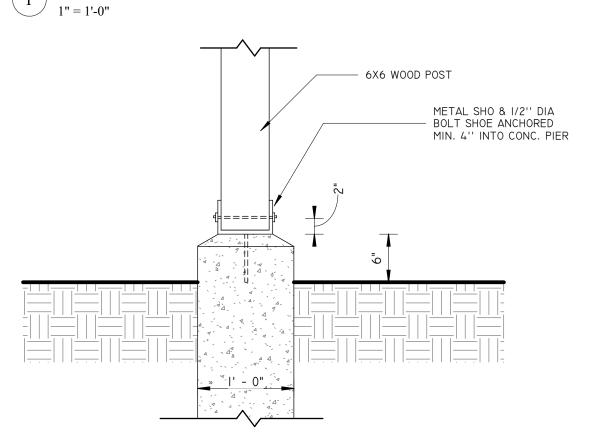

2 TYP. WOOD POST AND PIER CONNECTION 1" = 1'-0"

LHW ENGINEERING	LTD.
Unit 405, 2347 Kennedy Rd Toronto, ON M1T 3T8 T: 416-299-8837 LHW.ENGINEERING@GMAII	L.COM

No.	Description	Date	PROJECT TITLE	Date	Drawn By
				05/16/2022	AY
2	REVISION ISSUED	2022/05/16	67 Oberfrick Ave, Maple, ON L6A 4T4	Scale 1" = 1'-0"	Checked By BW
			DRAWING TITLE DETAILS	Proj. No. 190715	DWG. No. A3.3

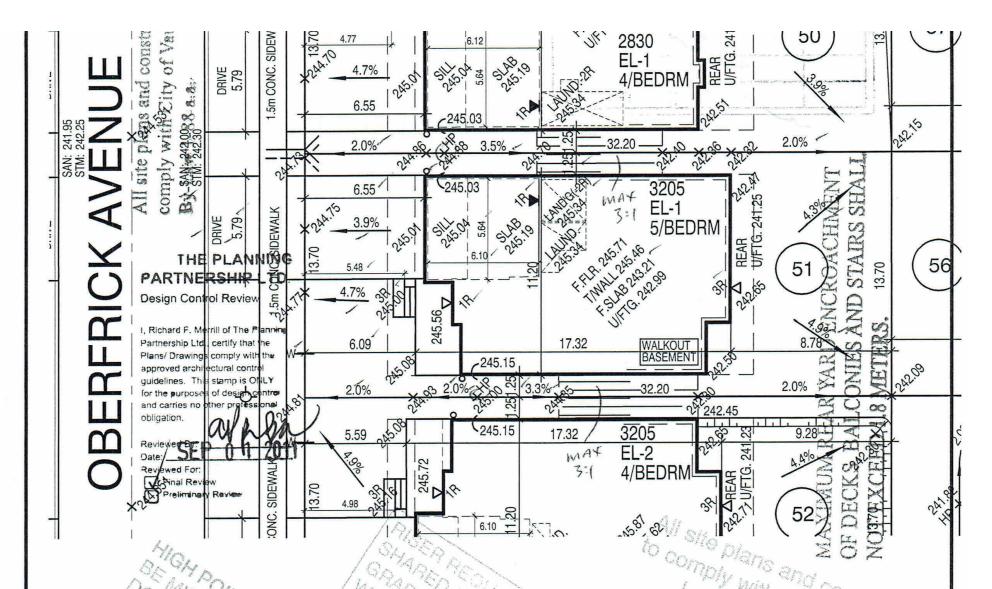

GRADING AND DRAINAGE NOTES:

- 1) STANDARD DRAWINGS AND LOT GRADING CRITERIA
 OF THE CITY OF VAUGHAN AND THE REGIONAL
 MUNICIPALITY OF YORK CONSTITUTE PART OF THE
 PROJECT DRAWINGS FOR THE SUBDIVISION.
- 2) MINIMUM GRADIENT OF GRASS SWALES ALONG THE SIDE AND REAR LOT LINES SHALL BE 2.0%. THE PROPOSED ELEVATION OF THE SIDE YARD SWALE SHALL BE A MINIMUM OF 0.15m BELOW THE FINISHED GRADE AT THE BUILDING LINE. THE MAXIMUM SWALE GRADIENT SHALL BE 5.0%.
- 3) A MINIMUM HORIZONTAL DISTANCE OF 0.60m ALONG THE EXTERNAL LIMITS OF THE PROPOSED SUBDIVISION SHALL REMAIN UNDISTURBED.
- 4) FILL MATERIAL SHALL BE COMPACTED TO A DRY DENSITY NOT LESS THAN 98% OF THE MAXIMUM DRY DENSITY AS DETERMINED BY THE STANDARD DENSITY TEST. A.S.H.O. DESIGNATION T-99. AFTER COMPACTION, SOIL DENSITY TESTS SHALL BE CONDUCTED TO ENSURE ADEQUATE COMPACTION AND STABILITY OF THE FILL AND TEST REPORTS SHALL BE SUBMITTED TO THE DIRECTOR OF ENGINEERING.
- ROOF LEADERS SHALL NOT BE CONNECTED TO THE STORM SEWER BUT SHALL DISCHARGE TO THE GROUND ONTO A SPLASH PAD AND SHALL DRAIN TO FRONT OF HOUSE. ROOF DOWN SPOUTS ARE NOT PERMITTED AT THE REAR OF THE HOUSE, EAVES AND DOWN SPOUTS TO BE SIZED ACCORDINGLY.
- FOOTING CONSTRUCTED NEXT TO A CATCH BASIN LEAD PIPE OR OTHER MUNICIPAL SERVICE SHALL BE INSTALLED BELOW LEAD PIPE EXCAVATION. FOOTING MUST BE CONSTRUCTED ON UNDISTURBED SOIL. SOIL CONSULTANTS VERIFICATION REQUIRED.
- ALL FENCES REQUIRED ABUTTING PUBLIC LANDS
 AND/OR EXISTING PROPERTIES SHALL BE
 CONSTRUCTED WITH MATERIAL (INCLUDING
 FOUNDATIONS) COMPLETELY ON PRIVATE LANDS AND
 TOTALLY CLEAR OF 0.30 RESERVE.
- 8) IN LOTS WITH REAR-LOT CATCH BASINS. THE MINIMUM SIDE YARD WIDTH SHALL BE 1.2m ALONG CATCH BASIN LEAD
- 9) REFER TO DETAIL ON THIS DRAWING FOR "BACK TO FRONT" DRAINAGE LOT.
- 10) ALL BOULEVARDS TO BE SODDED ON TOP OF 450mm THICK LAYER OF TOP SOIL.

SCHAEFFER & ASSOCIATES LIMITED APPROVED FOR GRADING

- THE PROPOSED LOT GRADING AND DRAINAGE IS APPROVED AS BEING IN CONFORMITY WITH THE OVERALL APPROVED GRADING PLANS FOR THE SUBDIVISION.
-). THE BUILDER IS RESPONSIBLE FOR RELOCATION OF SALL THE UTILITIES ON SITE.
- THE BUILDER MUST TOPSOIL AND SOD ALL BOULEVARDS.
- 4) DOWNSPOUTS SHALL DISCHARGE TO THE GROUND SURFACE VIA SPLASH PADS.
- 5) BRICKLINE TO BE 150mm TO 200mm ABOVE FINAL

GRADE AT HOUSE

DATE

A CONELY

A SPER ENGINE

2 AUG. 30 2011

REV. AS PER ENGINE

2 AUG. 30 2011 REV. AS PER ENGINEER'S COMMENTS & ISSUED FOR PERMIT

JULY 26, 2011 ISSUED FOR ENGINEER'S REVIEW

REVISIONS:

H & R DEV. (THORNBERRY WOODS PH.3) (ARBAND INVESTMENTS PHASE-3)

PROJ. No. 10-43 DATE: SCALE: 1:250

LOT No. 51 MUNICIPAL ADDRESS

REG. PLAN 65M- CITY OF VAUGHAN



The undersigned has reviewed and takes responsibility for this design and has the qualifications and meets the requirements set out in the Ontario Building Code to be a designer

QUALIFICATION INFORMATION

Required unless design is example under Division Q Subsection

3.2.5 of the building code.

NAME SIGNATURE BCIN

REGISTRATION INFORMATION

Required unless design is exempt under Division C, Subsection

3.2.4 of the building code

Walter Botte

jardin design group inc. 27763
FIRM NAME BCIN

Jardin DESIGN GROUP INC.

64 JARDIN DR. SUITE 3A VAUGHAN ONT. L4K 3P3 TEL: 905 660-3377 FAX: 905 660-3713 EMAIL: info@jardindesign.ca

LHW ENGINEERING LTD.

Unit 405, 2347 Kennedy Rd Toronto, ON M1T 3T8 T: 416-299-8837 LHW.ENGINEERING@GMAIL.COM

No.	Description	Date	PROJECT TITLE	Date	Drawn By
				05/16/2022	AY
2	REVISION ISSUED	2022/05/16	67 Oberfrick Ave, Maple, ON L6A 4T4	Scale	Checked By Checker
			DRAWING TITLE SURVEY	Proj. No. 190715	DWG. No. A4.0

SCHEDULE B: STAFF & AGENCY COMMENTS						
DEPT/AGENCY	Circulated	Comments Received	Conditions	Nature of Comments		
TRCA *Schedule B	Х			No Comments Received to Date		
Ministry of Transportation (MTO) *Schedule B				No Comments Received to Date		
Region of York *Schedule B	Х	X		General Comments		
Alectra *Schedule B	X	X		General Comments		
Bell Canada *Schedule B	Х			No Comments Received to Date		
YRDSB *Schedule B						
YCDSB *Schedule B						
CN Rail *Schedule B						
CP Rail *Schedule B						
TransCanada Pipeline *Schedule B	Х			No Comments Received to Date		
Metrolinx *Schedule B						
Propane Operator *Schedule B						
Development Planning	Х	Х		Recommend Approval/no conditions		
Building Standards (Zoning)	Х	Х		General Comments		



Date: December 13th 2022

Attention: Christine Vigneault

RE: Request for Comments

File No.: A313-22

Related Files:

Applicant Xuda Zhang

Location 67 Oberfrick Avenue



COMMENTS:

	We have reviewed the proposed Variance Application and have no comments or objections to its approval.
X	We have reviewed the proposed Variance Application and have no objections to its approval, subject to the following comments (attached below).
	We have reviewed the proposed Variance Application and have the following concerns (attached below).

Alectra Utilities (formerly PowerStream) has received and reviewed the proposed Variance Application. This review, however, does not imply any approval of the project or plan.

All proposed billboards, signs, and other structures associated with the project or plan must maintain minimum clearances to the existing overhead or underground electrical distribution system as specified by the applicable standards, codes and acts referenced.

In the event that construction commences, and the clearance between any component of the work/structure and the adjacent existing overhead and underground electrical distribution system violates the Occupational Health and Safety Act, the customer will be responsible for 100% of the costs associated with Alectra making the work area safe. All construction work will be required to stop until the safe limits of approach can be established.

In the event construction is completed, and the clearance between the constructed structure and the adjacent existing overhead and underground electrical distribution system violates the any of applicable standards, acts or codes referenced, the customer will be responsible for 100% of Alectra's cost for any relocation work.

References:

- Ontario Electrical Safety Code, latest edition (Clearance of Conductors from Buildings)
- Ontario Health and Safety Act, latest edition (Construction Protection)
- Ontario Building Code, latest edition (Clearance to Buildings)
- PowerStream (Construction Standard 03-1, 03-4), attached
- Canadian Standards Association, latest edition (Basic Clearances)

If more information is required, please contact either of the following:

Mr. Stephen Cranley, C.E.T

Supervisor, Distribution Design, ICI & Layouts (North)

Phone: 1-877-963-6900 ext. 31297

E-mail: stephen.cranley@alectrautilities.com

Mitchell Penner

Supervisor, Distribution Design-Subdivisions

Phone: 416-302-6215

Email: Mitchell.Penner@alectrautilities.com




Power Stream 1

Construction Standard

03-1

		SYSTEM	VOLTAGE	
LOCATION OF WIRES, CABLES OR CONDUCTORS	SPAN GUYS AND COMMUNICATIONS WIRES		4.16/2.4kV TO 27.6/16kV (SEE NOTE 1)	44kV
	MINIMUM	VERTICAL CLEA	ARANCES (SEE	NOTE 2)
OVER OR ALONGSIDE ROADS, DRIVEWAYS OR LANDS ACCESSIBLE TO <u>VEHICLES</u>	442cm	442cm	480cm	520cm
OVER GROUND ACCESSIBLE TO PEDESTRIANS AND BICYCLES ONLY	250cm	310cm	340cm	370cm
ABOVE TOP OF RAIL AT RAILWAY CROSSINGS	730cm	730cm	760cm	810cm

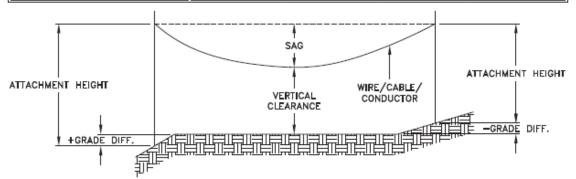

MINIMUM ATTACHMENT HEIGHT = MAXIMUM SAG

- + MINIMUM VERTICAL CLEARANCE (FROM ABOVE TABLE)
 ± GRADE DIFFERENCE

- + 0.3m (VEHICLE OR RAILWAY LOCATION) + SNOW DEPTH (PEDESTRIAN LOCATION, SEE NOTE 3)

NOTES:

- THE MULTIGROUNDED SYSTEM NEUTRAL HAS THE SAME CLEARANCE AS THE 600V SYSTEM.
- 2. THE VERTICAL CLEARANCES IN THE ABOVE TABLE ARE UNDER $\underline{\text{MAXIMUM SAG}}$ CONDITIONS.
- 3. REFER TO CSA STANDARD C22.3 No.1, ANNEX D FOR LOCAL SNOW DEPTH
- 4. ALL CLEARANCES ARE IN ACCORDANCE TO CSA STANDARD C22.3.

<u>\G</u>	340cm	11'-4"				
	310cm	10'-4"				
VALUES.	250cm	8'-4"				
VALUES.						
REFERENCES						
SAGS AND	FNSIONS 1	SECTION 02				

METRIC

810cm

760cm 730cm

520cm 480cm

442cm 370cm

CONVERSION TABLE

IMPERIAL (APPROX)

27'-0" 25'-4"

24'-4" 17'-4"

15'-5" 12'-4"

MINIMUM VERTICAL CLEARANCES OF WIRES, CABLES AND CONDUCTORS ABOVE GROUND OR RAILS


ORIGINAL ISSUE DATE: 2010-DEC-24 REVISION NO: R1 REVISION DATE: 2012-JAN-09


Certificate of Approval This construction Standard meets the safety requirements of Section 4 of Regulation 22/04			
Joe Crozier, P.Eng. Name	2012-JAN-09 Date		
P Fng. Annroyal By-	Ine Crozier		



Construction Standard

03 - 4

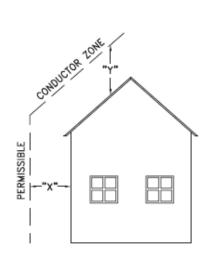

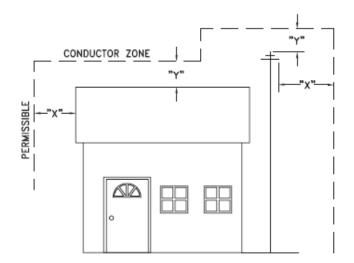

VOLTAGE	MINIMUM HORIZONTAL CLEARNACE UNDER MAXIMUM SWING CONDITIONS DIMENSION "X" (SEE NOTES 1, 3 & 4)	MINIMUM VERTICAL CLEARANCE UNDER MAXIMUM DESIGN SAG CONDITIONS DIMENSION "Y" (SEE NOTES 1, 2, 4 & 5)
0-600V AND NEUTRAL	100cm	250cm
4.16/2.4 TO 44kV	300cm	480cm

NOTES

- UNDER NO CIRCUMSTANCES SHALL A CONDUCTOR BE PERMITTED TO PENETRATE THE ENVELOPE SHOWN BY THE DOTTED LINE.
- 2. THE VERTICAL CLEARANCES ARE UNDER CONDITIONS OF MAXIMUM DESIGN SAG.
- THE HORIZONTAL CLEARANCES ARE UNDER CONDITIONS OF MAXIMUM SWING. WHERE THE CONDUCTOR SWING IS NOT KNOWN A HORIZONTAL CLEARANCE OF 480CM SHALL BE USED.
- 4. BUILDINGS THAT EXCEED 3 STOREYS OR 15M IN HEIGHT, THE MINIMUM HORIZONTAL CLEARANCE OF THE SECONDARY CONDUCTORS SHOULD BE INCREASED TO 300cm WHERE IT IS NECESSARY TO ALLOW FOR THE RAISING OF LADDERS BY LOCAL FIRE DEPARTMENTS.
- IN SITUATIONS SUCH AS MULTI-LEVEL GARAGES, WHERE ROOFS ARE NORMALLY USED BY PERSONS AND VEHICLES, THE VERTICAL CLEARANCES OF POWERSTREAM STANDARD 03-1 SHALL APPLY.
- 6. DISTRIBUTION LINES CONSTRUCTED NEAR BUILDINGS SHALL BE BUILT TO AVOID OVERHANG WHEREVER POSSIBLE. WHERE LINES MUST BE CONSTRUCTED OVER OR ADJACENT TO BUILDINGS THE APPLICABLE HORIZONTAL AND VERTICAL CLEARANCES SHALL BE AT CONDITIONS OF MAXIMUM CONDUCTOR SWING AND MAXIMUM SAG. THE ABOVE CLEARANCES ARE DESIGNED TO PREVENT PERSONS ON OR IN BUILDINGS AS WELL AS EXTERNAL MACHINERY USED IN CONJUCTION WITH A BUILDING TO COME IN CONTACT WITH CONDUCTORS. EFFORTS SHOULD BE MADE TO INCREASE THESE CLEARANCES WHERE POSSIBLE.
- 7. ALL CLEARANCES ARE IN ACCORDANCE TO CSA C22.3 NO.1-06 (TABLE-9).

CONVERSION TABLE		
IMPERIAL		
(APPROX)		
16'-0"		
10'-0"		
8'-4"		
3'-4"		

MINIMUM VERTICAL & HORIZONTAL CLEARANCES OF CONDUCTORS FROM BUILDINGS OR OTHER PERMANENT STRUCTURES (CONDUCTORS NOT ATTACHED TO BUILDINGS)

ORIGINAL ISSUE DATE: 2010—MAY—05 REVISION NO: REVISION DATE:
PEgystem Planning and Standards/Standard Design/PowerStream Standards/soundard working (lighter/Seedlan 3/3-4/c/wg d3-4 Ro May 5, 2010, s/wg, 3/3/2010 8/2/202 AM, Adobe POF



To: Committee of Adjustment

From: Bernd Paessler, Building Standards Department

Date: January 5, 2023

Applicant: Xuda Zhang

Location: 67 Oberfrick Avenue PLAN 65M4253 Lot 51

File No.(s): A313/22

Zoning Classification:

The subject lands are zoned R3(EN) – Estate Residential Zone (Established Neighbourhood) and subject to the provisions of Exception 14.877 under Zoning By-law 001-2021, as amended.

#	Zoning By-law 001-2021	Variance requested
1	none	

The subject lands are zoned RD3 –Residential Detached Zone and subject to the provisions of Exception 9(1234) under Zoning By-law 1-88, as amended.

	Zoning By-law 1-88	Variance requested
2	The maximum permitted encroachment for the	To permit an
	basement deck is 1.8m into the required 7.5m	encroachment for the
	rear yard setback.	existing basement deck
		of 2.64m into the
		required 7.5m rear yard
		setback.

Staff Comments:

Stop Work Order(s) and Order(s) to Comply:

Order No. 21-103117, Order to Comply for , Issue Date: Feb 11, 2021

Building Permit(s) Issued:

Building Permit No. 22-102694 for Single Detached Dwelling - Alteration, Issue Date: (Not Yet Issued)

Other Comments:

General Comments			
1	The applicant shall be advised that additional variances may be required upon review of detailed drawing for building permit/site plan approval.		
2	The subject lands may be subject to the Oak Ridges Moraine Conservation Act, RSO 2001.		



Conditions of Approval:

If the committee finds merit in the application, the following conditions of approval are recommended.

* Comments are based on the review of documentation supplied with this application.



To: Christine Vigneault, Committee of Adjustment Secretary Treasurer

From: Nancy Tuckett, Director of Development Planning

Date: January 12, 2023

Name of Owner: Xuda Zhang

Location: 67 Oberfrick Avenue PLAN 65M4253 Lot 51

File No.(s): A313/22

Proposed Variance(s) (By-law 01-2021):

None

By-Law Requirement(s) (By-law 01-2021):

None

Proposed Variance(s) (By-law 1-88):

1) To permit an encroachment for the existing basement deck of 2.64 m into the required 7.5 m rear yard setback.

By-law Requirement(s) (By-law 1-88):

1) The maximum permitted encroachment for the basement deck is 1.8 m into the required 7.5 m rear yard setback. [S. 3.14 c]

Official Plan

Vaughan Official Plan 2010 ('VOP2010'): "Low-Rise Residential" by Schedule 13, "Oak Ridges Moraine Settlement Area" by Schedule 4.

Comments:

The Owner is requesting permission to maintain an existing walk-out basement deck at the rear wall of an existing single-detached dwelling with the above noted variances. There is another deck above a portion of the basement deck which complies with the Zoning By-laws.

The Development Planning Department does not object to the variance. Only the west side of the rear yard deck extends beyond the permitted 1.8 m encroachment and the deck is about 0.46 m in height. The basement deck continues to remain compliant with side yard and height provisions of the By-laws. Development Planning staff acknowledge the proposal is fully compliant with the encroachment requirements in Comprehensive Zoning By-law 001-2021 and will not pose any implications related to massing, use, or drainage impacts onto the abutting properties.

The Development Planning Department is of the opinion that the requested variances are minor in nature, maintain the general intent and purpose of the Official Plan and Zoning By-laws, and are desirable for the appropriate development of the land.

Recommendation:

The Development Planning Department recommends approval of the application.

Conditions of Approval:

If the Committee finds merit in the application, the following conditions of approval are recommended:

None

Comments Prepared by:

Roberto Simbana, Planner I David Harding, Senior Planner From: Rajevan, Niranjan
To: Committee of Adjustment

Subject: [External] FW: A313/22 - REQUEST FOR COMMENTS, CITY OF VAUGHAN

Date: Tuesday, January 3, 2023 3:07:42 PM

Attachments: image002.png image004.png

From: Development Services

Sent: Tuesday, January 3, 2023 2:54 PM

To: Lenore Providence < Lenore. Providence @vaughan.ca>

Subject: RE: A313/22 - REQUEST FOR COMMENTS, CITY OF VAUGHAN

Hi Lenore,

The Regional Municipality of York has completed its review of the above minor variance and has no comment.

Many thanks,

Our working hours may be different. Please do not feel obligated to reply outside of your scheduled working hours. Let's work together to help foster healthy work-life boundaries.

Niranjan Rajevan, M.PI. | Associate Planner, Programs and Process Improvement, Planning and Economic Development, Corporate Services

The Regional Municipality of York | 17250 Yonge Street | Newmarket, ON L3Y 6Z1 1-877-464-9675 ext. 71521 | niranjan.rajevan@york.ca | www.york.ca

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SCHEDULE C: PUBLIC & APPLICANT CORRESPONDENCE

None