

ATTACHMENT 8 9657-9697 KEELE

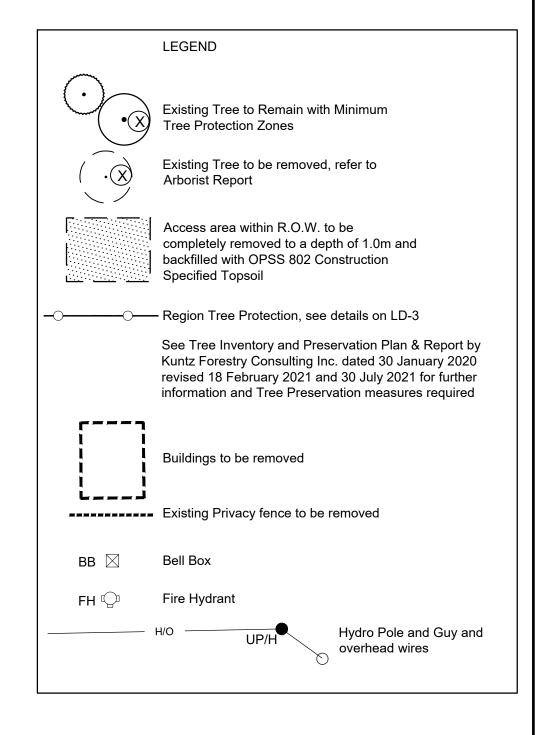

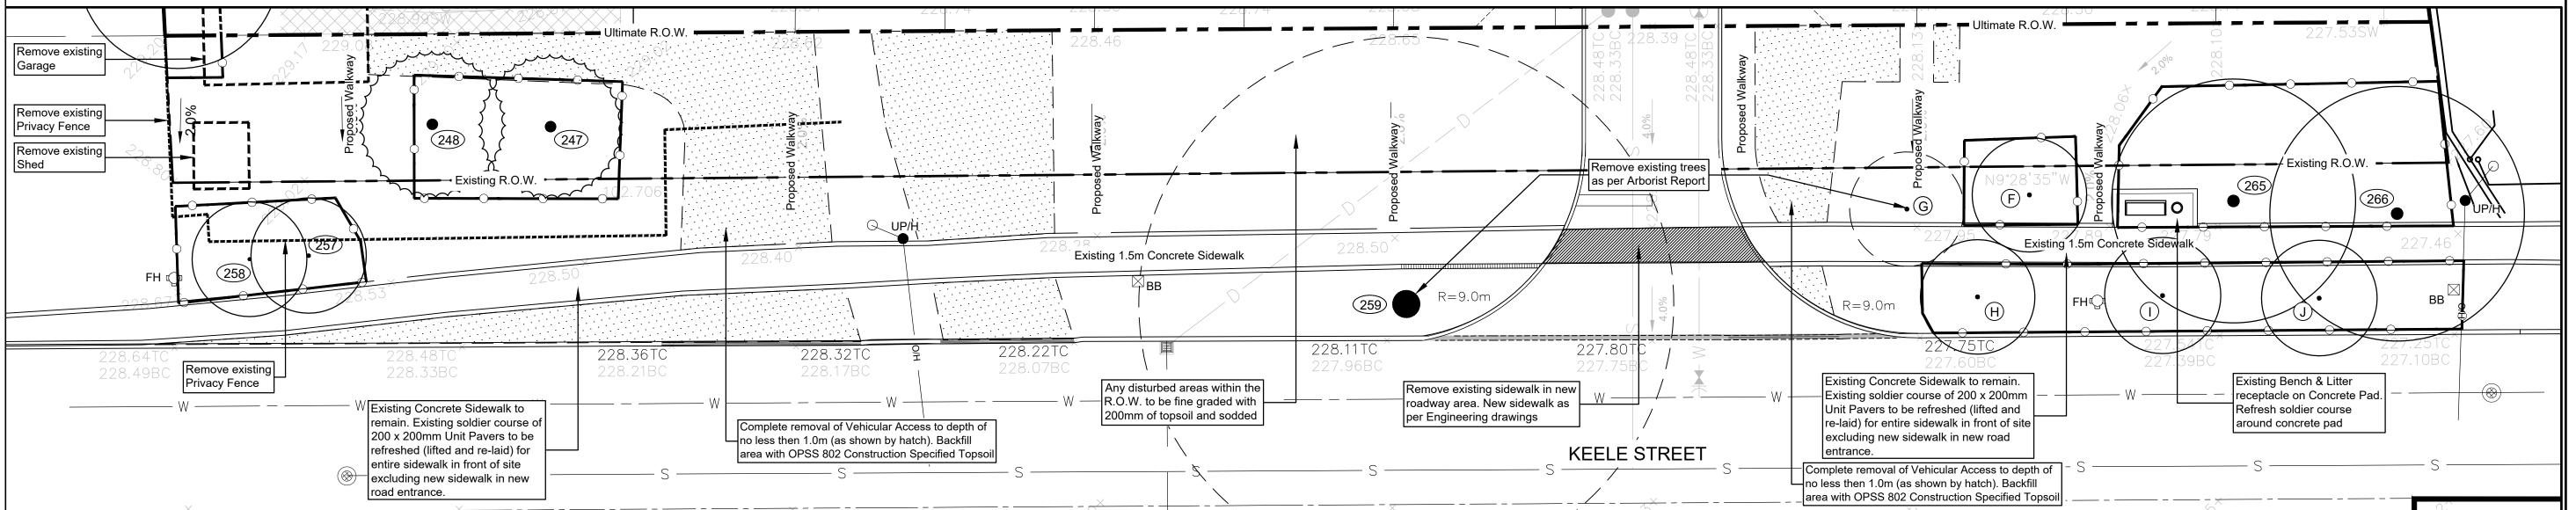

YORK REGION NOTES

Trees planted within the Regional Road Allowance shall conform to the following

- a. All trees shall be planted in accordance with the York Region Street Tree Preservation and Planting Design Guidelines.
- b. York Region NHF shall be provided with two (2) weeks notification, notified to schedule a site meeting to review planting layout as well as notification at the completion of tree planting. York Region NHF may inspect the trees post planting and annually to ensure that the trees are planted and maintained in accordance with Region standards. The developer shall be responsible for correcting all identified deficiencies.
- c. All tree planting shall occur only during the first appropriate planting season immediately following the completion of construction between April 1st and June
- d. Trees shall be subject to a two (2) year warranty period. During that time the developer shall warranty the trees against mortality from any biotic and abiotic
- factor, and/or as a result of incorrect planting or maintenance procedures.
- e. All trees shall be watered a minimum of fourteen (14) times per year throughout the growing season for the duration of the two (2) year warranty period.
- f. At the end of the two (2) year warranty all gator bags and stakes are to be removed and the mulch is to be added in accordance with the specifications.
- Any damage which occurs to the existing asphalt walkway, roadway, curb & gutter due to construction shall be restored to its original or better condition at the Owner's expense.
- Removal all existing pavement and granular base to a depth no less than 1.0 meter as required for areas in the right-of-way where trees are to be planted and which were previously compacted or had hard paved surfacing. Excavated areas are to be backfilled with OPSS 802 construction specified topsoil in order to improve root development and long term survival of newly planted trees. See Removal of Existing
- All disturbed areas within the right-of-way are to be fine graded with 200mm of topsoil and sodded.


YORK REGION TREE PRESERVATION NOTES

All trees located on the Regional road allowance to be preserved shall conform to the following


- The Tree Protection Fencing shall not be moved during construction unless with the
- oversight of a Qualified Arborist. • The entire dripline of the tree located on the grassed boulevard will be mulched with 6cm
- of mulch prior to the commencement of construction.
- A Qualified Arborist must be present for all work within the identified TPZs.
- Root sensitive excavation provisions must be followed when working in the TPZs.
- The Region is to be provided with 24 hours notice prior to working within the TPZs. • Upon completion of the work within the TPZs, a report is to be provided by a Qualified
- Arborist identifying how mitigation measures were achieved for each individual tree and any issues that arose during completion of the work.
- After the completion of construction the mulch is to be topped up to 6cm and the trees are to be thoroughly watered ensuring that top 30cm is saturated.

client

consultants

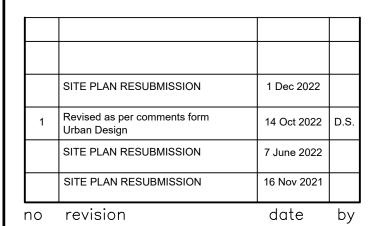

THESE DRAWINGS ARE THE PROPERTY OF MARK SETTER ASSOCIATES LTD AND SHALL NOT BE ALTERED, MODIFIED, REVISED OR CHANGED WITHOUT THE WRITTEN CONSENT OF MARK SETTER ASSOCIATES LTD. ALL DIMENSIONS ARE TO BE VERIFIED ON SITE AND ANY DISCREPANCIES ARE TO BE REPORTED TO THE LANDSCAPE ARCHITECT.

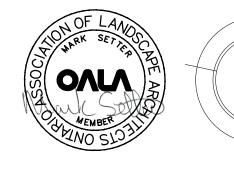



219 Lake Drive East, Keswick, Ontario, L4P 3E9

tel: 905.476.0844 email: msetter@rogers.com website: marksetterassociates.com

reviewed by

drawn by

16 November 2021

scale 1:150

drawing title


Existing Conditions Plan


drawing number EC-1


Residential Development 9675-9697 Keele Street, Vaughan, Ontario


project number 2020-002


City File No. DA.20.044, 19T-20V003, 19CDM-20V007 & Z.20.025 Region File No. SP.20.V.0020

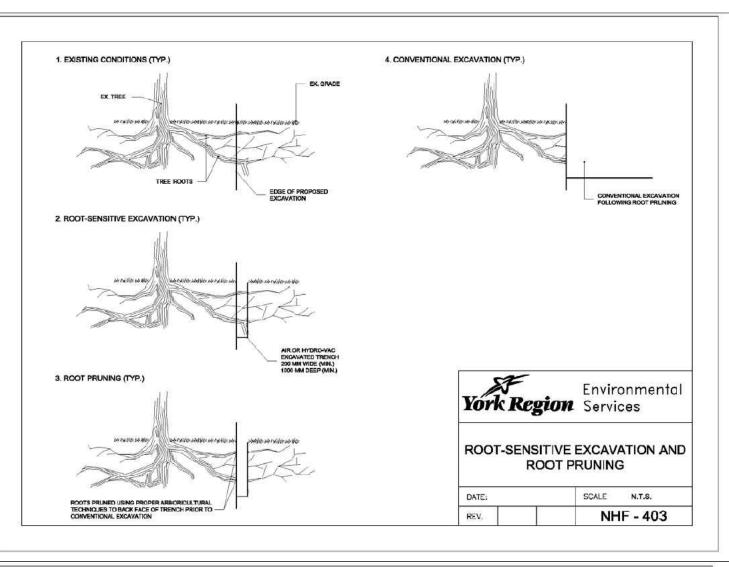


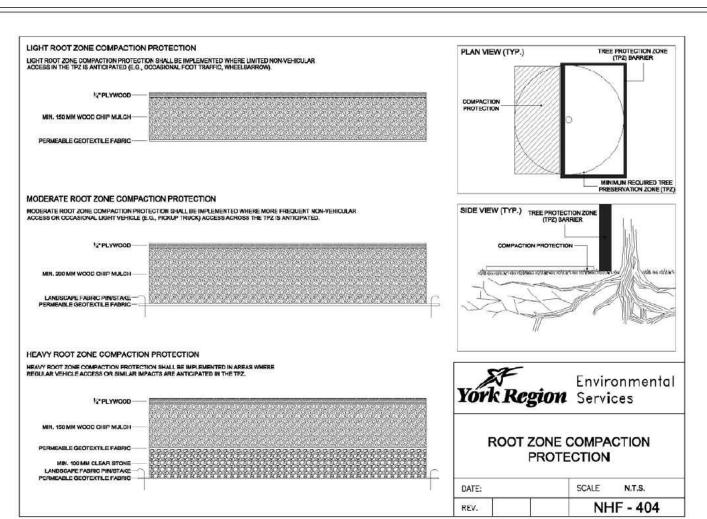

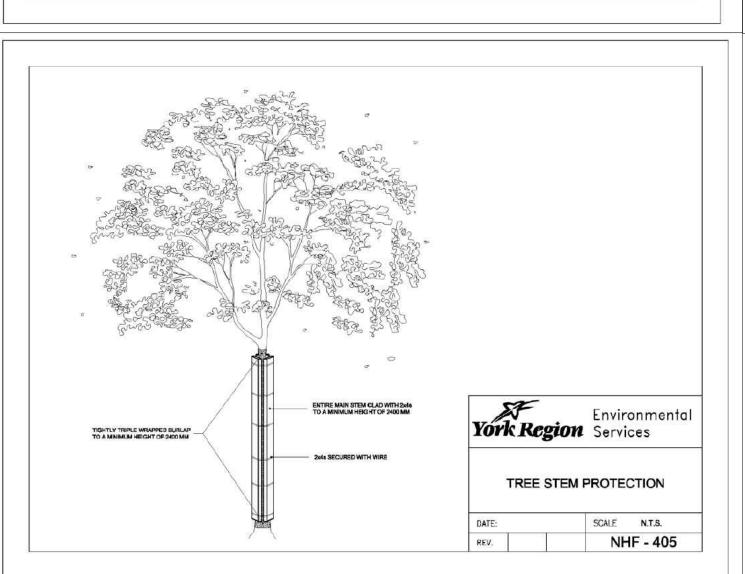


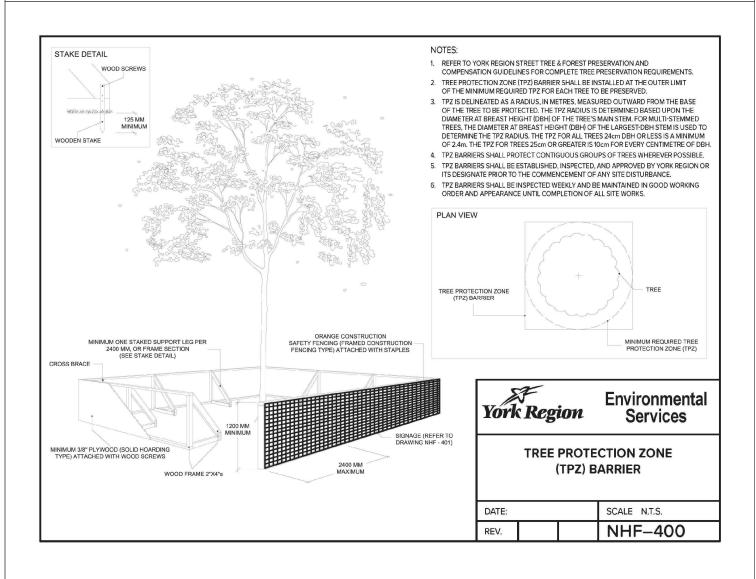

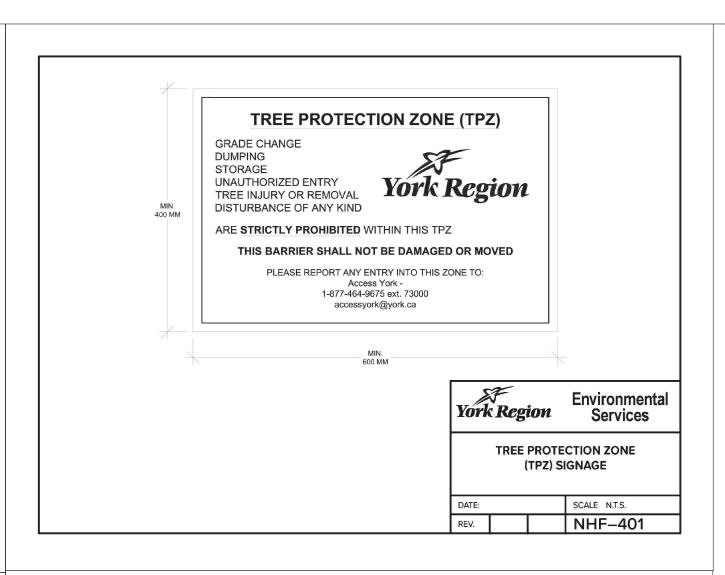

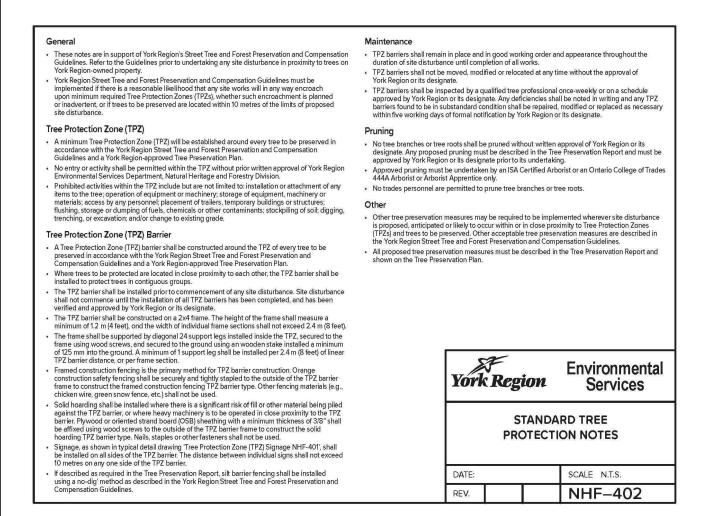

Trees located on the Regional road allowance to be preserved shall conform to the following requirements: All tree preservation shall be in accordance with the York Region Street Tree and Forest Preservation Guidelines. York Region NHF shall be notified when tree protection measures have been installed. All tree protection fencing shall be installed prior to construction and must remain in good repair for the duration of construction At the sole discretion of YR NHF any existing trees that die or exhibit a decline in health prior to final acceptance shall be replaced or compensation shall be provided. The Tree Protection fencing shall not be moved at any time during construction unless with the oversight The entire dripline of the tree located on the grassed boulevard will be mulched with 6cm of mulch prior to the commencement of construction. A Qualified Arborist must be present for all work within the identified TPZs. Root sensitive excavation provisions must be followed when working in the TPZs. The Region is to be provided with 24hrs notice prior to working within the TPZs. Upon the completion of work within the TPZs, a report is to be provided by a Qualified Arborist identifying how mitigation measures were achieved for each individual tree and any issues that arose After the completion of construction the mulch is to be topped up to 6cm and the trees are to be thoroughly watered ensuring that top 30cm is saturated.

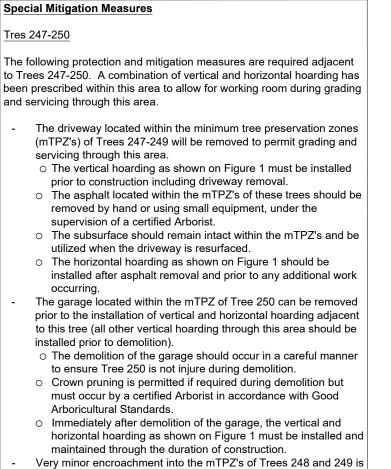


Trees 265 and E

The site plan has been altered to allow for the preservation of Tree 265. Minor encroachment into the mTPZ's of Trees 265 and E will be required to accommodate the walkway and grading, respectively. Excavation at the limit of encroachment should occur by air spading of hydro-vac in accordance with Detail NHF-403. This should be supervised by a certified Arborist, and exposed roots should be pruned in accordance with Good Arboricultural Standards.

Good Arboricultural Standards.

required to accommodate the proposed footpath to the retained dwelling. Excavation at the limit of encroachment should occur by air spading of hydro-vac. This should be supervised by a certified Arborist, and exposed roots should be pruned in accordance with

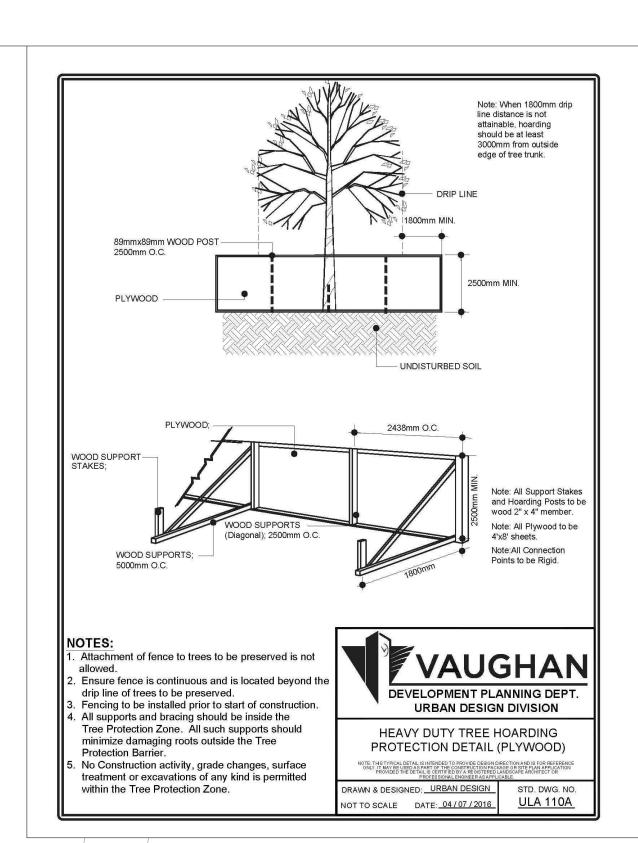

TREE PROTECTION PLAN NOTES

Prior to site disturbance the owner must confirm that no migratory birds are making use of the site for nesting. The owner must ensure that the works are in conformance with the Migratory Bird Convention Act and that no migratory bird nests will be impacted by the proposed work. It is the applicants' responsibility to discuss potential tree injury of trees on shared property lines with their neighbours. Should such trees be injured to the point of instability or death the applicant may be held responsible for removal and such issues would be dealt with in civil court or through negotiation. The applicant would be required to replace such trees to the satisfaction of the City of Vaughan.

TREE PROTECTION ZONE: No construction activity including grade changes, surface treatments or excavations of any kind is permitted within the

TREE PROTECTION ZONE: No construction activity including grade changes, surface treatments or excavations of any kind is permitted within the area identified on the Tree Protection Plan or Site Plan as a Tree Protection Zone (TPZ). No root cutting is permitted. No storage of materials or fill is permitted within the TPZ. No movement or storage of vehicles or equipment is permitted within the TPZ. Grade changes are not permitted within established TPZ. The area(s) identified as a TPZ must remain undisturbed at all times.

TREE PROTECTION BARRIERS:

For City-owned Trees:

Tree protection barriers for trees situated on the City road allowance where visibility must be maintained, can be 1.2m (4ft.) high and consist of chain

link, or orange plastic web snow fencing on a 2" x 4" wood frame. All supports and bracing used to secure the barrier should be located outside the TPZ. All supports and bracing should minimize damage to roots outside the TPZ. Where some fill or excavate has to be temporarily located near a tree protection barrier, plywood must be used to ensure no material enters the TPZ. If the TPZ needs to be reduced to facilitate construction access, the tree protection barrier must be maintained at a lesser distance and the exposed TPZ protected with plywood and wood chips. This must first be approved by the City of Vaughan.

For trees on private property situated on or adjacent to construction sites:

Tree protection barriers must be installed around trees to be protected using plywood clad hoarding or an equivalent approved by the City of

roots outside the TPZ.


General Note:


Prior to the commencement of any site activity the tree protection barriers specified on this plan must be installed and written notice provided to the City of Vaughan. Established tree protection zones must not be used as construction access, storage or staging areas. The tree protection barriers must remain in effective condition until all site activities including landscaping are complete. Written notice must be provided to the City of Vaughan prior to the removal of the tree protection barriers.

ARBORICULTURAL WORK:

Vaughan. All supports and bracing to safely secure the barrier should be outside the TPZ. All such supports and bracing should minimize damage to

Any roots or branches which extend beyond the TPZ indicated on this plan which require pruning, must be pruned by a qualified Arborist or other tree professional as approved by the City of Vaughan. All pruning of tree roots and branches must be in accordance with good arboricultural standards. Roots located outside the TPZ that have received approval from the City of Vaughan to be pruned must first be exposed by hand digging or by using a low pressure hydro vac method. This will allow a proper pruning cut and minimize tearing of the roots. The Arborist/tree professional retained to carry out crown or root pruning must contact the City of Vaughan no less than 48 hours prior to conducting any specified work.

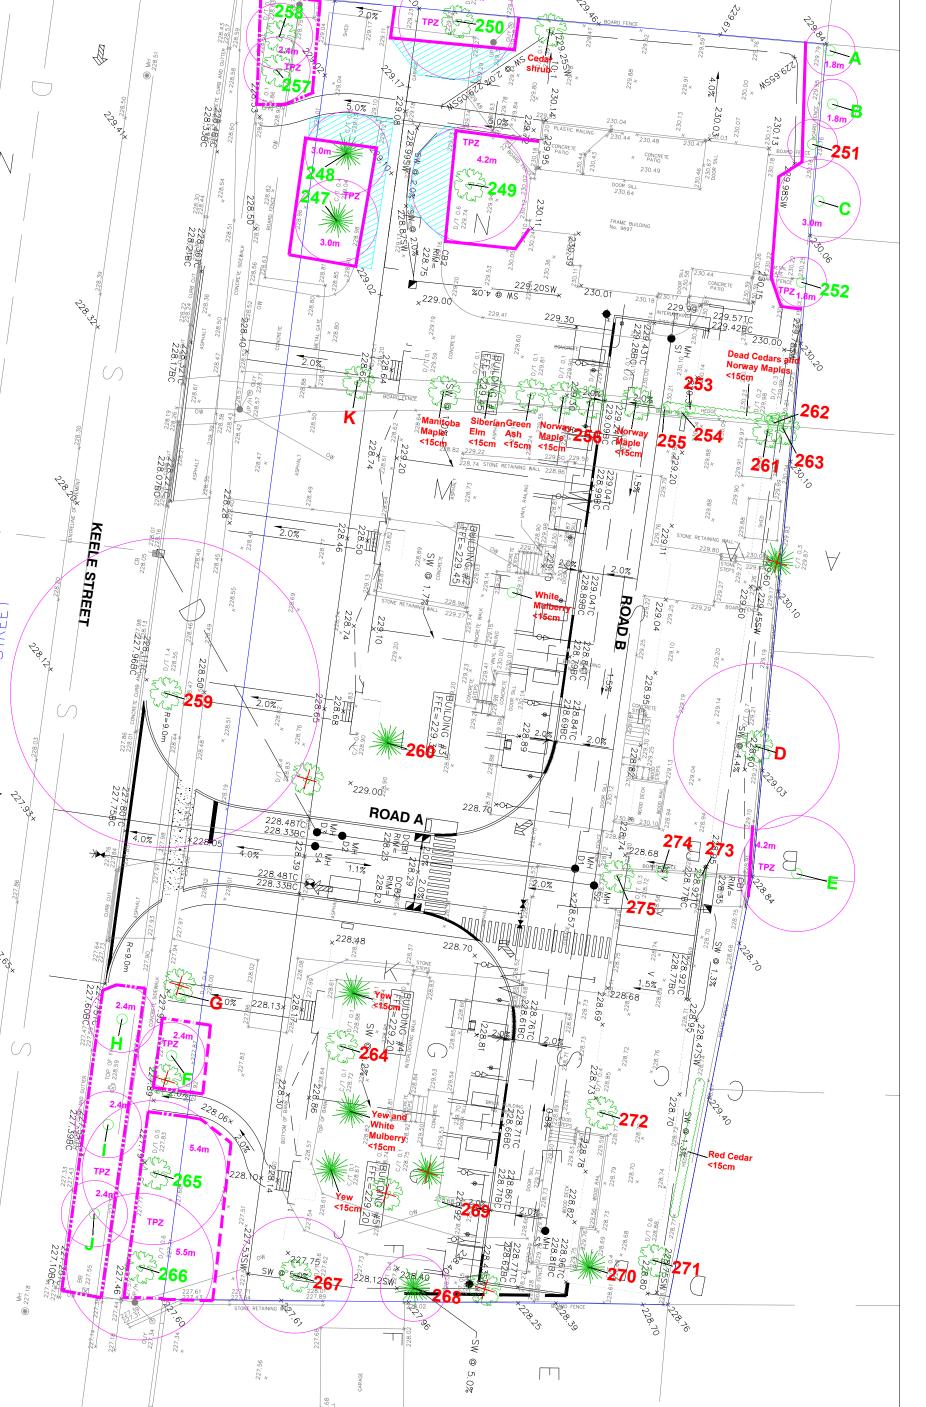

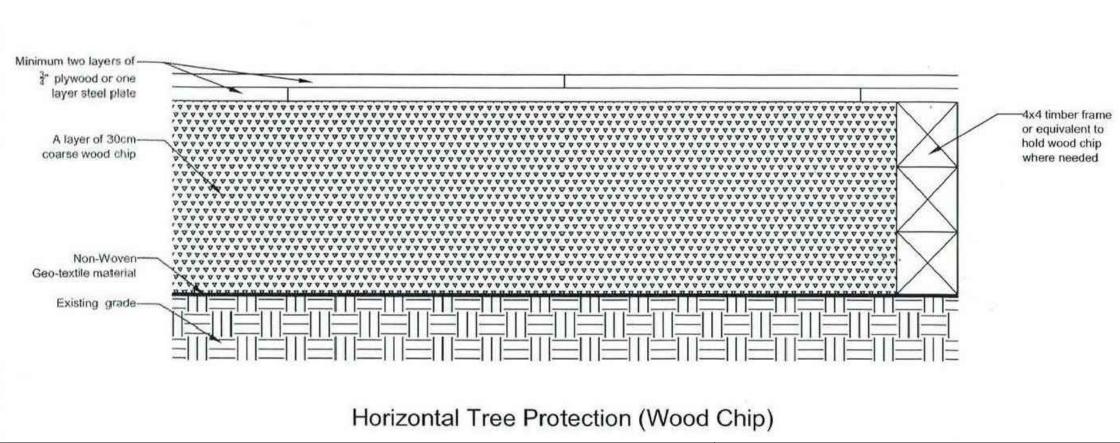

LEGEND

Tree Label (GREEN) preservation recommended

Minimum Tree Preservation Zone (MAGENTA

CIRCLE), with radius in metres from edge of tree

Tree Label (RED) removal required

Tree location estimated by KFCI

Required tree protection fencing (heavy-duty per

Required tree protection fencing (heavy-duty per

NHF-400)

Required tree protection fencing (light-duty per

NHF-400)
Horizontal Hoarding

Tree does not exist

Date By Issue Issue/Revisions CB Report Submission 30 Jan. 2020 CB Report Revisions 18 Feb. 2021 Report Revisions 30 July 2021 CB CB Report Revisions 20 Sept. 2021

Report Revisions

Base Data: Schaeffer Dzaldov Bennett Ltd. (topo), Vulcan Design Inc. (site plan)

27 May 2022

Tree Inventory

Refer to Table 1 of report dated 30 January 2020, revised 27 May 2022 for complete tree inventory information. Tree resources greater than 15cm on and within 6 metres of the subject area, and trees of all sizes within the road right-of-way were included in the inventory.

Tree Removals

The removal of 23 trees is required to accommodate the proposed development as indicated with RED labels.

Tree Preservation

Preservation of all other trees will be possible with appropriate tree protection measures. Trees identified for preservation are indicated with GREEN labels. Minimum Tree Preservation zones and required preservation fencing are indicated with magenta. TPZ circles represent minimum distances for construction and grading near trees.



KUNTZ FORESTRY CONSULTING Inc.

146 Lakeshore Road West
PO Box 1267 Lakeshore W PO
Oakville ON L6K 0B3
t: 289.837.1871
e: consult@kuntzforestry.ca


2777100 Ontario Inc. 18 Erica Road Vaughan, ON L4J 2G1

Property 9675-9697 Keele Street Vaughan, ON

Tree Inventory and Preservation Plan

Project	P2245	Figure
Date	30 January 2020	•
Scale	1:300	

1

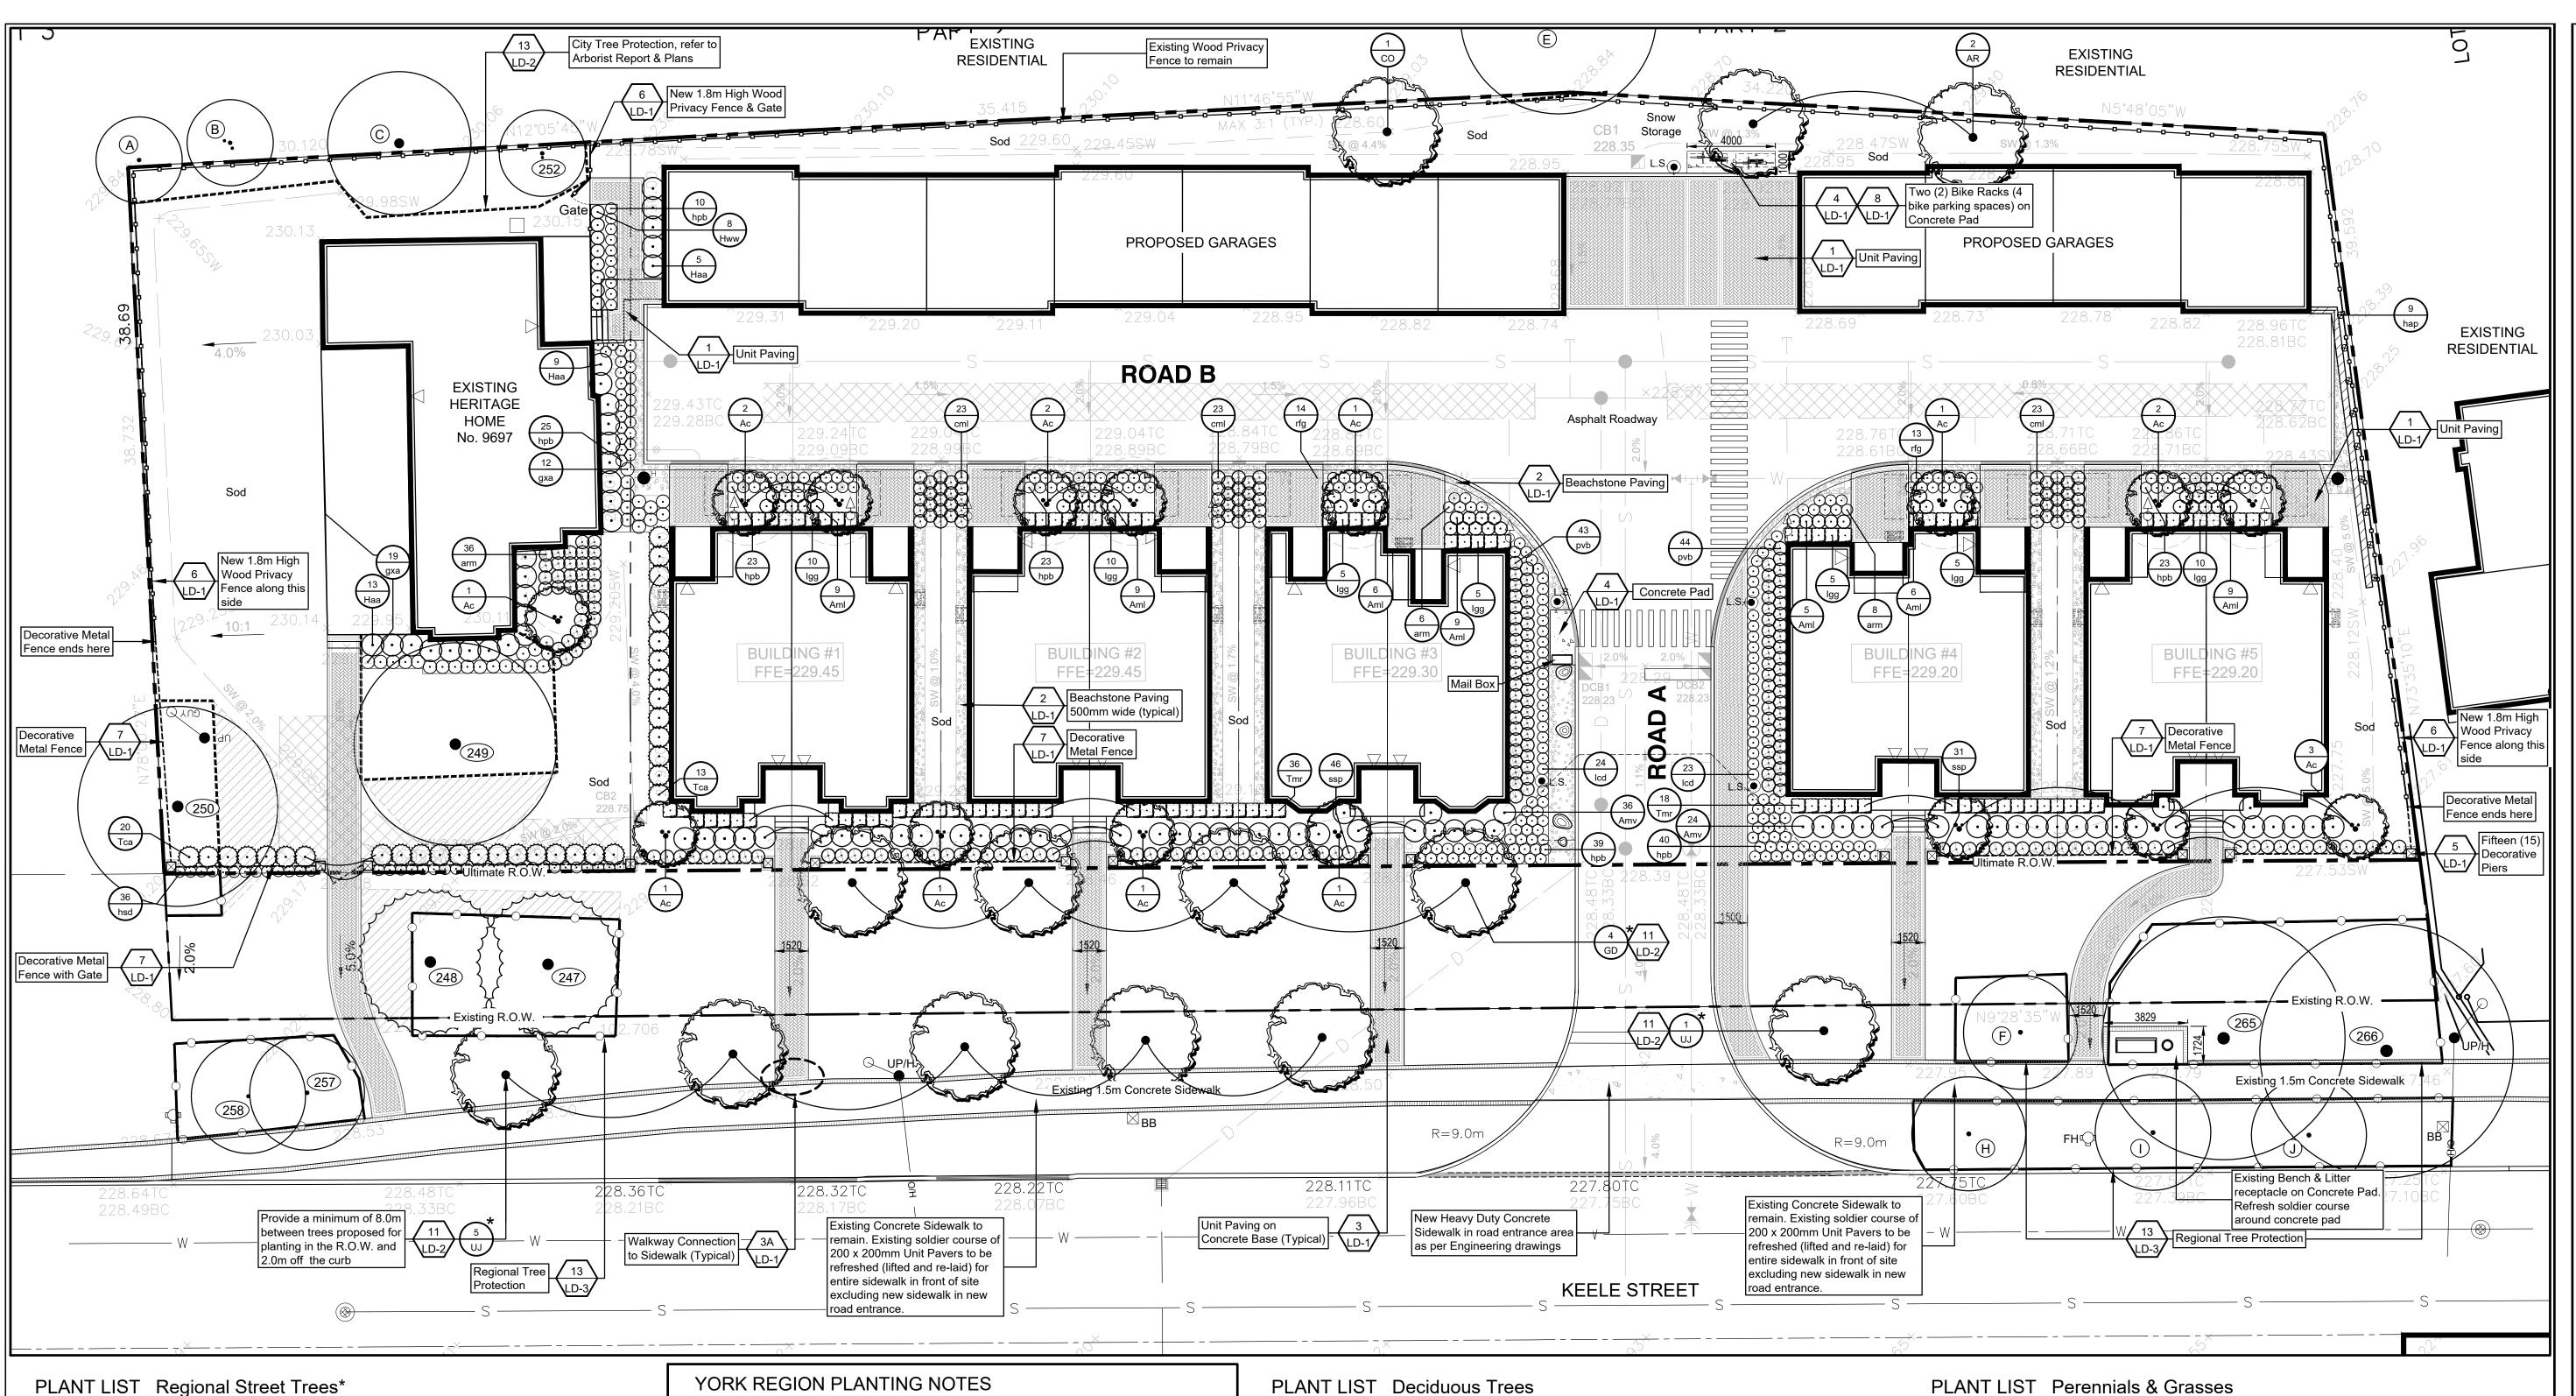

PLANT LIST Regional Street Trees*

FLANT LIST Regional Street Trees						
KEY	BOTANICAL NAME	COMMON NAME	SIZE	CONDITION	COMMENTS	
4 GD	Gymnocladus dioicus	Kentucky Coffee Tree	50mm cal	B&B	Full Form	
6 UJ	Ulmus davidiana var. japonica 'Accolade'	Accolade Elm	50mm cal	B&B	Full Form	

YORK REGION TREE PRESERVATION NOTES

All trees located on the Regional road allowance to be preserved shall conform to the following requirements:

- The Tree Protection Fencing shall not be moved during construction unless with the oversight of a Qualified Arborist.
- The entire dripline of the tree located on the grassed boulevard will be mulched with 6cm
- of mulch prior to the commencement of construction. • A Qualified Arborist must be present for all work within the identified TPZs.
- Root sensitive excavation provisions must be followed when working in the TPZs.
- The Region is to be provided with 24 hours notice prior to working within the TPZs.
- Upon completion of the work within the TPZs, a report is to be provided by a Qualified Arborist identifying how mitigation measures were achieved for each individual tree and any issues that arose during completion of the work.
- After the completion of construction the mulch is to be topped up to 6cm and the trees are to be thoroughly watered ensuring that top 30cm is saturated.

YORK REGION PLANTING NOTES

Trees planted within the Regional Road Allowance shall conform to the following

- a. All trees shall be planted in accordance with the York Region Street Tree Preservation and Planting Design Guidelines.
- b. York Region NHF shall be provided with two (2) weeks notification, notified to schedule a site meeting to review planting layout as well as notification at the completion of tree planting. York Region NHF may inspect the trees post planting and annually to ensure that the trees are planted and maintained in accordance
- identified deficiencies. c. All tree planting shall occur only during the first appropriate planting season immediately following the completion of construction between April 1st and June

with Region standards. The developer shall be responsible for correcting all

- d. Trees shall be subject to a two (2) year warranty period. During that time the developer shall warranty the trees against mortality from any biotic and abiotic
- factor, and/or as a result of incorrect planting or maintenance procedures.
- e. All trees shall be watered a minimum of fourteen (14) times per year throughout
- the growing season for the duration of the two (2) year warranty period. At the end of the two (2) year warranty all gator bags and stakes are to be removed
- and the mulch is to be added in accordance with the specifications. Any damage which occurs to the existing asphalt walkway, roadway, curb & gutter due to construction shall be restored to its original or better condition at the
- Owner's expense. h. Removal all existing pavement and granular base to a depth no less than 1.0 meter as required for areas in the right-of-way where trees are to be planted and which were previously compacted or had hard paved surfacing. Excavated areas are to be backfilled with OPSS 802 construction specified topsoil in order to improve root development and long term survival of newly planted trees. See Removal of Existing Vehicular Entrances.
- All disturbed areas within the right-of-way are to be fine graded with 200mm of topsoil and sodded.

PLANT LIST Deciduous Trees

KEY	BOTANICAL NAME	COMMON NAME	SIZE	CONDITION	COMMENTS
2	Acer rubrum	Red Maple	60mm cal.	W.B.	Full Form
AR					
1	Celtis occidentalis	Hackberry	60mm Cal.	W.B.	FULL FORM
<u></u>					

PLANTLIST Shrubs

	VI LIST SHRUDS				
KEY	BOTANICAL NAME	COMMON NAME	SIZE	CONDITION	COMMENTS
16 Ac	Amelanchier canadensis	Serviceberry	250cm	W.B.	Clump
53 Aml	Aronia melanocarpa "Low Scape Mound"	Low Scape Mound Chokeberry	40cm	3 gal	Full Form
60 Amv	Aronia melanocarpa "Viking"	Viking Black Chokeberry	60cm	3 gal	Full Form
27 Haa	Hydrangea arborescens "Abetwo"	Incrediball Hydrangea	60cm	3 gal	Full Form
8 Hww	Hydrangea arborescens "Invincibelle Wee White"	Invincibelle Wee White Hydrangea	40cm	2 gal.	Full Form
50 lgg	Ilex glabra 'Gem Box'	Gem Box Inkberry	60cm	3 gal	Full Form
33 Tca	Taxus canadensis	Canadian Yew	50cm	2 gal.	Full Form
54 Tmr	Taxus x media 'Rising Star'	Rising Star Yew	60cm	3 gal	Full Form

KEY	BOTANICAL NAME	COMMON NAME	SIZE	CONDITION	COMMENTS
50 arm	Aruncus x 'Misty Lace'	Misty Lace Dwarf Goat's Beard	1 gal	Pot	Full Form
69 cml	Carex muskinqumensis 'Little Midge'	Little Midge Palm Sedge	1 gal	Pot	Full Form
31 gxa	Geranium x 'Azure Rush'	Azure Rush Cranesbill	1 gal	Pot	Full Form
9 hap	Hydrangea anomala petiolaris	Climbing Hydrangea	3 gal	Pot	Staked
183 hpb	Hemerocallis 'Pandora's Box'	Pandora's Box Daylily	1 gal	Pot	Full Form
36 hsd	Hemerocallis "Stella D'Oro"	Stella D'Oro Daylily	1 gal	Pot	Full Form
47 Icd	Leucanthemum x superbum 'Crazy Daisy'	Crazy Daisy Shasta Daisy	1 gal	Pot	Full Form
87 pvb	Panicum virgatum 'Blood Brothers'	Blood Brothers Switch Grass	1 gal	Pot	Full Form
27 rfg	Rudbeckia fulgida 'Goldstrum'	Goldstrum Black-Eyed Susan	1 gal	Pot	Full Form
77 ssp	Schizachyrium scoparium 'Prairie Blues"	Prairie Blues Little Bluestem	1 gal	Pot	Full Form
	•	1		•	

consultants



Deciduous Tree



Masonry Columns 1.8m High Wood Privacy Fence

Shrubs, Annuals & Grasses



Region Tree Protection, see details on LD-3 ----- City Tree Protection, see detail 13 on LD-2

Areas of Horizontal Hoarding

See Tree Inventory and Preservation Plan & Report by Kuntz Forestry Consulting Inc. dated 30 January 2020 revised 18 February 2021 and 30 July 2021 for further information and Tree Preservation measures required

	SITE PLAN RESUBMISSION	1 Dec 2022	
1	Revised as per comments from Urban Design	14 Oct 2022	D.S.
	SITE PLAN RESUBMISSION	7 June 2022	
	SITE PLAN RESUBMISSION	16 Nov 2021	
no	revision	date	by

THESE DRAWINGS ARE THE PROPERTY OF MARK SETTER ASSOCIATES LTD AND SHALL NOT BE ALTERED, MODIFIED, REVISED OR CHANGED WITHOUT THE WRITTEN CONSENT OF MARK SETTER ASSOCIATES LTD. ALL DIMENSIONS ARE TO BE VERIFIED ON SITE AND ANY DISCREPANCIES ARE TO BE REPORTED TO THE LANDSCAPE ARCHITECT.





219 Lake Drive East, Keswick, Ontario, L4P 3E9 tel: 905.476.0844 email: msetter@rogers.com website: marksetterassociates.com

reviewed by

drawn by

October 2020

scale 1:150

drawing title

Landscape Plan


drawing number

L-1

Residential Development 9675-9697 Keele Street, Vaughan, Ontario

project number 2020-002

City File No. DA.20.044, 19T-20V003, 19CDM-20V007 & Z.20.025 Region File No. SP.20.V.0020

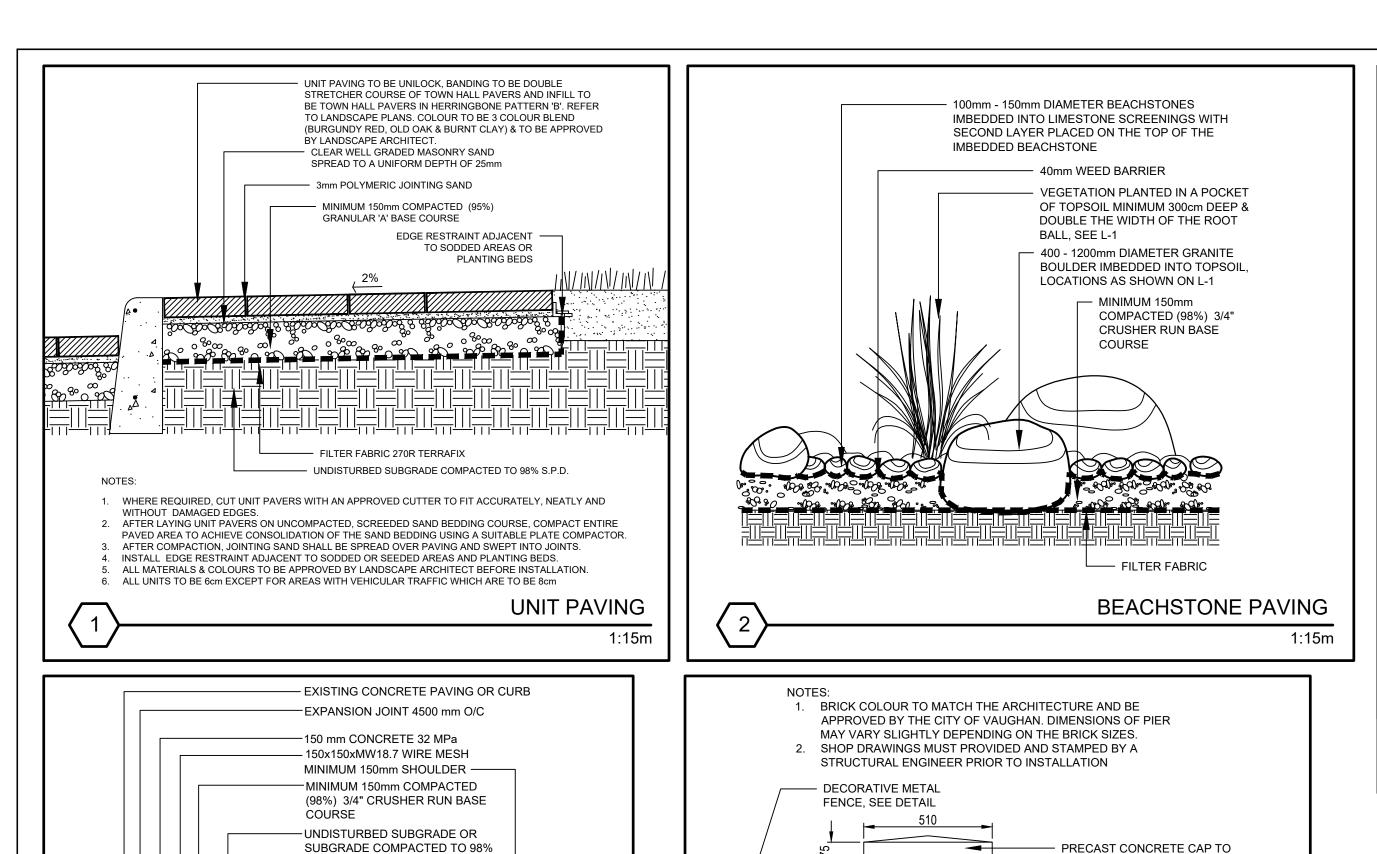

MATCH ARCHITECTURE

PROVIDED

NO PART OF ANY PROPOSED COLUMNS,

WHETHER ABOVE OR BELOW GRADE, SHALL

EXTEND INTO YORK REGION'S RIGHT-OF-WAY

BRICK QUOINS - MERIDIAN CANADIAN

COLLECTION, COLOUR: ROCKCLIFFE

PIN MOUNTED BRASS UNIT NUMBER

(STREET NUMBER FOR HERITAGE

HOUSE). SHOP DRAWINGS TO BE

COLLECTION, COLOUR: CAVENDISH II

DECORATIVE PIER

BRICK - MERIDIAN CANADIAN

- WALL MOUNT BRACKETS, SUPPLIED BY MANUFACTURER

S.P.D.

0.5% AT 28 DAYS WITH 6% AIR ENTRAINMENT

DIRECTION OF WALKWAY.

NOTES:

FILTER FABRIC

CONCRETE TO BE 32 MPa CLASS "A" CONCRETE, MAX. CEMENT / WATER RATIO

PROVIDE A SURFACE CROSS SLOPE OR CROWN 2% TO SHED WATER AS REQUIRED

CONCRETE PAD


CONTROL JOINT EVERY 2.5 METRES OR AS SHOWN IN LANDSCAPE PLANS CONCRETE SURFACE TO HAVE A LIGHT BROOM FINISH PERPENDICULAR TO


ALL SUBGRADE & SUB-BASE SHOULD BE REVIEWED AND ASSESSED BY

GEO-TECHNICAL ENGINEER. REFER TO GEOTECHNICAL REPORT.

TERRAFIX 270R GEOTEXTILE

-CONTROL JOINT 1500mm O/C

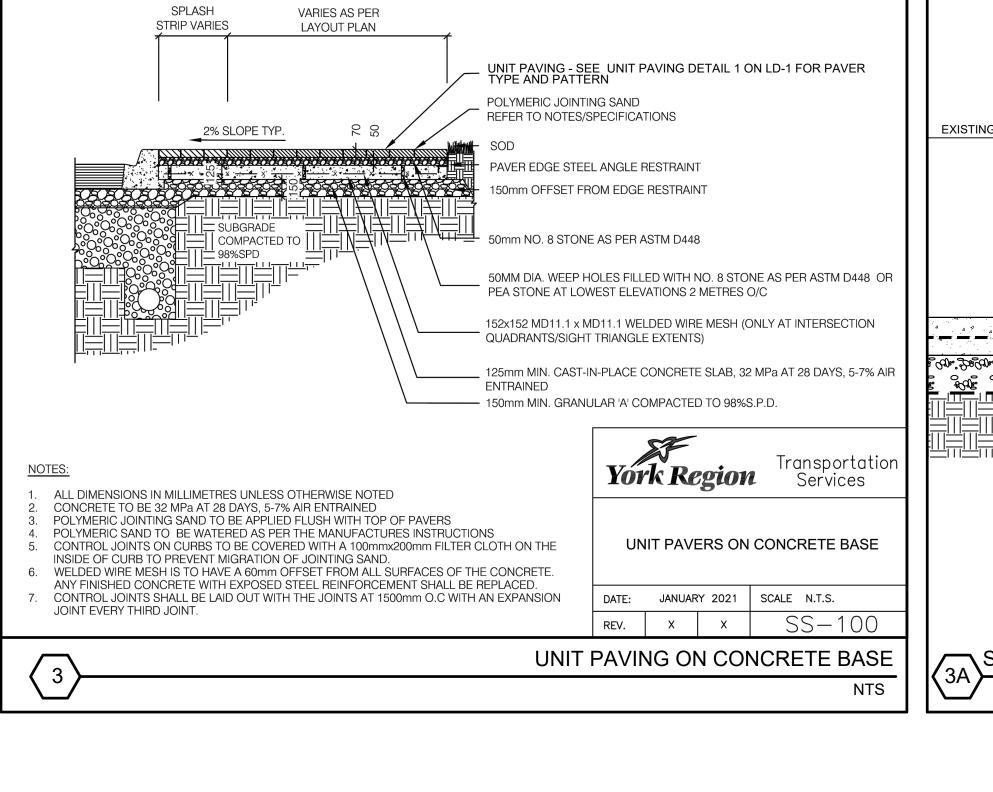

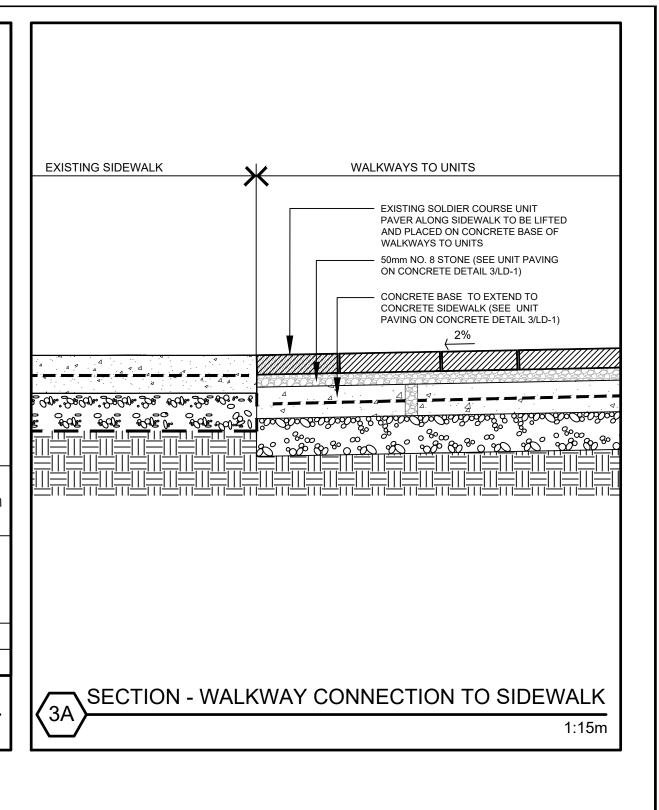



client

consultants

THESE DRAWINGS ARE THE PROPERTY OF MARK SETTER ASSOCIATES LTD AND SHALL NOT BE ALTERED, MODIFIED, REVISED OR CHANGED WITHOUT THE WRITTEN CONSENT OF MARK SETTER ASSOCIATES LTD. ALL DIMENSIONS ARE TO BE VERIFIED ON SITE AND ANY DISCREPANCIES ARE TO BE REPORTED TO THE LANDSCAPE ARCHITECT.





tel: 905.476.0844 email: msetter@rogers.com

website: marksetterassociates.com

reviewed by

drawn by **K**.F.

M.S.

date
October 2020

scale **As Shown**

drawing title

Landscape Details & Notes

drawing number


<u>LD-1</u>


ect title


Residential Development 9675-9697 Keele Street, Vaughan, Ontario


project number 2020-002


City File No.DA.20.044, 19T-20V003, 19CDM-20V007 & Z.20.025 Region File No. SP.20.V.0020

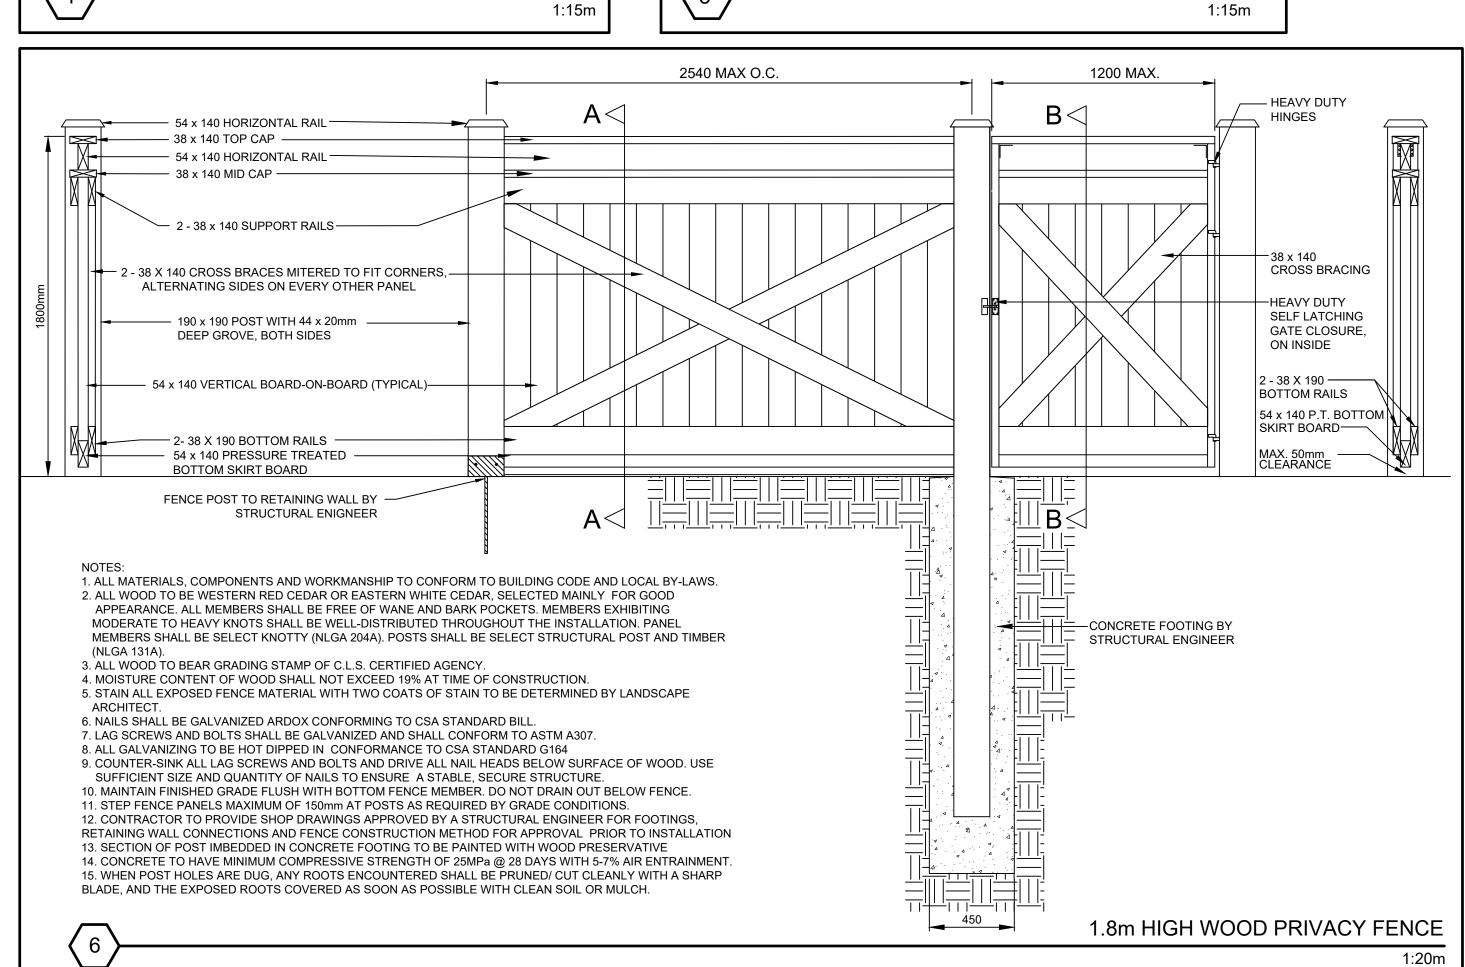


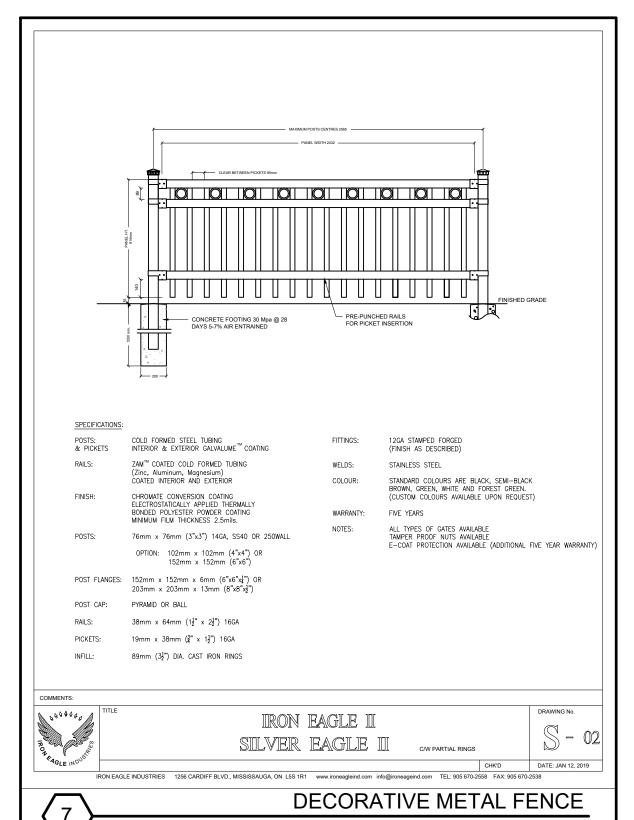


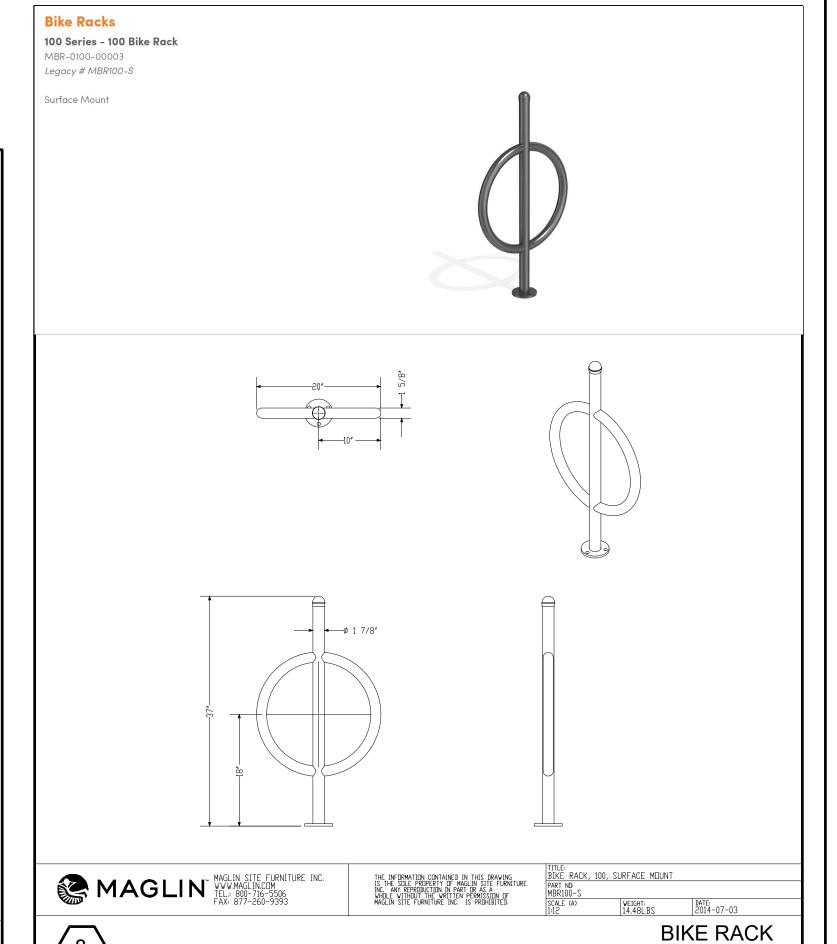


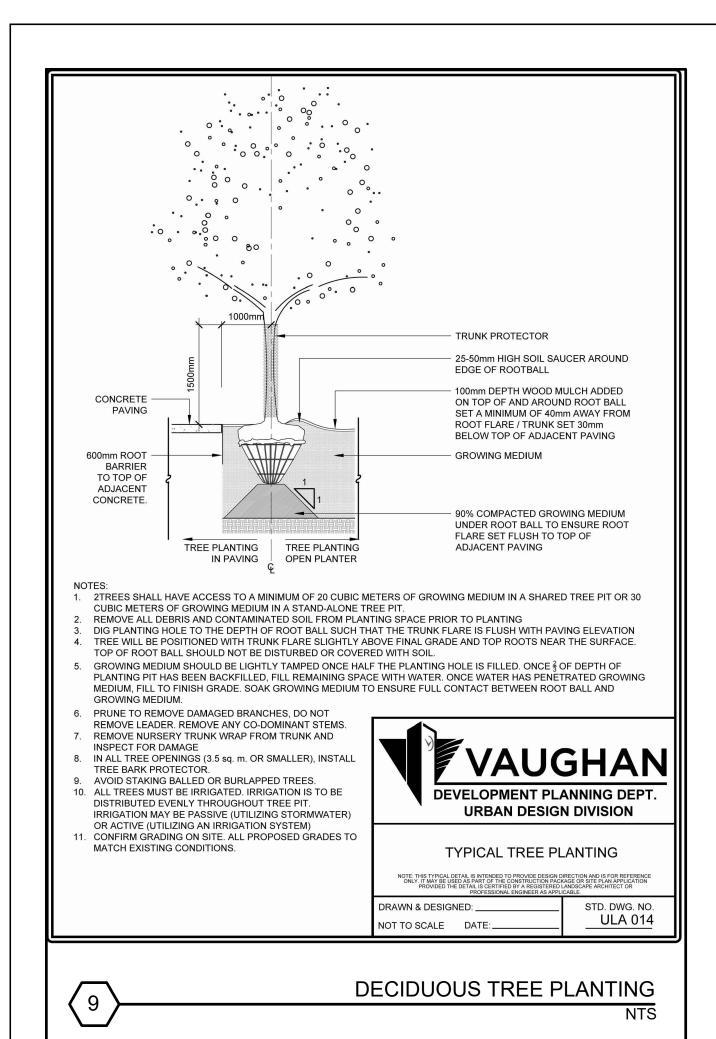

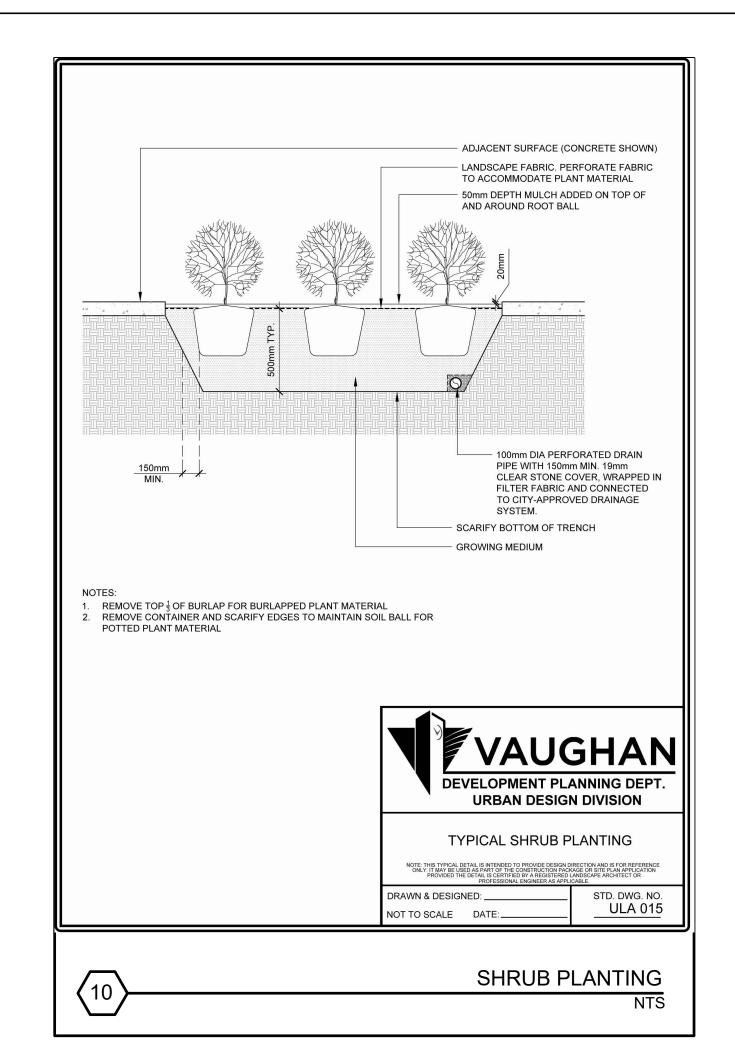

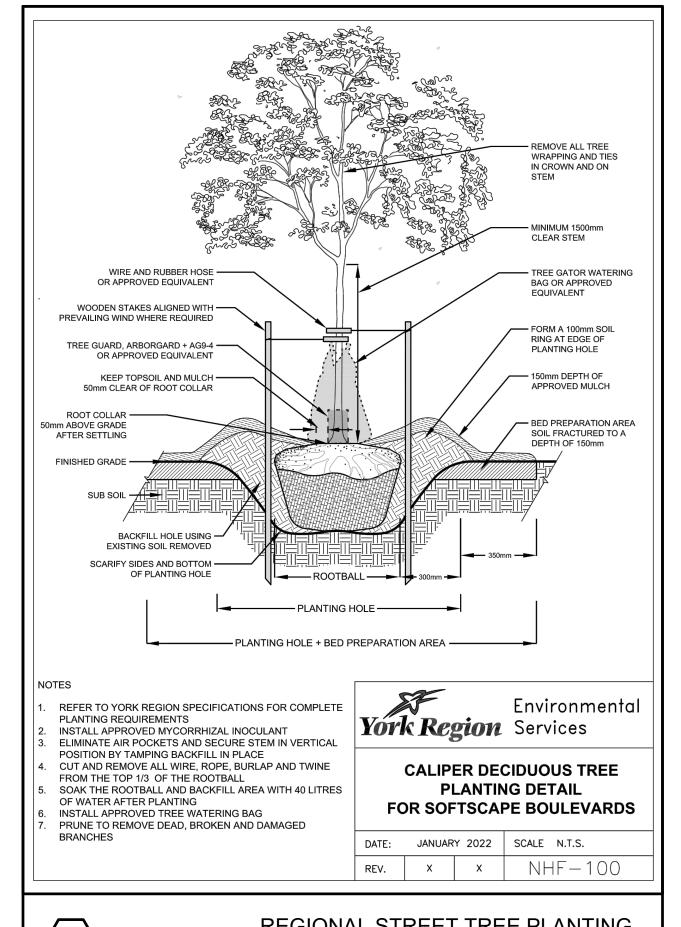

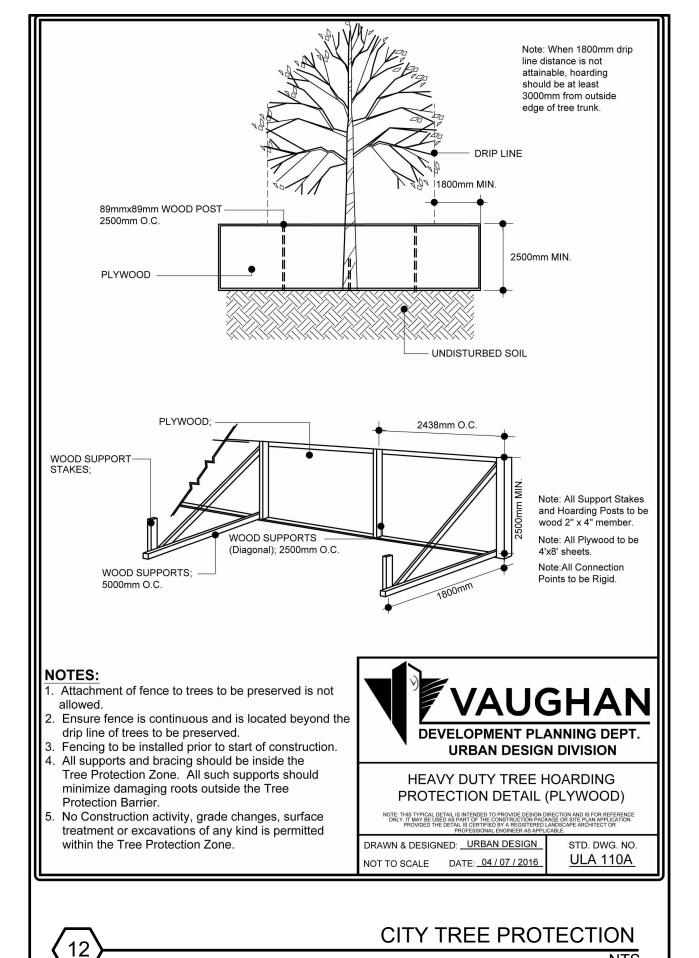

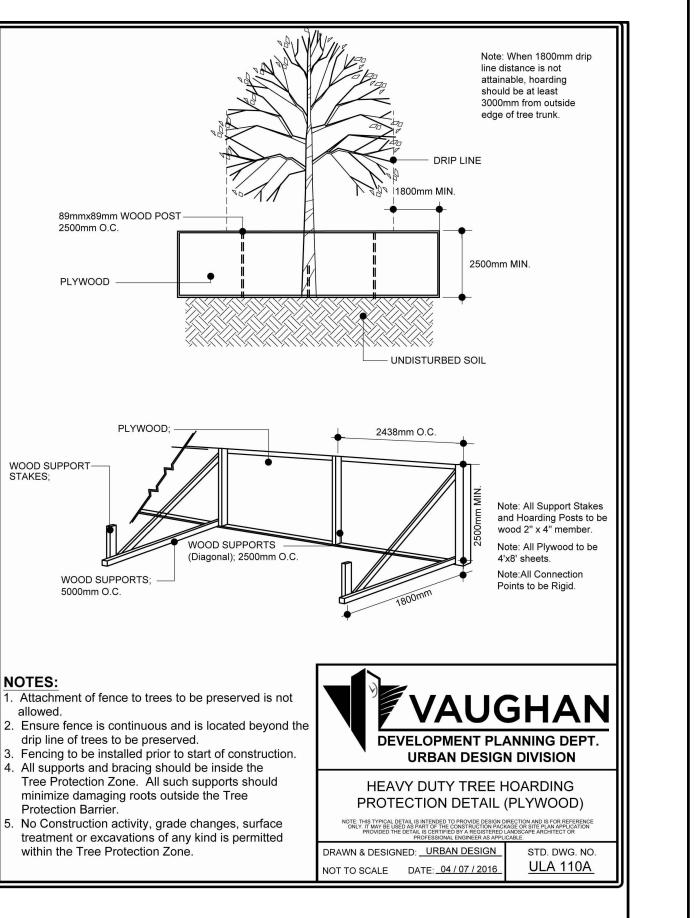

SITE PLAN RESUBMISSION 1 Dec 2022 Revised as per comments from 14 Oct 2022 Urban Design SITE PLAN RESUBMISSION 7 June 2022 SITE PLAN RESUBMISSION 16 Nov 2021 date by no revision

client

consultants

THESE DRAWINGS ARE THE PROPERTY OF MARK SETTER ASSOCIATES LTD AND SHALL NOT BE ALTERED, MODIFIED, REVISED OR CHANGED WITHOUT THE WRITTEN CONSENT OF MARK SETTER ASSOCIATES LTD. ALL DIMENSIONS ARE TO BE VERIFIED ON SITE AND ANY DISCREPANCIES ARE TO BE REPORTED TO THE LANDSCAPE ARCHITECT.





219 Lake Drive East, Keswick, Ontario, L4P 3E9 tel: 905.476.0844 email: msetter@rogers.com website: marksetterassociates.com

reviewed by M.S.

drawn by

October 2020

scale As Shown

drawing title Landscape Details & Notes


LD-2


drawing number


Residential Development 9675-9697 Keele Street, Vaughan, Ontario


project number 2020-002


City File No. DA.20.044, 19T-20V003, 19CDM-20V007 & Z.20.025 Region File No. SP.20.V.0020

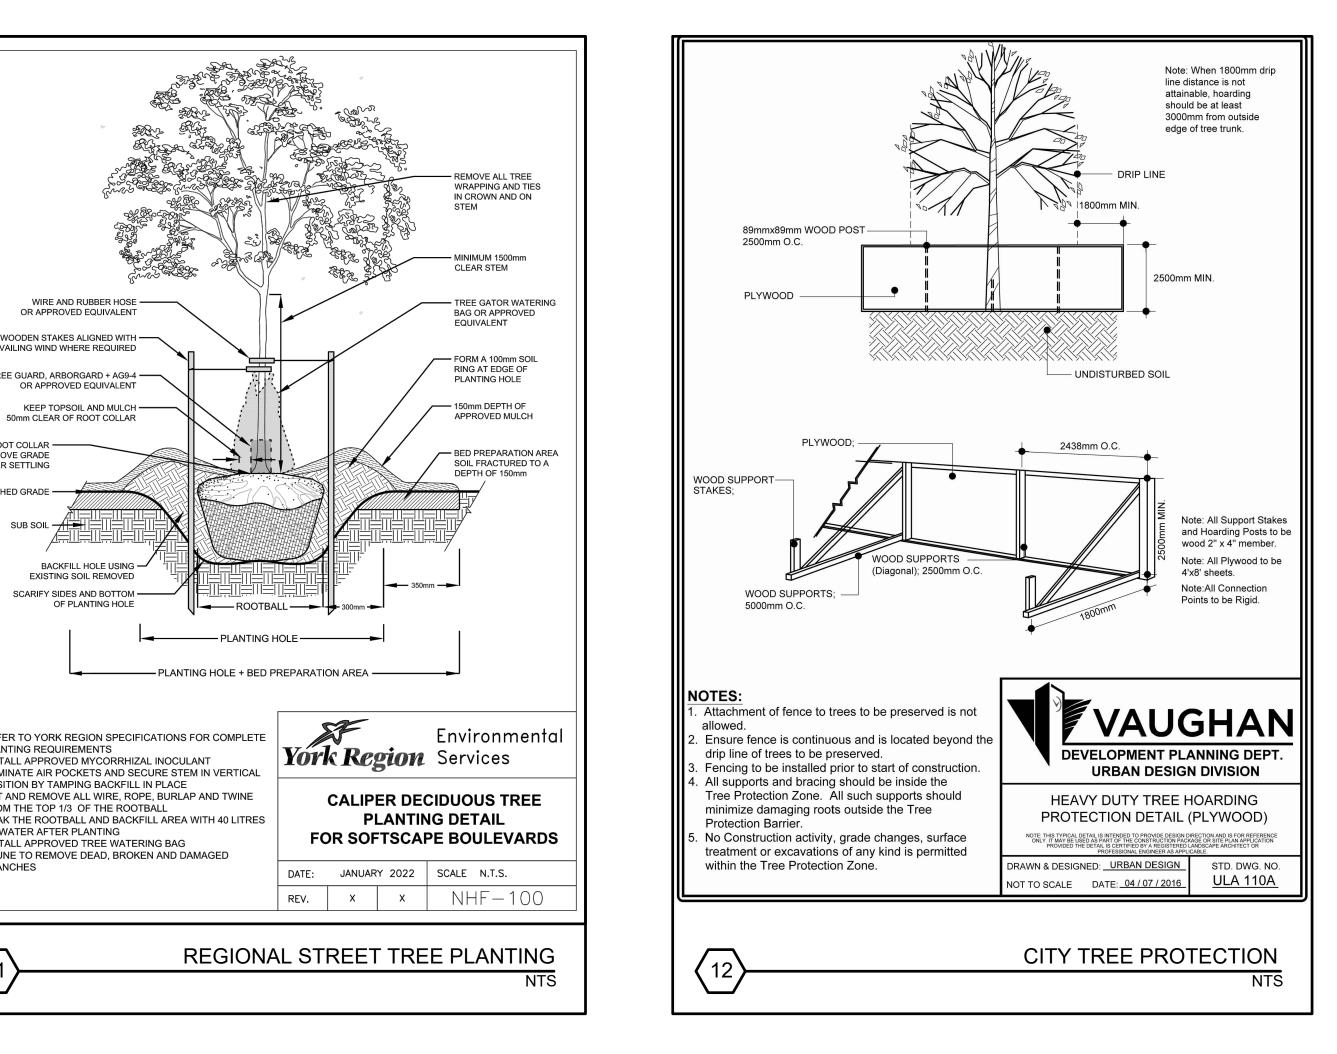


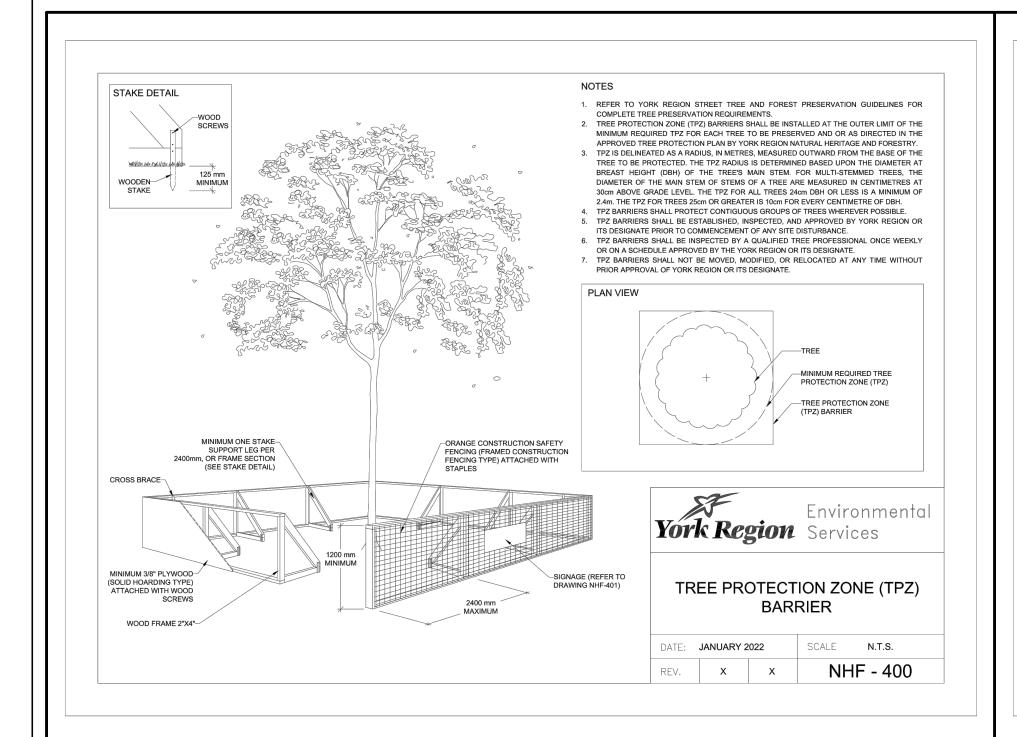


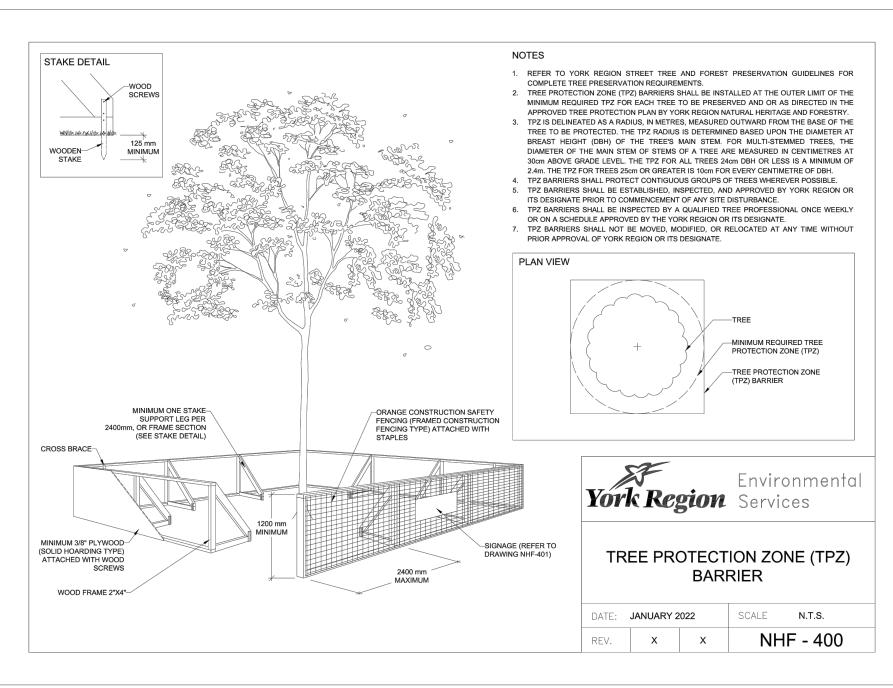

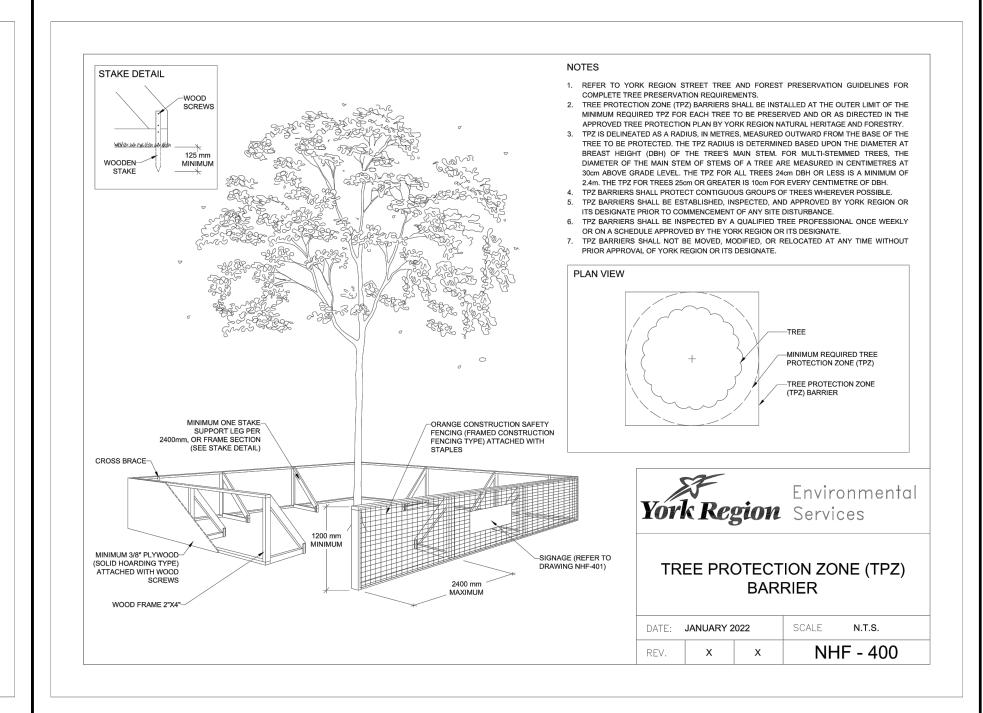

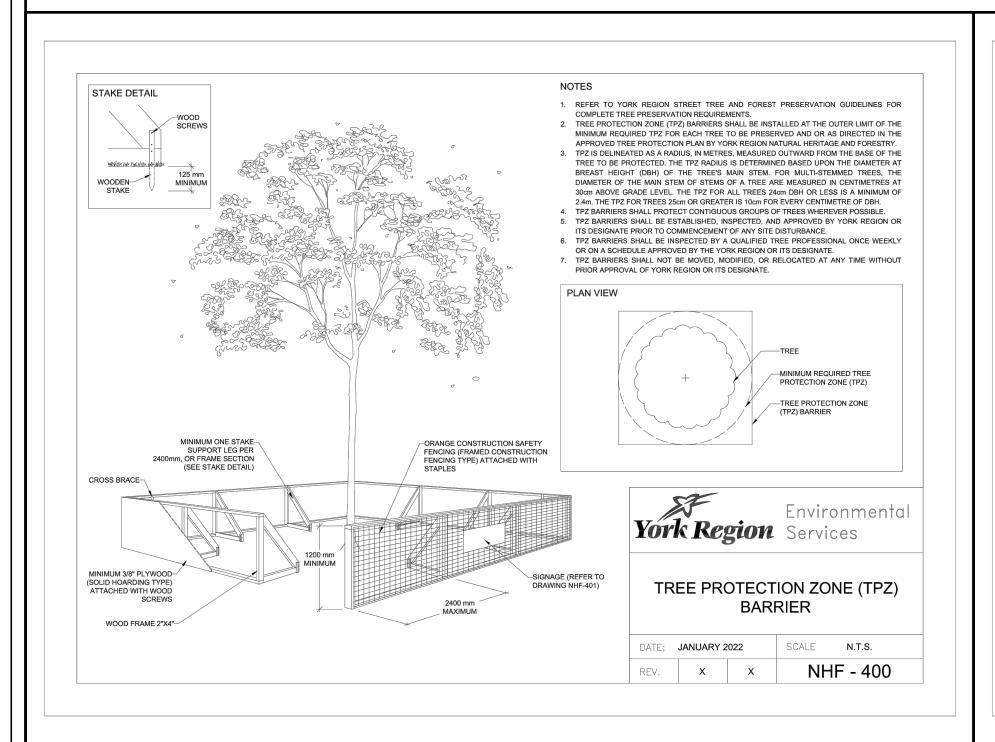

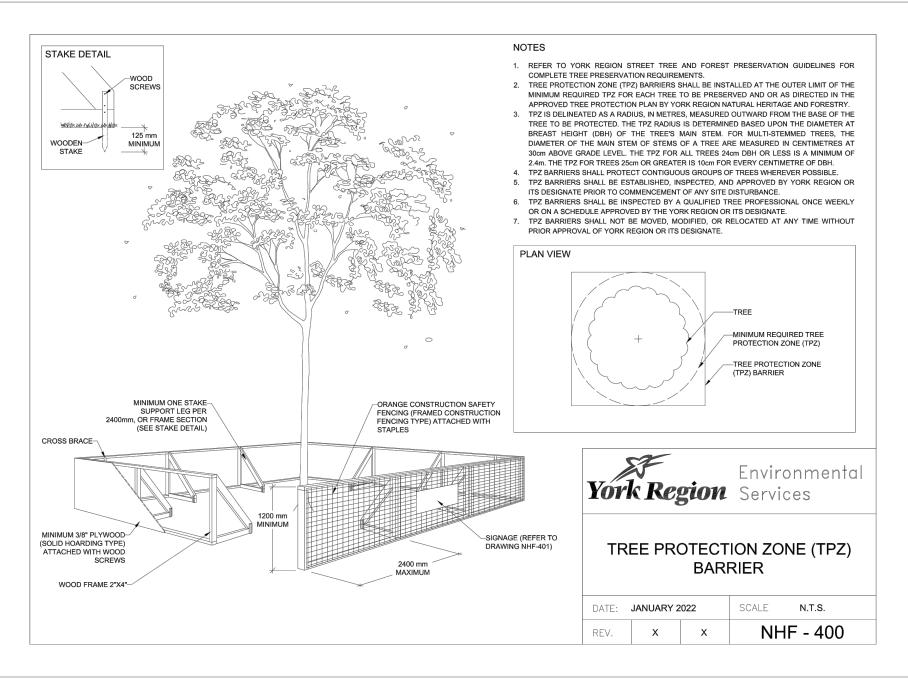

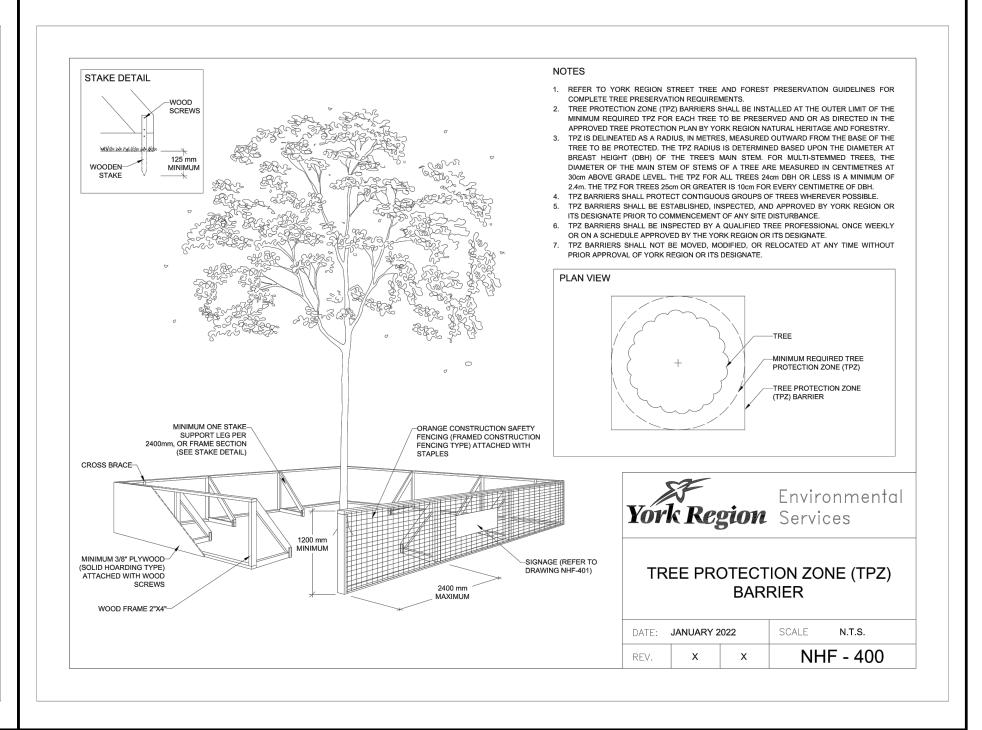

TREE PROTECTION

client

consultants

	SITE PLAN RESUBMISSION	1 Dec 2022	
1	Revised as per comments from Urban Design	14 Oct 2022	D.S.
	SITE PLAN RESUBMISSION	7 June 2022	
	SITE PLAN RESUBMISSION	16 Nov 2021	

date by

THESE DRAWINGS ARE THE PROPERTY OF MARK SETTER ASSOCIATES LTD AND SHALL NOT BE ALTERED, MODIFIED, REVISED OR CHANGED WITHOUT THE WRITTEN CONSENT OF MARK SETTER ASSOCIATES LTD. ALL DIMENSIONS ARE TO BE VERIFIED ON SITE AND ANY DISCREPANCIES ARE TO BE REPORTED TO THE LANDSCAPE ARCHITECT.

no revision





website: marksetterassociates.com

reviewed by

M.S.

drawn by

date October 2020

scale As Shown

drawing title Landscape Details & Notes

drawing number

LD-3

Residential Development 9675-9697 Keele Street, Vaughan, Ontario

project number 2020-002

City File No. DA.20.044, 19T-20V003, 19CDM-20V007 & Z.20.025 Region File No. SP.20.V.0020